

COMMONWEALTH OF MASSACHUSETTS DEPARTMENT OF CONSERVATION AND RECREATION DIVISION OF PLANNING AND ENGINEERING

MASS CENTRAL RAIL TRAIL
IN THE TOWNS OF HUDSON, STOW, MARLBOROUGH & SUDBURY
MASSACHUSETTS
MIDDLESEX COUNTY


THESE PLANS ARE SUPPLEMENTED BY THE OCTOBER 2017 CONSTRUCTION STANDARD DETAILS, THE 2015 OVERHEAD SIGNAL STRUCTURE AND FOUNDATION STANDARD DRAWINGS, MASSDOT TRAFFIC MANAGEMENT PLANS AND DETAIL DRAWINGS, THE 1990 STANDARD DRAWINGS FOR SIGNS AND SUPPORTS, THE 1968 STANDARD DRAWINGS FOR TRAFFIC SIGNALS AND HIGHWAY LIGHTING, AND THE LATEST EDITION OF THE AMERICAN STANDARD FOR NURSERY STOCK.

DCR CONTRACT NO. P19-3295-D1A

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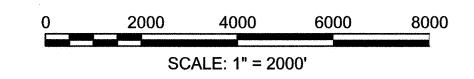
(NOT INCLUDED)



CHARLES D. BAKER, GOVERNOR KARYN E. POLITO, LT. GOVERNOR

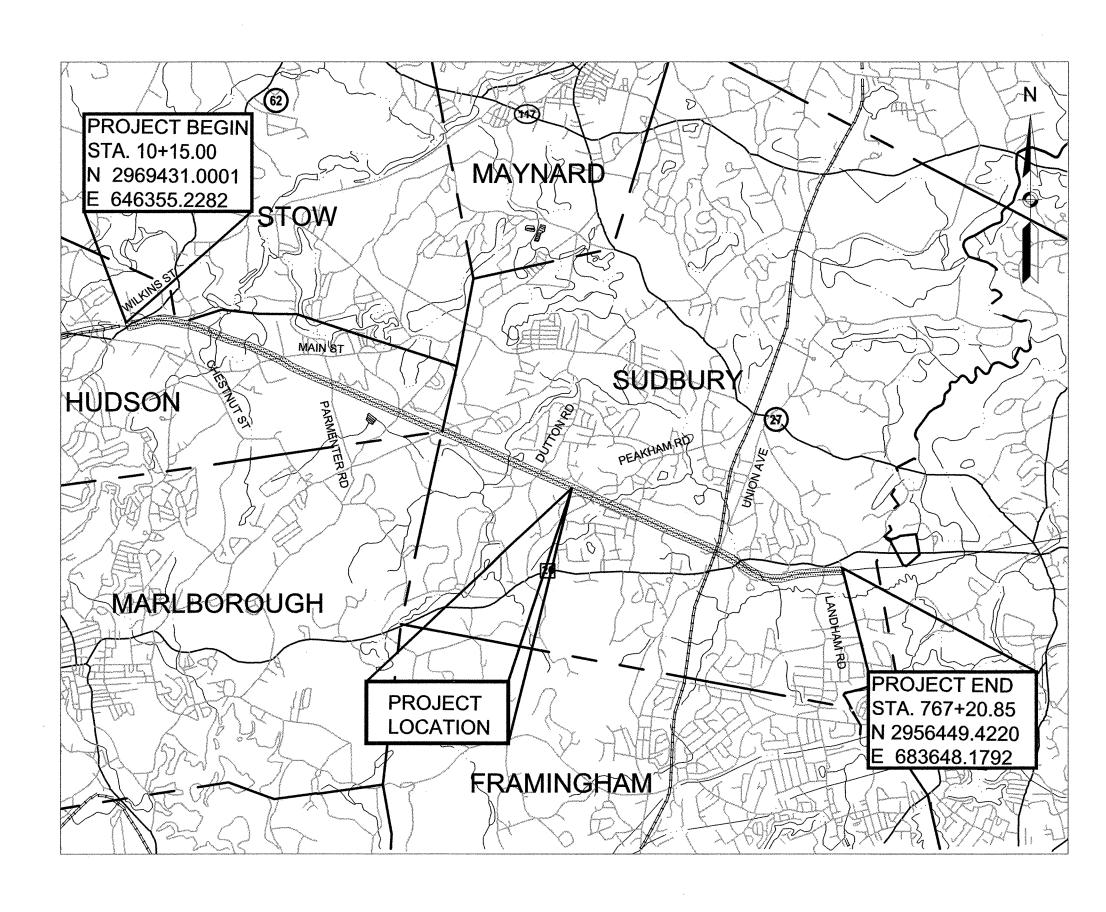KATHLEEN A. THEOHARIDES, SECRETARY
EXECUTIVE OFFICE OF ENERGY & ENVIRONMENTAL AFFAIRS

JIM MONTGOMERY, INTERIM COMMISSIONER
DEPARTMENT OF CONSERVATION & RECREATION



LENGTH OF PROJECT = 40,410.06 FEET = 7.653 MILES

SUDBURY STORMWATER PERMIT PLANS NOT APPROVED FOR CONSTRUCTION



101 Walnut St., P.O. Box 9151

617 924 1770 FAX 617 924 2286

COMMONWEALTH OF MASSACHUSETTS
DEPARTMENT OF CONSERVATION AND RECREATION
DIVISION OF PLANNING AND ENGINEERING

MASS CENTRAL RAIL TRAIL - WAYSIDE

MASS CENTRAL RAIL TRAIL HUDSON, STOW, MARLBOROUGH & SUDBURY, MA

DESIGNER JCR	TITLE SHEET	SHEET NO.	
CHECKED: SHK			G-01
DRAWN: JCR	CONT. P19-3295-D1A	SCALE: AS NOTED	G-01
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OFNEDAL O	VMDOL C			
GENERAL S			ABBREV	IATIONS
EXISTING	PROPOSED	DESCRIPTION	GENERAL	
☐ JB	JB	JERSEY BARRIER	AADT	ANNUAL AVERAGE DAILY TRAFFIC
⊞⊕⊞св	■ CB	CATCH BASIN	ABAN	ABANDON
		CATCH BASIN CURB INLET	ADJ	ADJUST
♥ FP © GP	♥ FP G GP	FLAG POLE GAS PUMP	APPROX.	APPROXIMATE
□ MB	□ MB	MAIL BOX	A.C.	ASPHALT CONCRETE
		POST SQUARE	ACCM PIPE BIT.	ASPHALT COATED CORRUGATED METAL PIPE BITUMINOUS
0	Ō	POST CIRCULAR	BC	BOTTOM OF CURB
⊕ WELL	⊕ WELL	WELL	BD.	BOUND
- EHH	- EHH	ELECTRIC HANDHOLE	BL	BASELINE
0	0	FENCE GATE POST	BLDG	BUILDING
O GG	O GG → BHL#	GAS GATE	BM	BENCHMARK
⊕ BHL # ⊕ MW #	◆ BHL # ◆ MW #	BORING HOLE MONITORING WELL	ВО	BY OTHERS
TP #	Ψ WW#	TEST PIT	BOS BR.	BOTTOM OF SLOPE BRIDGE
φ "	P	HYDRANT	CB	CATCH BASIN
*	*	LIGHT POLE	CBCI	CATCH BASIN WITH CURB INLET
■CB ■CB/DH		CONCRETE BOUND/DRILL HOLE	CC	CEMENT CONCRETE
		GPS POINT	CCM	CEMENT CONCRETE MASONRY
©	©	CABLE MANHOLE	CEM	CEMENT
(b)	(a)	DRAINAGE MANHOLE	CI	CURB INLET
(E) (G)	(E) (G)	ELECTRIC MANHOLE GAS MANHOLE	CIP	CAST IRON PIPE
(M)	₩	MISC MANHOLE	CLF CL	CHAIN LINK FENCE CENTERLINE
<u>s</u>	<u>©</u>	SEWER MANHOLE	CMP	CORRUGATED METAL PIPE
T	T	TELEPHONE MANHOLE	CSP	CORRUGATED STEEL PIPE
W	w	WATER MANHOLE	CO.	COUNTY
■ MHB	■ MHB	MASSACHUSETTS HIGHWAY BOUND	CONC	CONCRETE
□ MON		MONUMENT	CONT	CONTINUOUS
□ SB		STONE BOUND	CONST	CONSTRUCTION
■ TB		TOWN OR CITY BOUND TRAVERSE OR TRIANGULATION STATION	CR GR DHV	CROWN GRADE DESIGN HOURLY VOLUME
⊸ TPL or GUY	→ TPL or GUY	TROLLEY POLE OR GUY POLE	DI	DROP INLET
• HTP	11 2 01 001	TRANSMISSION POLE	DIA	DIAMETER
-6- UFB	-&- UFB	UTILITY POLE W/ FIREBOX	DIP	DUCTILE IRON PIPE
-Ş- UPDL	-∳- UPDL	UTILITY POLE WITH DOUBLE LIGHT	DW	STEADY DON'T WALK - PORTLAND ORANGE
-6- ULT	_&_ ULT	UTILITY POLE W / 1 LIGHT	DWY	DRIVEWAY
-O- UPL	-∽ UPL	UTILITY POLE	ELEV (or EL.)	ELEVATION
0		BUSH	EMB EOP	EMBANKMENT EDGE OF PAVEMENT
•SIZE & TYPE O		TREE STUMP	EXIST (or EX)	EXISTING
<u> 4</u>		SWAMP / MARSH	EXC	EXCAVATION
		WETLAND FLAG	F&C	FRAME AND COVER
• WG	• WG		F&G	FRAME AND GRATE
• PM	• PM	PARKING METER	FDN.	FOUNDATION
		OVERHEAD CABLE/WIRE	FLDSTN	FIELDSTONE
			GAR GD	GARAGE GROUND
		- CONTOURS (ON-THE-GROUND SURVEY DATA) - CONTOURS (PHOTOGRAMMETRIC DATA)	GG GG	GAS GATE
<u> 12" RCP</u>		- UNDERGROUND DRAIN PIPE (DOUBLE LINE 24 INCH AND OVER)	GI	GUTTER INLET
——— E ———		- UNDERGROUND ELECTRIC DUCT (DOUBLE LINE 24 INCH AND OVER)	GIP	GALVANIZED IRON PIPE
<u>4" HP</u> G ———		- UNDERGROUND GAS MAIN (DOUBLE LINE 24 INCH AND OVER)	GRAN	GRANITE
_8" VCP S		- UNDERGROUND SEWER MAIN (DOUBLE LINE 24 INCH AND OVER)	GRAV	GRAVEL
		- UNDERGROUND TELEPHONE DUCT (DOUBLE LINE 24 INCH AND OVER)	GRD	GUARD
<u>8" C.I.</u> W		- UNDERGROUND WATER MAIN (DOUBLE LINE 24 INCH AND OVER)	HDW HMA	HEADWALL HOT MIX ASPHALT
			HOR	HORIZONTAL
		- GUARD RAIL - STEEL POSTS - WOOD GUARD RAIL	HYD	HYDRANT
X	x	- WOOD GOARD RAIL - CHAIN LINK OR METAL FENCE	INV	INVERT
		- WOOD FENCE	JCT	JUNCTION
~~~~~~~~~~~~~~~~~~~~~~~~~~~~~~~~~~~~~~	~~~~~~~~~~~~~~~~~~~~~~~~~~~~~~~~~~~~~~	TREE LINE	L	LENGTH OF CURVE
		- SAWCUT LINE	LB LP	LEACH BASIN LIGHT POLE
		- TOP OR BOTTOM OF SLOPE	LST	LANDSCAPE TIMBER
		- LIMIT OF EDGE OF PAVEMENT OR COLD PLANE AND OVERLAY	LT	LEFT LEFT
		BANK OF RIVER OR STREAM BORDER OF WETLAND	MAX	MAXIMUM
100'BZ		100 FT WETLAND BUFFER	MB	MAILBOX
200'RA		200 FT RIVERFRONT AREA BUFFER	MH	MANHOLE
APX 200'RA		APPROX 200 FT RIVERFRONT BUFFER	MHB	MASSACHUSETTS HIGHWAY BOUND
100'RA		100 FT RIVERFRONT AREA BUFFER	MIN	MINIMUM  NOT IN CONTRACT
APX 100'RA		APPROX 100 FT RIVERFRONT AREA BUFFER	NIC NO.	NOT IN CONTRACT NUMBER
AURA		AURA BUFFER	PC	POINT OF CURVATURE
100BZ-AURA		100 FT AURA BUFFER	PCC	POINT OF COMPOUND CURVATURE
		100 FT VERNAL POOL AREA BUFFER - STATE HIGHWAY LAYOUT/STATE OWNED LAND	P.G.L.	PROFILE GRADE LINE
		- STATE HIGHWAY LAYOUT/STATE OWNED LAND - TOWN OR CITY LAYOUT	PI	POINT OF INTERSECTION
		- COUNTY LAYOUT	POC	POINT ON CURVE
		-RAILROAD SIDELINE	POT	POINT OF REVERSE CURVATURE
		TOWN OR CITY BOUNDARY LINE	PRC PROJ	POINT OF REVERSE CURVATURE PROJECT
—— ₽——		PROPERTY LINE OR APPROXIMATE PROPERTY LINE	PROP	PROPOSED
		- EASEMENT	PSB	PLANTABLE SOIL BORROW
۸	· c::::::x:::::x::::::x::::::	· EROSION CONTROL BARRIER  TRAVERSE OR TRIANGULATION STATION	PT	POINT OF TANGENCY

TRAVERSE OR TRIANGULATION STATION

SE BENCH W/ CONCRETE PAD

CHECK DAM

ABBREVIATIONS (	(cont.)	)
		,

PVC

PVI

PVT

**PVMT** 

PAVEMENT

POINT OF VERTICAL CURVATURE

POINT OF VERTICAL TANGENCY

POINT OF VERTICAL INTERSECTION

GENERAL	=
>WW	PAVED WATER WAY
R	RADIUS OF CURVATURE
R&D	REMOVE AND DISPOSE
RCP	REINFORCED CONCRETE PIPE
RD	ROAD
RDWY	ROADWAY
REM	REMOVE
RET	RETAIN
RET WALL	RETAINING WALL
ROW	RIGHT OF WAY
RR	RAILROAD
R&R	REMOVE AND RESET
R&S	REMOVE AND STACK
RT	RIGHT
SB	STONE BOUND
SHLD	SHOULDER
SMH	SEWER MANHOLE
ST	STREET
STA	STATION
SSD	STOPPING SIGHT DISTANCE
SHLO	STATE HIGHWAY LAYOUT LINE
SW	SIDEWALK
Т	TANGENT DISTANCE OF CURVE/TRUCK %
TAN	TANGENT
TEMP	TEMPORARY
TC	TOP OF CURB
TMA	TELEPHONE MAST ARM
TOS	TOP OF SLOPE
TYP	TYPICAL
UP	UTILITY POLE
VAR	VARIES
VERT	VERTICAL
VC	VERTICAL CURVE
WCR	WHEEL CHAIR RAMP
WG	WATER GATE
WIP	WROUGHT IRON PIPE
WM	WATER METER/WATER MAIN
X-SECT	CROSS SECTION

### PAVEMENT MARKINGS SYMBOLS

EXISTING	PROPOSED	DESCRIPTION
	SL	STOP LINE
	cw	CROSSWALK
	SWL	SOLID WHITE LINE
	SYL	SOLID YELLOW LINE
	BWL	BROKEN WHITE LINE
	BYL	BROKEN YELLOW LINE
	<u>DWL</u>	DOTTED WHITE LINE
	<u>DYL</u>	DOTTED YELLOW LINE
	DWLEx	DOTTED WHITE LINE EXTENSION
	DYLEx	DOTTED YELLOW LINE EXTENSION
	DBWL	DOUBLE WHITE LINE
	DBYL	DOUBLE YELLOW LINE

#### **GENERAL NOTES:**

- 1. THE PROPERTY LINES SHOWN ON THIS PLAN OF THE PARCELS AT 44 FOREST AVENUE IN HUDSON, 163 BOSTON POST ROAD IN SUDBURY AND THE FORMER RAILROAD RIGHT-OF-WAY ARE BASED UPON AN ACTUAL FIELD SURVEY CONDUCTED BY VHB, INC. IN 2015 AND FROM DEEDS AND PLANS OF RECORD.
- 2. THE EXISTING CONDITIONS SHOWN ON THIS PLAN WERE DEVELOPED FROM A COMBINED EFFORT OF AERIAL PHOTOGRAMMETRIC MAPPING BY EASTERN TOPOGRAPHICS, INC., BASED ON AERIAL PHOTOGRAPHS TAKEN ON FEBRUARY 22, 2013, AND AUGMENTED BY AN ON-THE-GROUND SURVEY PERFORMED BY VHB DURING 2015 AND 2017.
- 3. THE HORIZONTAL CONTROL IS BASED ON THE MASSACHUSETTS MAINLAND STATE PLANE COORDINATE SYSTEM AND THE NATIONAL GEODETIC SURVEY (NAD83). ALL ELEVATION IS US FEET, REFERENCED TO THE NORTH AMERICA VERTICAL DATUM OF 1988 (NAVD88).
- 4. THE CONTRACTOR SHALL VERIFY ALL EXISTING DIMENSIONS AND GRADES IN THE FIELD BEFORE COMMENCING WORK AND PROMPTLY NOTIFY THE ENGINEER OF ANY DISCREPANCIES.
- 3. THE LOCATIONS OF EXISTING UNDERGROUND UTILITIES SHOWN ON THIS PLAN ARE BASED ON FIELD OBSERVATIONS AND INFORMATION OF RECORD. THEY HAVE NOT BEEN INDEPENDENTLY VERIFIED BY THE OWNER OR ITS REPRESENTATIVE. THE CONTRACTOR SHALL DETERMINE THE EXACT LOCATION OF ALL EXISTING UTILITIES BEFORE COMMENCING WORK, AND SHALL BE FULLY RESPONSIBLE FOR ANY AND ALL DAMAGES WHICH MIGHT BE OCCASIONED BY THE CONTRACTOR'S FAILURE TO EXACTLY LOCATE AND PRESERVE ANY AND ALL UNDERGROUND UTILITIES.
- 4. THE DELINEATED WETLANDS SHOWN ON THIS PLAN WERE FLAGGED BY THE VHB ENVIRONMENTAL DEPARTMENT AND FIELD SURVEYED BY THE VHB SURVEY DEPARTMENT IN SEPTEMBER AND OCTOBER 2017 AND WERE UPDATED IN MAY 2018 (SUDBURY ONLY). IN HUDSON, ADDITIONAL WETLANDS WERE DELINEATED AND SURVEYED BY VHB IN JANUARY 2019.
- 5. THE APPROXIMATE WETLANDS AND STREAMS, AND THEIR ASSOCIATED BUFFERS AND RIVERFRONT AREAS, WHERE APPLICABLE, WERE TAKEN FROM AVAILABLE MASSGIS DATA. THESE WERE NOT FIELD DELINEATED OR FIELD VERIFIED.
- 6. WHERE AN EXISTING UTILITY IS FOUND TO CONFLICT WITH THE PROPOSED WORK, THE LOCATION, ELEVATION AND SIZE OF THE UTILITY SHALL BE ACCURATELY DETERMINED WITHOUT DELAY BY THE CONTRACTOR, AND THE INFORMATION FURNISHED TO THE ENGINEER FOR RESOLUTION OF THE CONFLICT.
- 7. THE CONTRACTOR SHALL ALTER THE MASONRY OF THE TOP SECTION OF ALL EXISTING DRAINAGE AND SEWER STRUCTURES AS NECESSARY FOR CHANGES IN GRADE, AND RESET ALL WATER AND DRAINAGE FRAMES, GRATES AND BOXES TO THE PROPOSED FINISH SURFACE GRADE. REQUIRED NEW MASONRY SHALL BE CLAY BRICK.
- 8. THE CONTRACTOR SHALL MAKE ALL ARRANGEMENTS FOR THE ALTERATION AND ADJUSTMENT OF GAS, ELECTRIC, TELEPHONE AND ANY OTHER PRIVATE UTILITIES BY THE UTILITY COMPANIES.
- 9. EXISTING UTILITY POLES WILL BE RELOCATED BY OTHERS IF REQUIRED.
- 10. TREES AND SHRUBS WITHIN THE LIMITS OF GRADING SHALL BE REMOVED ONLY UPON APPROVAL OF THE ENGINEER.
- 11. AREAS OUTSIDE THE LIMITS OF PROPOSED WORK DISTURBED BY THE CONTRACTOR'S OPERATIONS SHALL BE RESTORED BY THE CONTRACTOR TO THEIR ORIGINAL CONDITION AT NO EXPENSE TO THE OWNER.
- 12. THE TERM "PROPOSED" (PROP) MEANS WORK TO BE CONSTRUCTED USING NEW MATERIALS OR, WHERE APPLICABLE, RE-USING EXISTING MATERIALS IDENTIFIED AS "REMOVE AND RESET" (R&R).
- 13. JOINTS BETWEEN NEW ASPHALT CONCRETE ROADWAY PAVEMENT AND SAWCUT EXISTING PAVEMENT SHALL BE SEALED WITH BITUMEN AND BACKSANDED.
- 14. EXISTING SIGNS WITHIN THE PROJECT LIMITS SHALL BE RETAINED UNLESS INDICATED OTHERWISE ON THE DRAWINGS.
- 15. IF SUITABLE, ALL EXISTING GRANITE CURB & EDGING SHALL BE RE-USED IN THE PROPOSED WORK, EXCEPT CURVED STONES OF A DIFFERENT RADIUS THAN PROPOSED
- 16. ALL PROPOSED HOT MIX ASPHALT CURB SHALL BE MASSDOT TYPE 3 UNLESS STATED OTHERWISE ON THE PLANS.
- 17. ALL EXISTING STATE, COUNTY, CITY, AND TOWN LOCATION LINES AND PRIVATE PROPERTY LINES HAVE BEEN ESTABLISHED FROM AVAILABLE INFORMATION AND THEIR EXACT LOCATIONS ARE NOT GUARANTEED.
- 18. DISPOSAL OF ALL SURPLUS MATERIAL SHALL BE AS APPROVED BY THE ENGINEER AND
- 19. ALL EXISTING EROSION CONTROL BARRIER, CONSTRUCTION FENCING AND SILT SACKS SHALL BE MAINTAINED THROUGHOUT CONSTRUCTION ACTIVITIES AND REMOVED AFTER CONSTRUCTION ACTIVITIES ARE COMPLETE.



Environmental Services

Watertown, MA 02472


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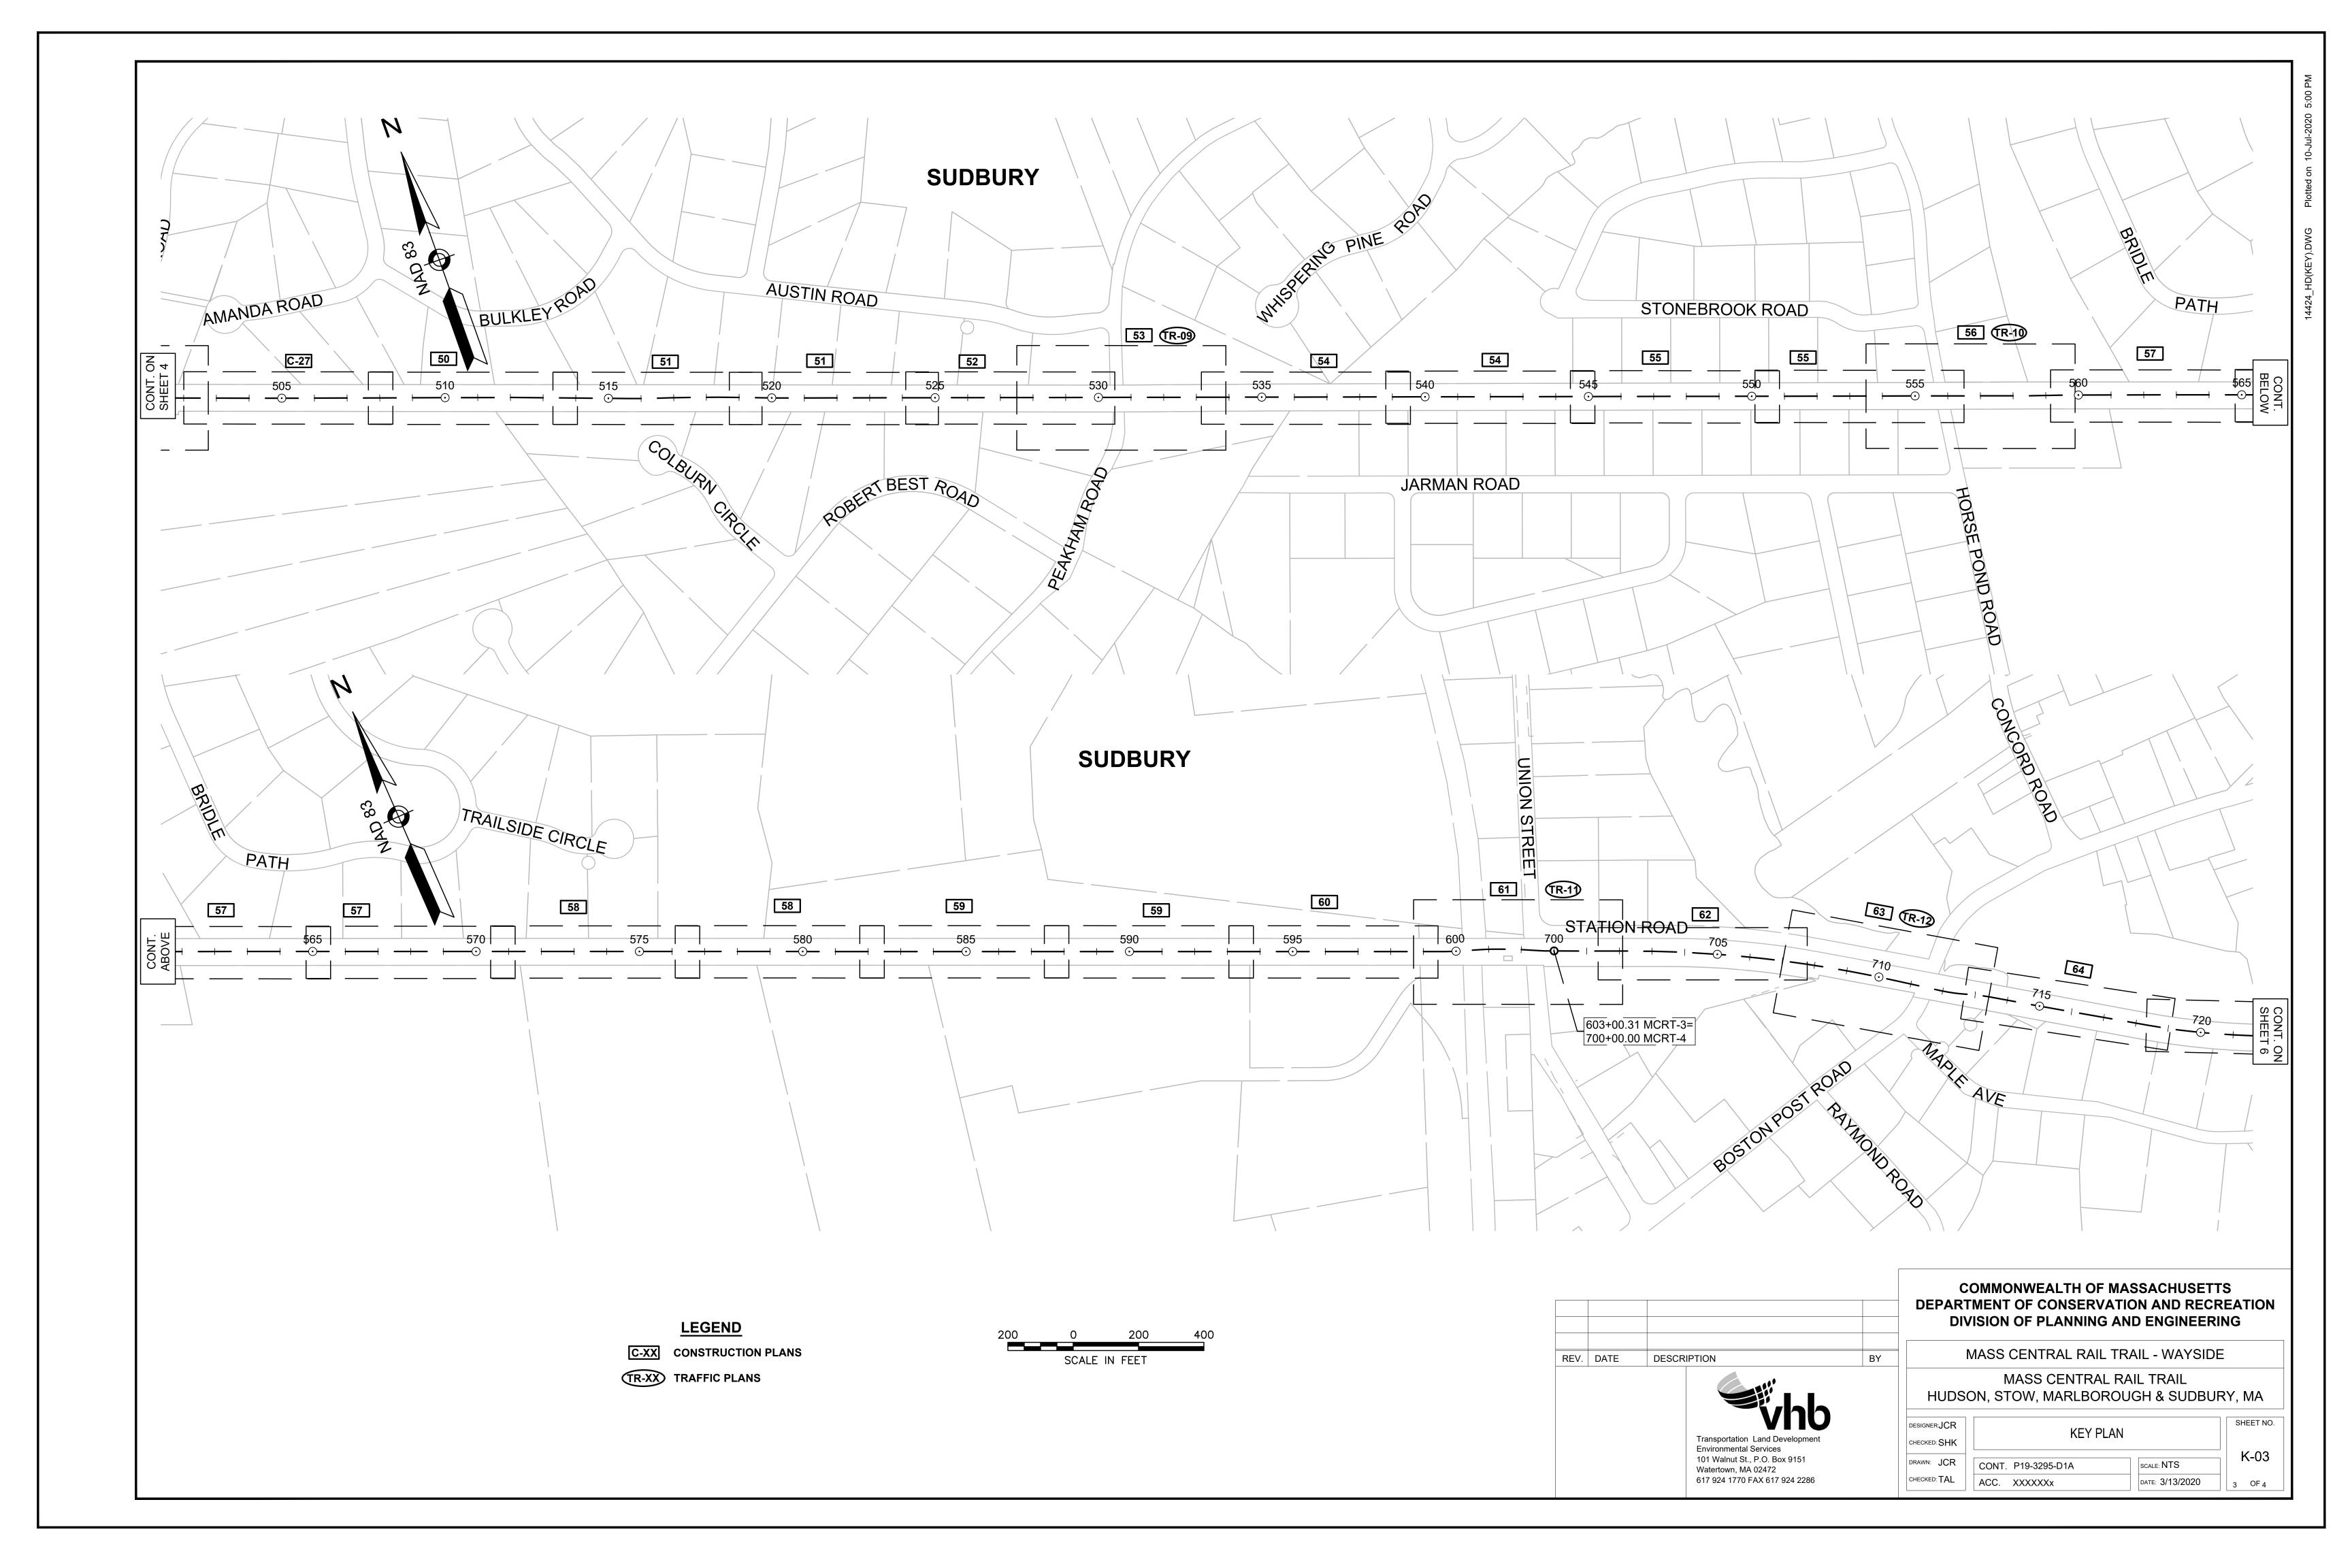
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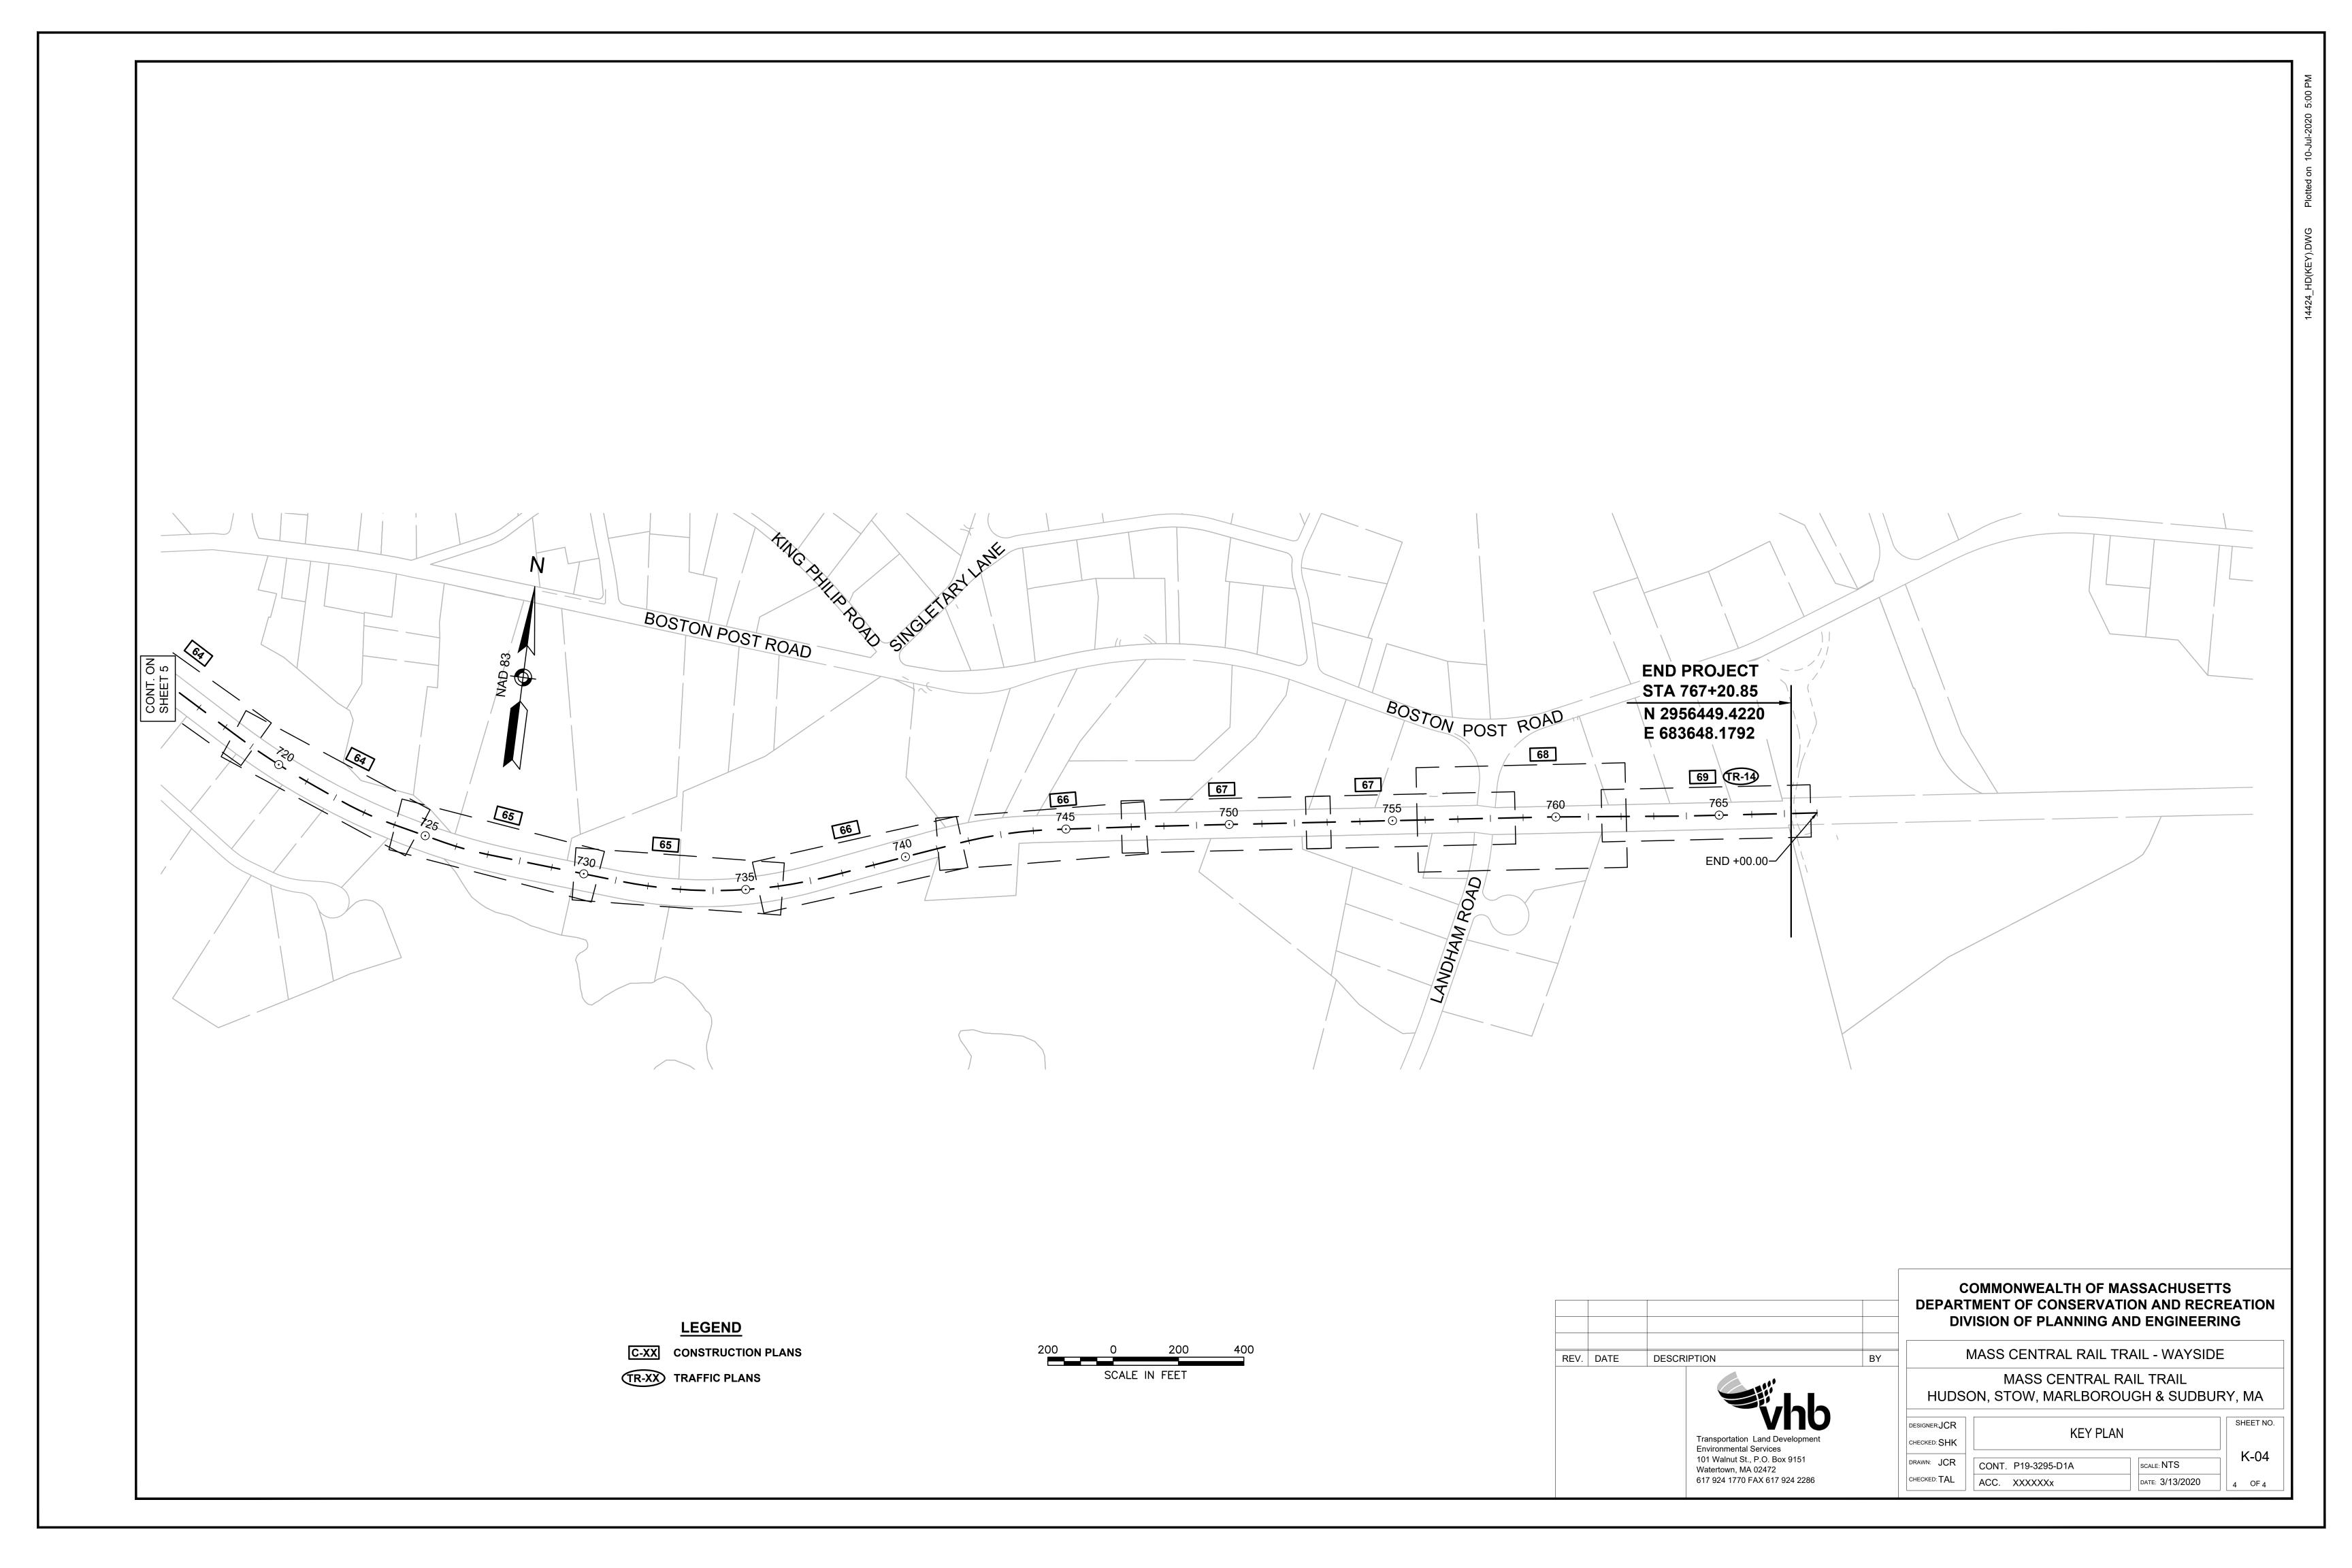
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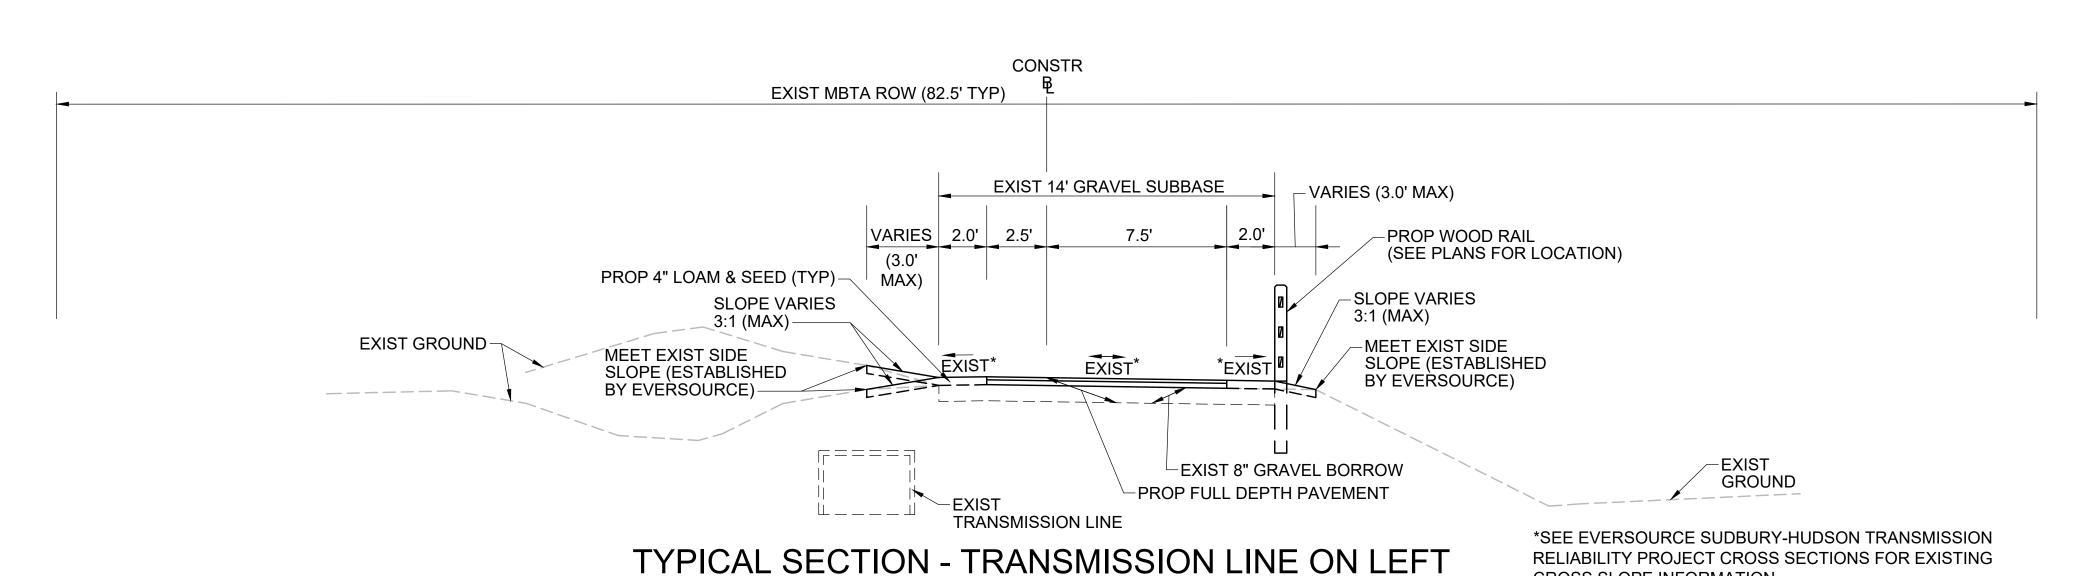
MASS CENTRAL RAIL TRAIL - WAYSIDE MASS CENTRAL RAIL TRAIL HUDSON STOW MARI BOROUGH & SUDBURY MA


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## PAVEMENT NOTES

PROPOSED PATH PAVEMENT

SURFACE: 1.5" SUPERPAVE SURFACE COURSE - 9.5 (SSC - 9.5)

INTERMEDIATE: 2.5" SUPERPAVE INTERMEDIATE COURSE - 19.0 (SIC - 19.0)

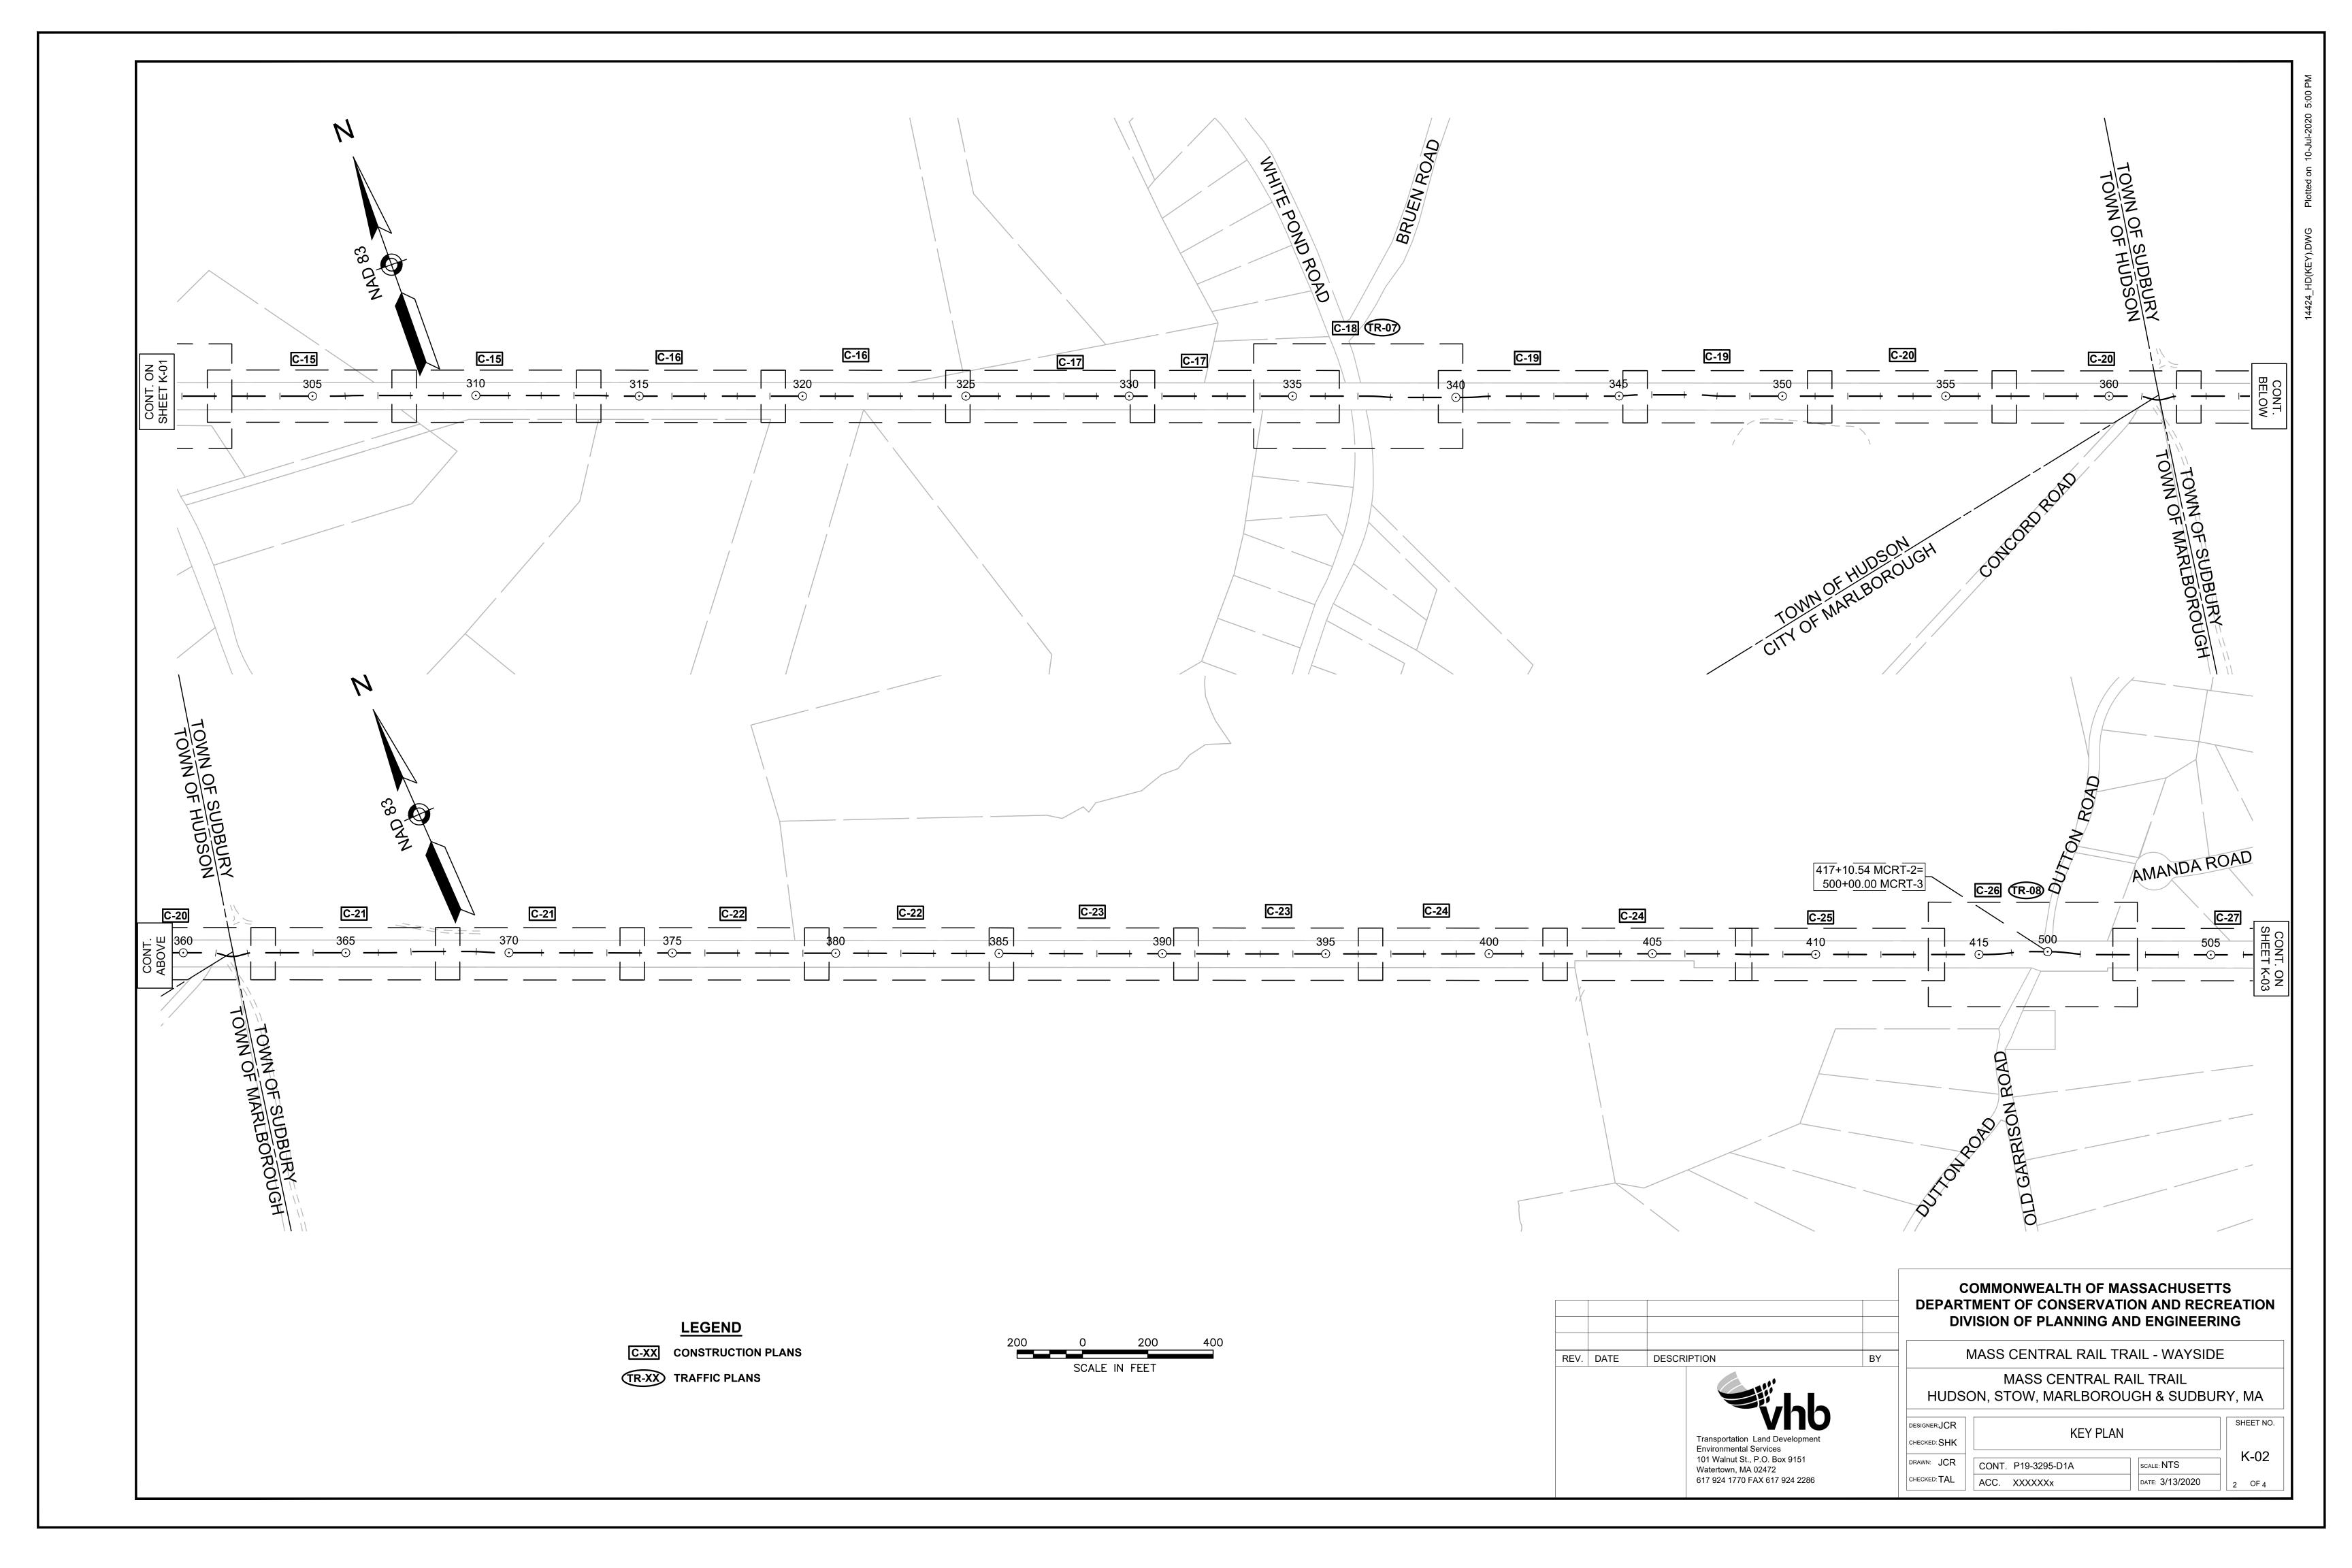SUBBASE: 8" GRAVEL BORROW, TYPE b

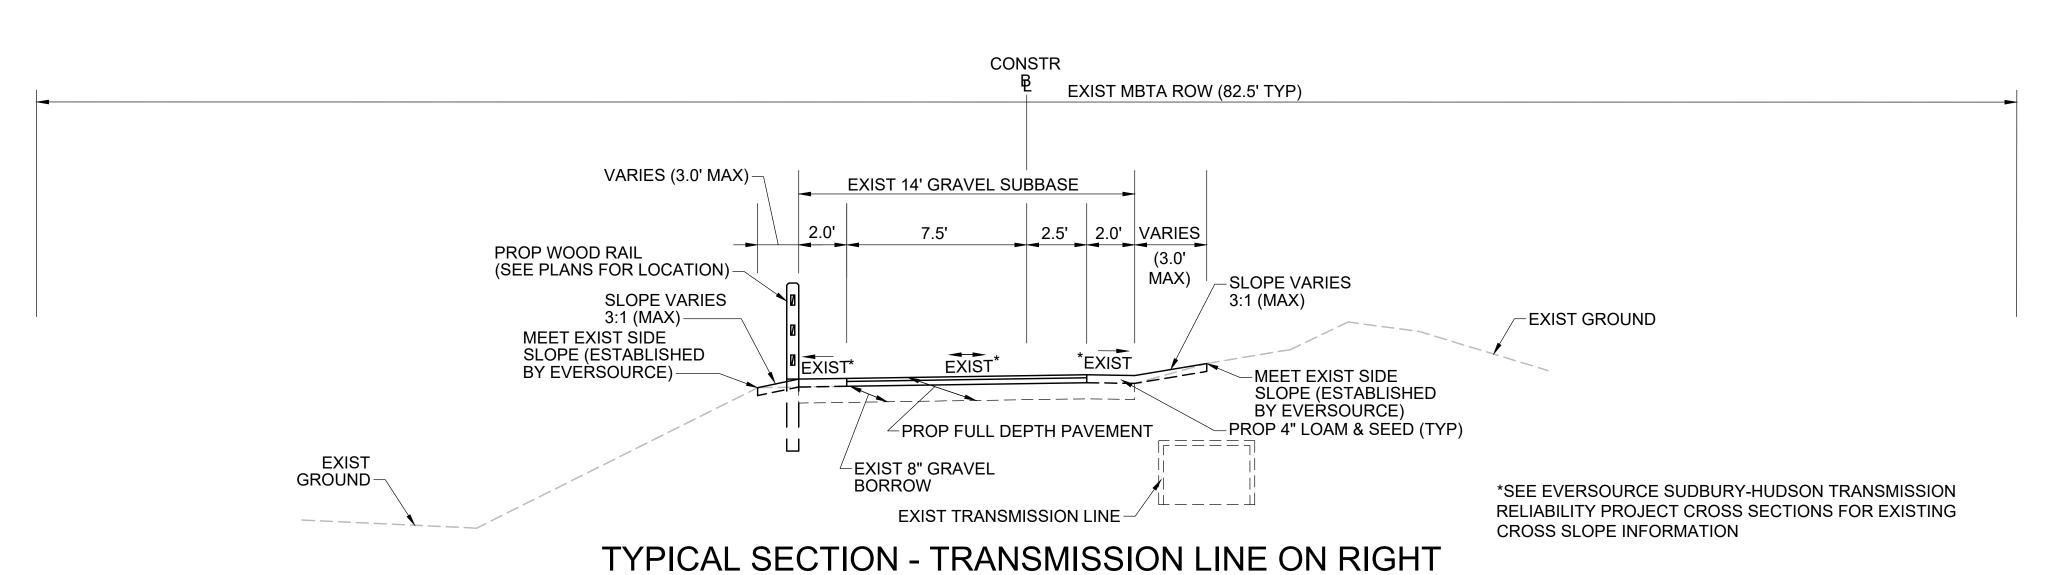NOTE:

FROM STA 100+00± TO STA 767+20± EXIST GRAVEL FROM EVERSOURCE ACCESS ROAD SHALL BE USED FOR SUBBASE MATERIAL.

PROPOSED CATTLE CROSSING PAVEMENT

SURFACE: 1.5" SUPERPAVE SURFACE COURSE - 9.5 (SSC - 9.5)

INTERMEDIATE:* 2.5" SUPERPAVE INTERMEDIATE COURSE - 19.0 (SIC - 19.0)

NOTE:

2.5" SUPERPAVE INTERMEDIATE COURSE TO BE INSTALLED AS PART OF EVERSOURCE SUDBURY-HUDSON TRANSMISSION LINE RELIABILITY PROJECT.

PROPOSED CEMENT CONCRETE WHEELCHAIR RAMP

SURFACE: 6" CEMENT CONCRETE
AIR ENTRAINED 4000 PSI, 3/4", 610

SUBBASE: 8" GRAVEL BORROW, TYPE b

*NOTE:

EXIST GRAVEL FROM EVERSOURCE ACCESS ROAD SHALL BE USED FOR SUBBASE MATERIAL.

PROPOSED CEMENT CONCRETE PULL OFF/TURN AROUND

SURFACE: 4" CEMENT CONCRETE

AIR ENTRAINED 4000 PSI, 3/4", 610

SUBBASE: 8" GRAVEL BORROW, TYPE b

*NOTE:

EXIST GRAVEL FROM EVERSOURCE ACCESS ROAD SHALL BE USED FOR SUBBASE MATERIAL.

____

PROPOSED HOT MIX ASPHALT WALK

SURFACE: 1" SUPERPAVE SURFACE COURSE - 9.5 (SSC-9.5)

1.5" SUPERPAVE INTERMEDIATE COURSE 12.5 (SIC-12.5)

SUBBASE: 8" GRAVEL BORROW, TYPE b

## NOTES:

RELIABILITY PROJECT CROSS SECTIONS FOR EXISTING

**CROSS SLOPE INFORMATION** 

**CROSS SLOPE INFORMATION** 

- 1. ALL HOT MIX ASPHALT SHALL BE PRODUCED WITH A WARM-MIX ASPHALT ADDITIVE.
- ALL HOT MIX ASPHALT PAVEMENTS SHALL BE CONSTRUCTED AND PRODUCED IN ACCORDANCE WITH SECTION 450 HOT MIX ASPHALT PAVEMENT.
- ASPHALT EMULSION FOR TACK COAT (RS-1H) SHALL BE SPRAY APPLIED FOR DOUBLE OVERLAP COVERAGE AT 0.05
  GALLONS PER SQUARE YARD OVER SMOOTH SURFACES.
- HMA JOINT SEALANT (ASPHALT RUBBER) SHALL BE APPLIED IN SURFACE COURSE AT ALL VERTICAL COLD JOINTS PRIOR TO PAVING.
- ALL HOT MIX ASPHALT WALKS SHALL BE MEASURED AND PAID FOR UNDER ITEM 702 OF STANDARD SPECIFICATIONS FOR HIGHWAYS AND BRIDGES.



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MASS CENTRAL RAIL TRAIL - WAYSIDE

MASS CENTRAL RAIL TRAIL
HUDSON, STOW, MARLBOROUGH & SUDBURY, MA

DESIGNER:JCR
TYPICAL SECTIONS & PVMT NOTES
SHEET NO.

DESIGNER: JCR
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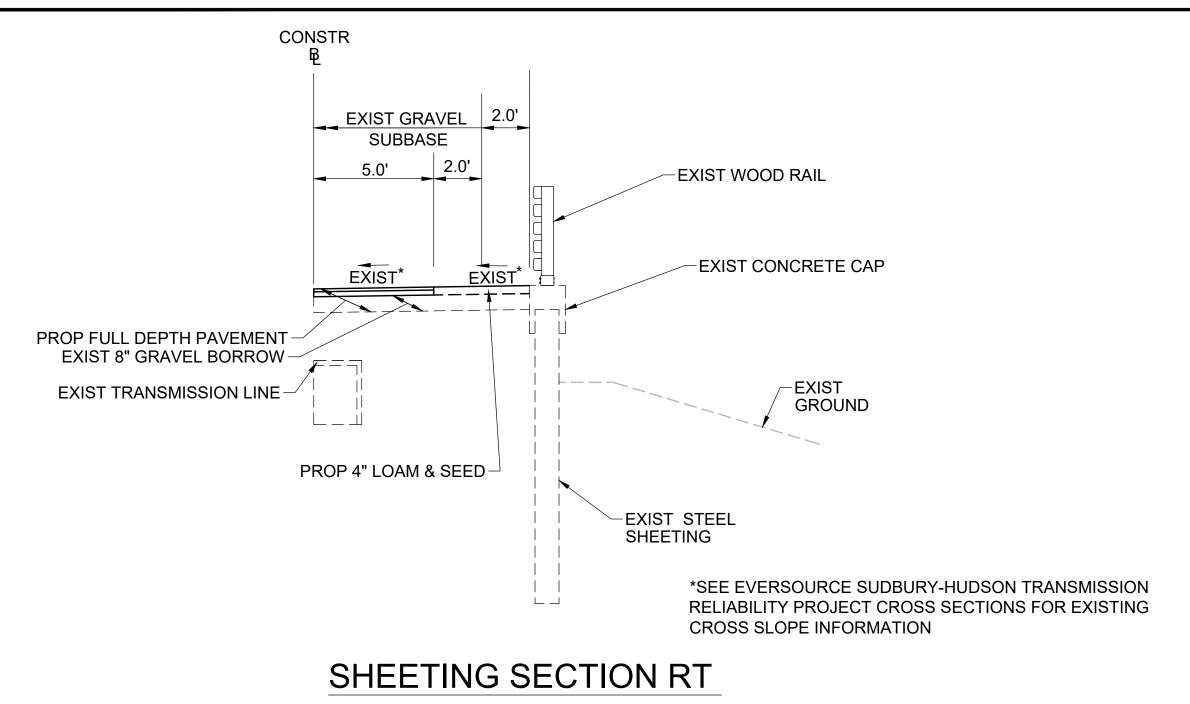
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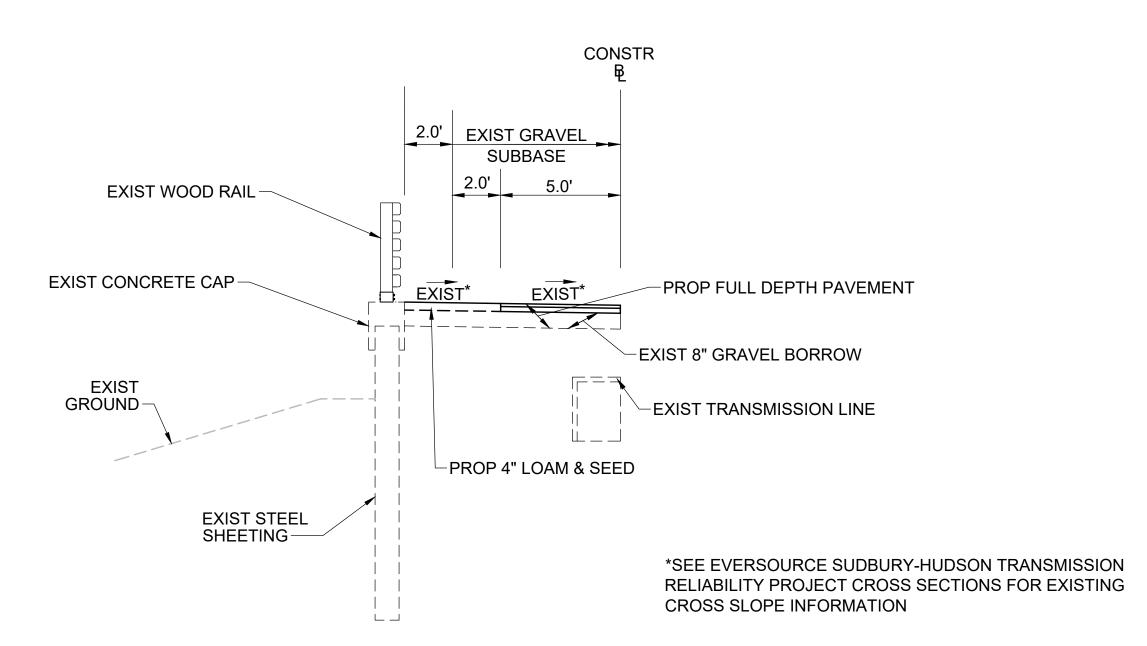
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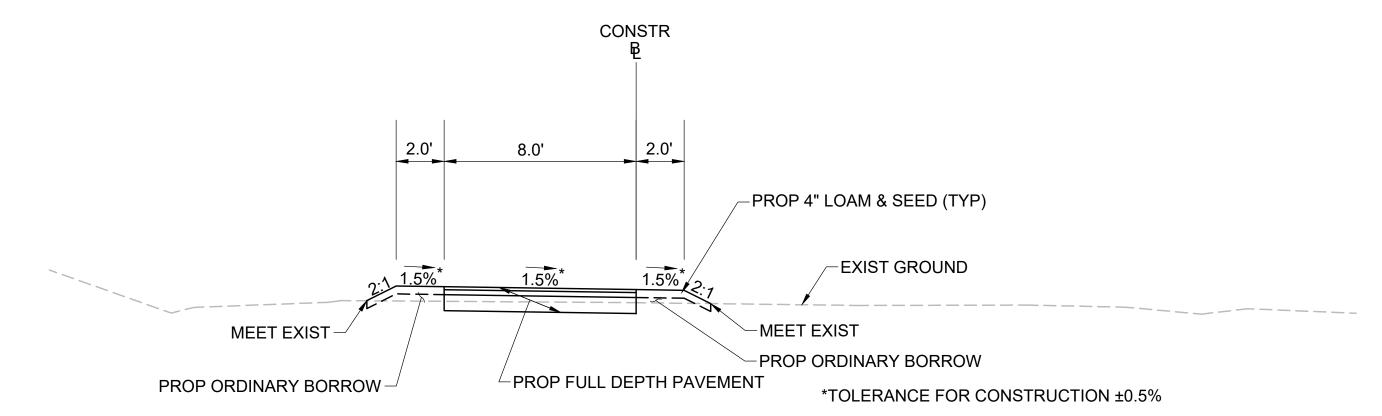


STA 148+25± TO STA 148+49±, STA 149+13± TO STA 149+75±, STA 399+91± TO STA 400+07±, STA 400+58± TO STA 401+25±, STA 724+73± TO STA 725+03±, STA 725+59± TO STA 725+96±, STA 731+00± TO STA 734+25±



## SHEETING SECTION LT

STA 119+00± TO STA 119+38±, STA 119+52± TO STA 125+00±, STA 148+25± TO STA 148+49±, STA 149+13± TO STA 149+75±, STA 300+50± TO STA 400+07±, STA 400+58± TO STA 401+25±, STA 724+73± TO STA 725+03±, STA 725+59± TO STA 725+96±



# TYPICAL SECTION - MCRT CONNECTION


STA 10+15± TO STA 12+40±

___ 1.0' LEVEL **CEM CONC** PULL OFF/TURN AROUND EXIST 8" GRAVEL BORROW-EXIST GROUND -PROP 4" LOAM & SEED (TYP) EXIST MANHOLE OR HANDHOLE *TOLERANCE FOR CONSTRUCTION ±0.5%

# **PAVEMENT NOTES**

*SEE SHEET TS-01

# TYPICAL SECTION - PULL OFF/TURN AROUND

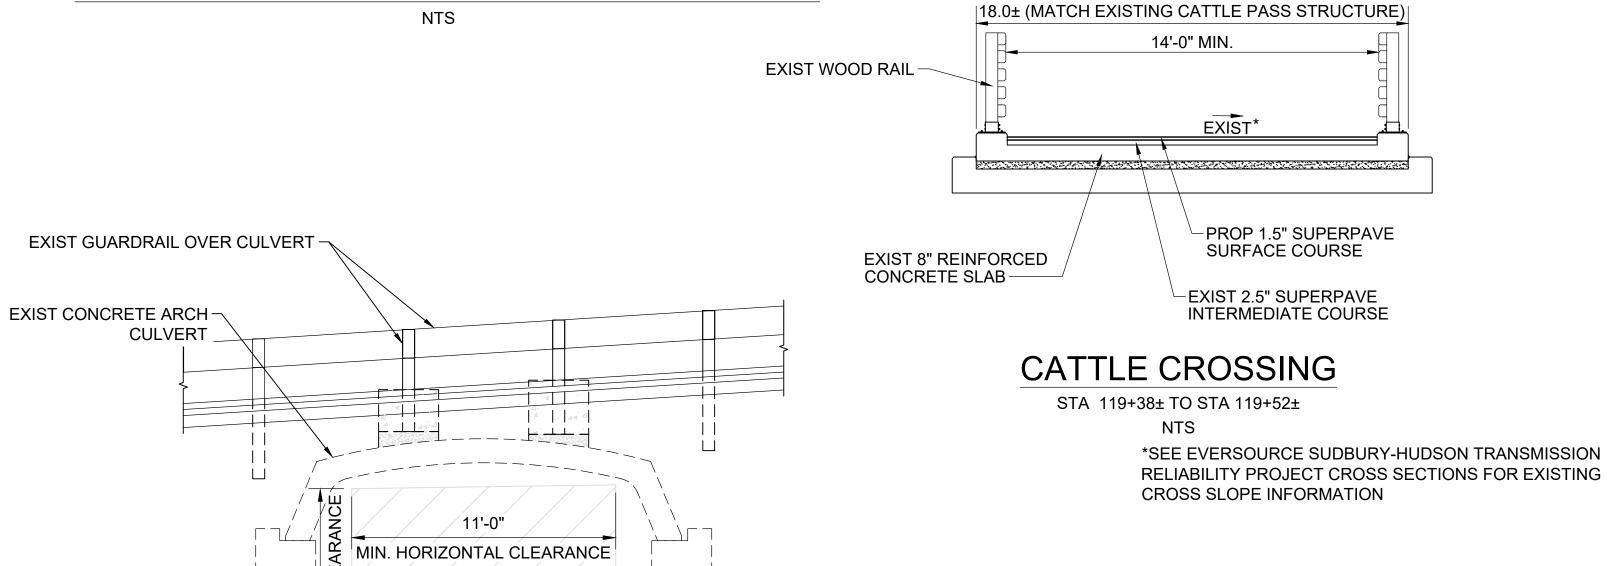

<u>____</u> -PROP FULL DEPTH PAVEMENT

**EXIST 14' GRAVEL** 

ACCESS ROAD

CONSTR

EXIST*

EXIST CONCRETE -

EXIST TRANSMISSION LINE

PEDESTAL WALL & FOOTING (TYP)

> CHESTNUT STREET CULVERT STA 132+44± TO STA 132+84±

*SEE EVERSOURCE SUDBURY-HUDSON TRANSMISSION RELIABILITY PROJECT CROSS SECTIONS FOR EXISTING CROSS SLOPE INFORMATION



Transportation Land Development

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EXIST 8" GRAVEL BORROW


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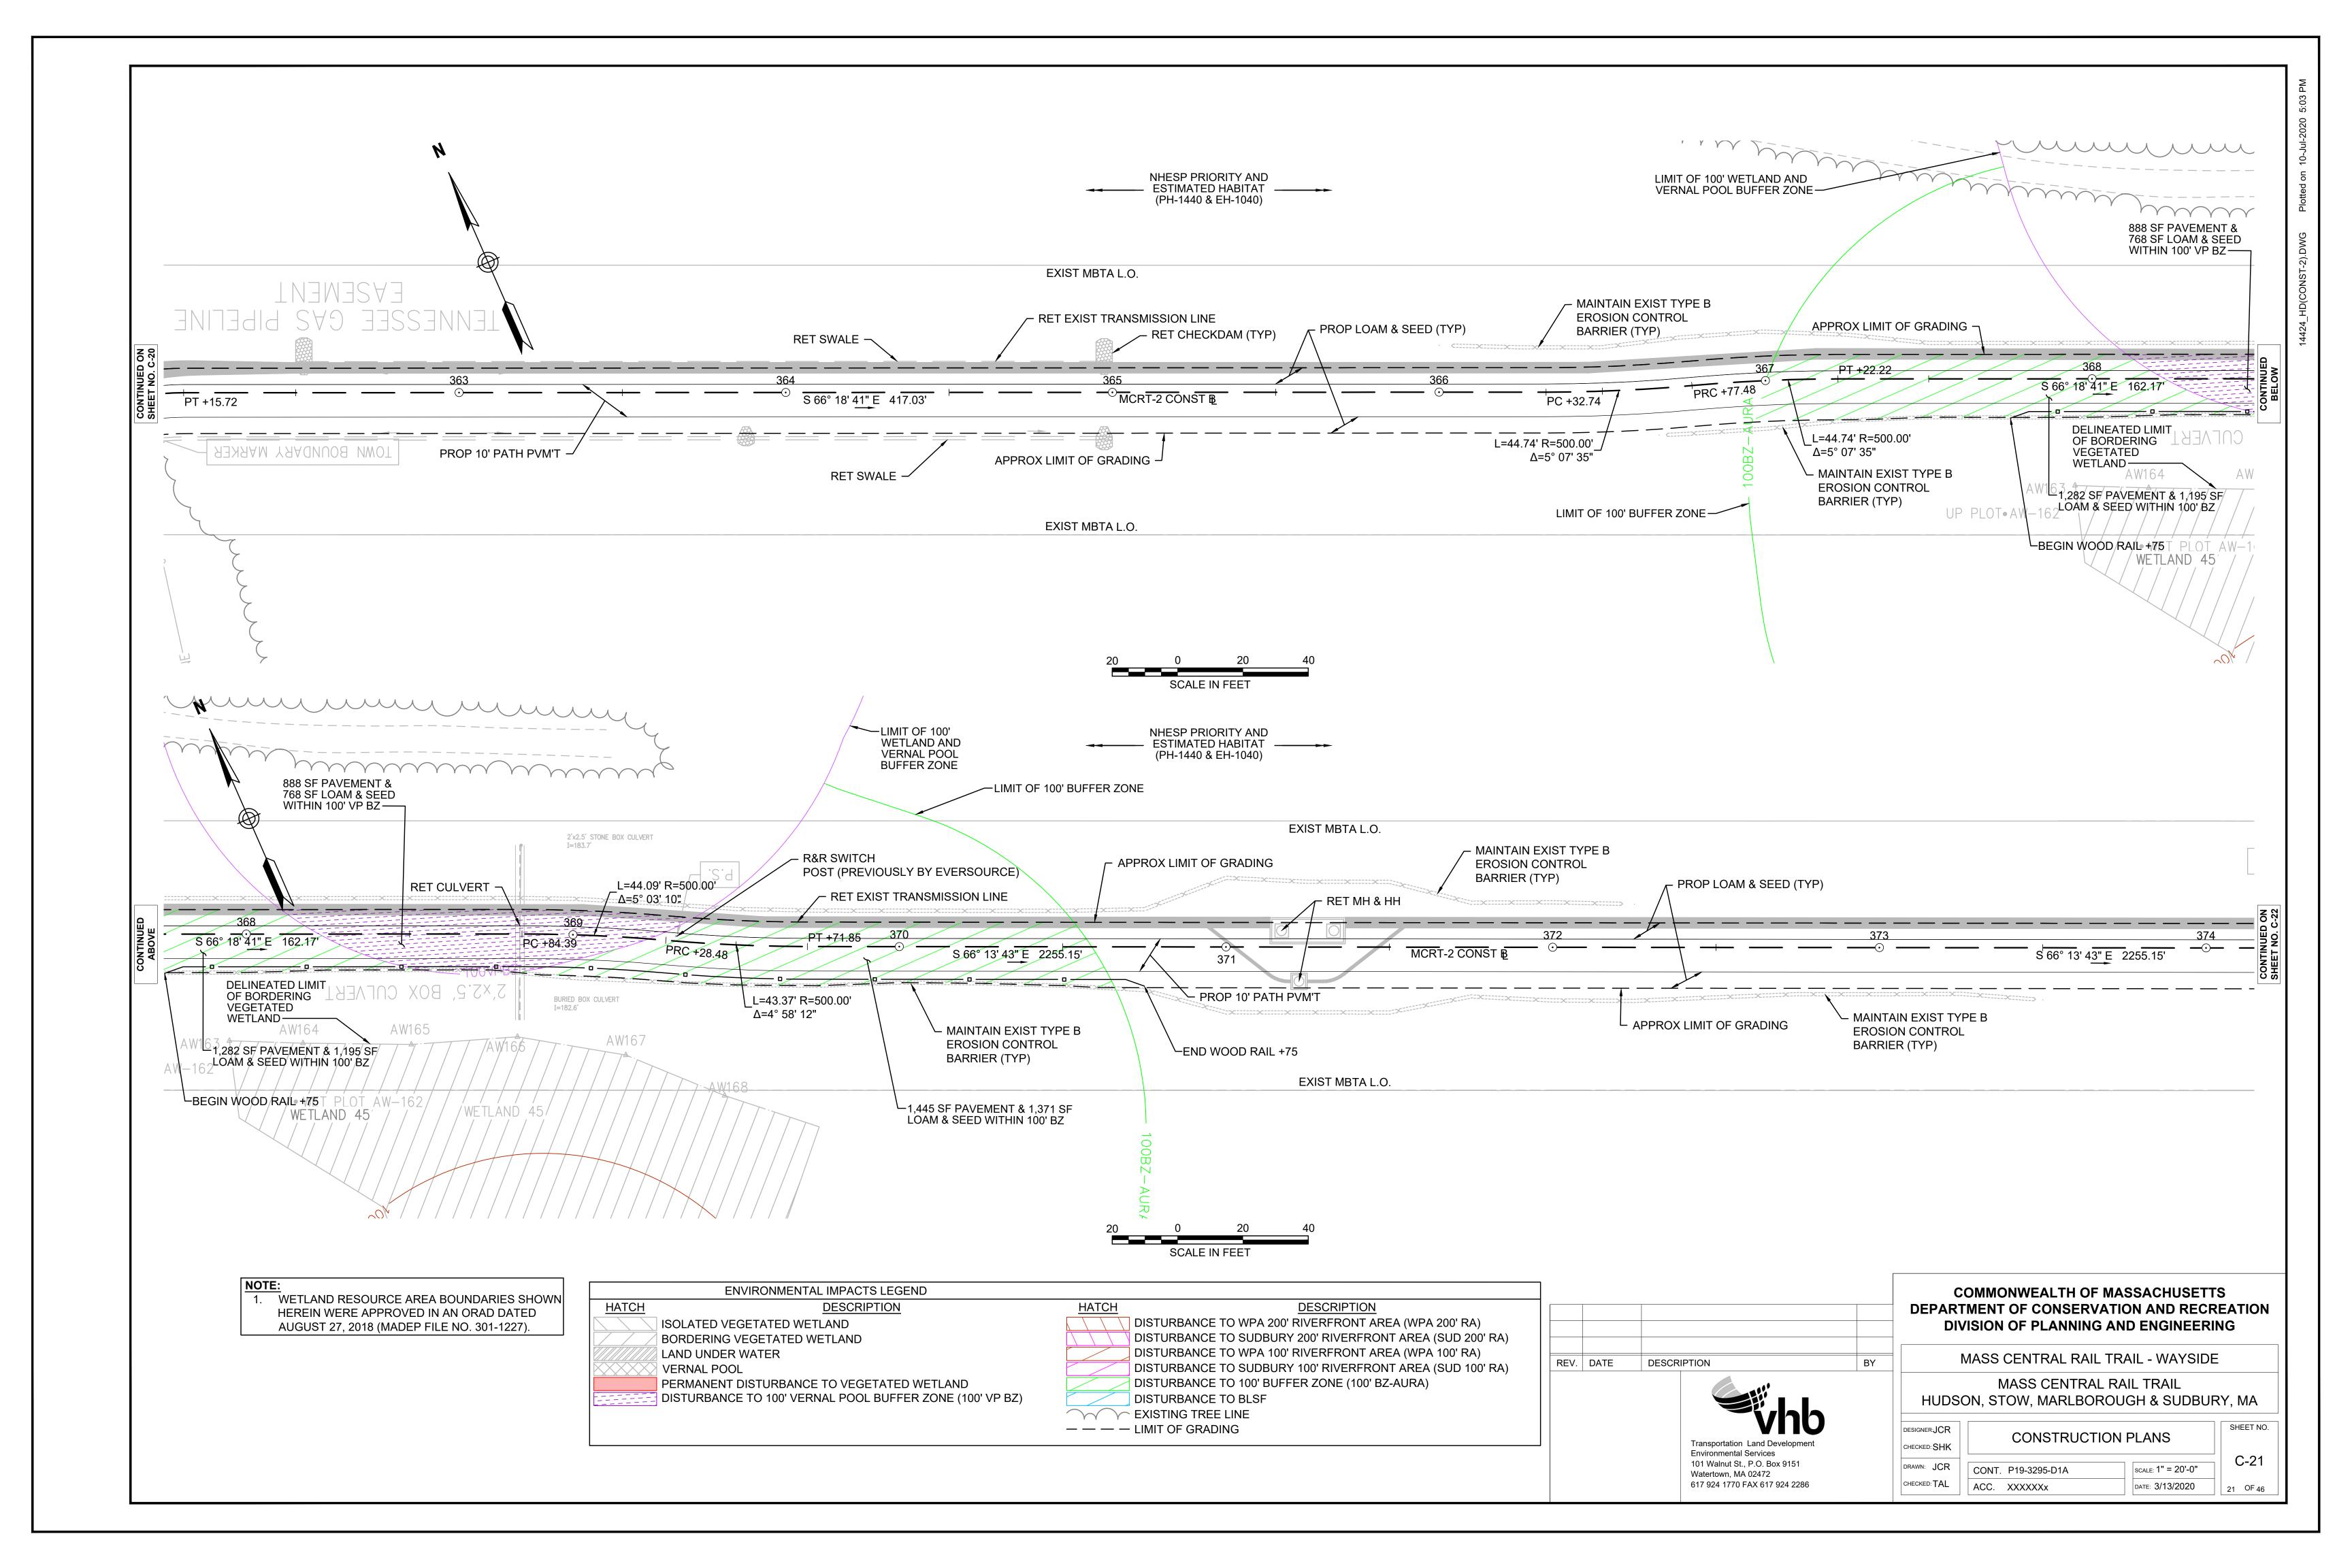
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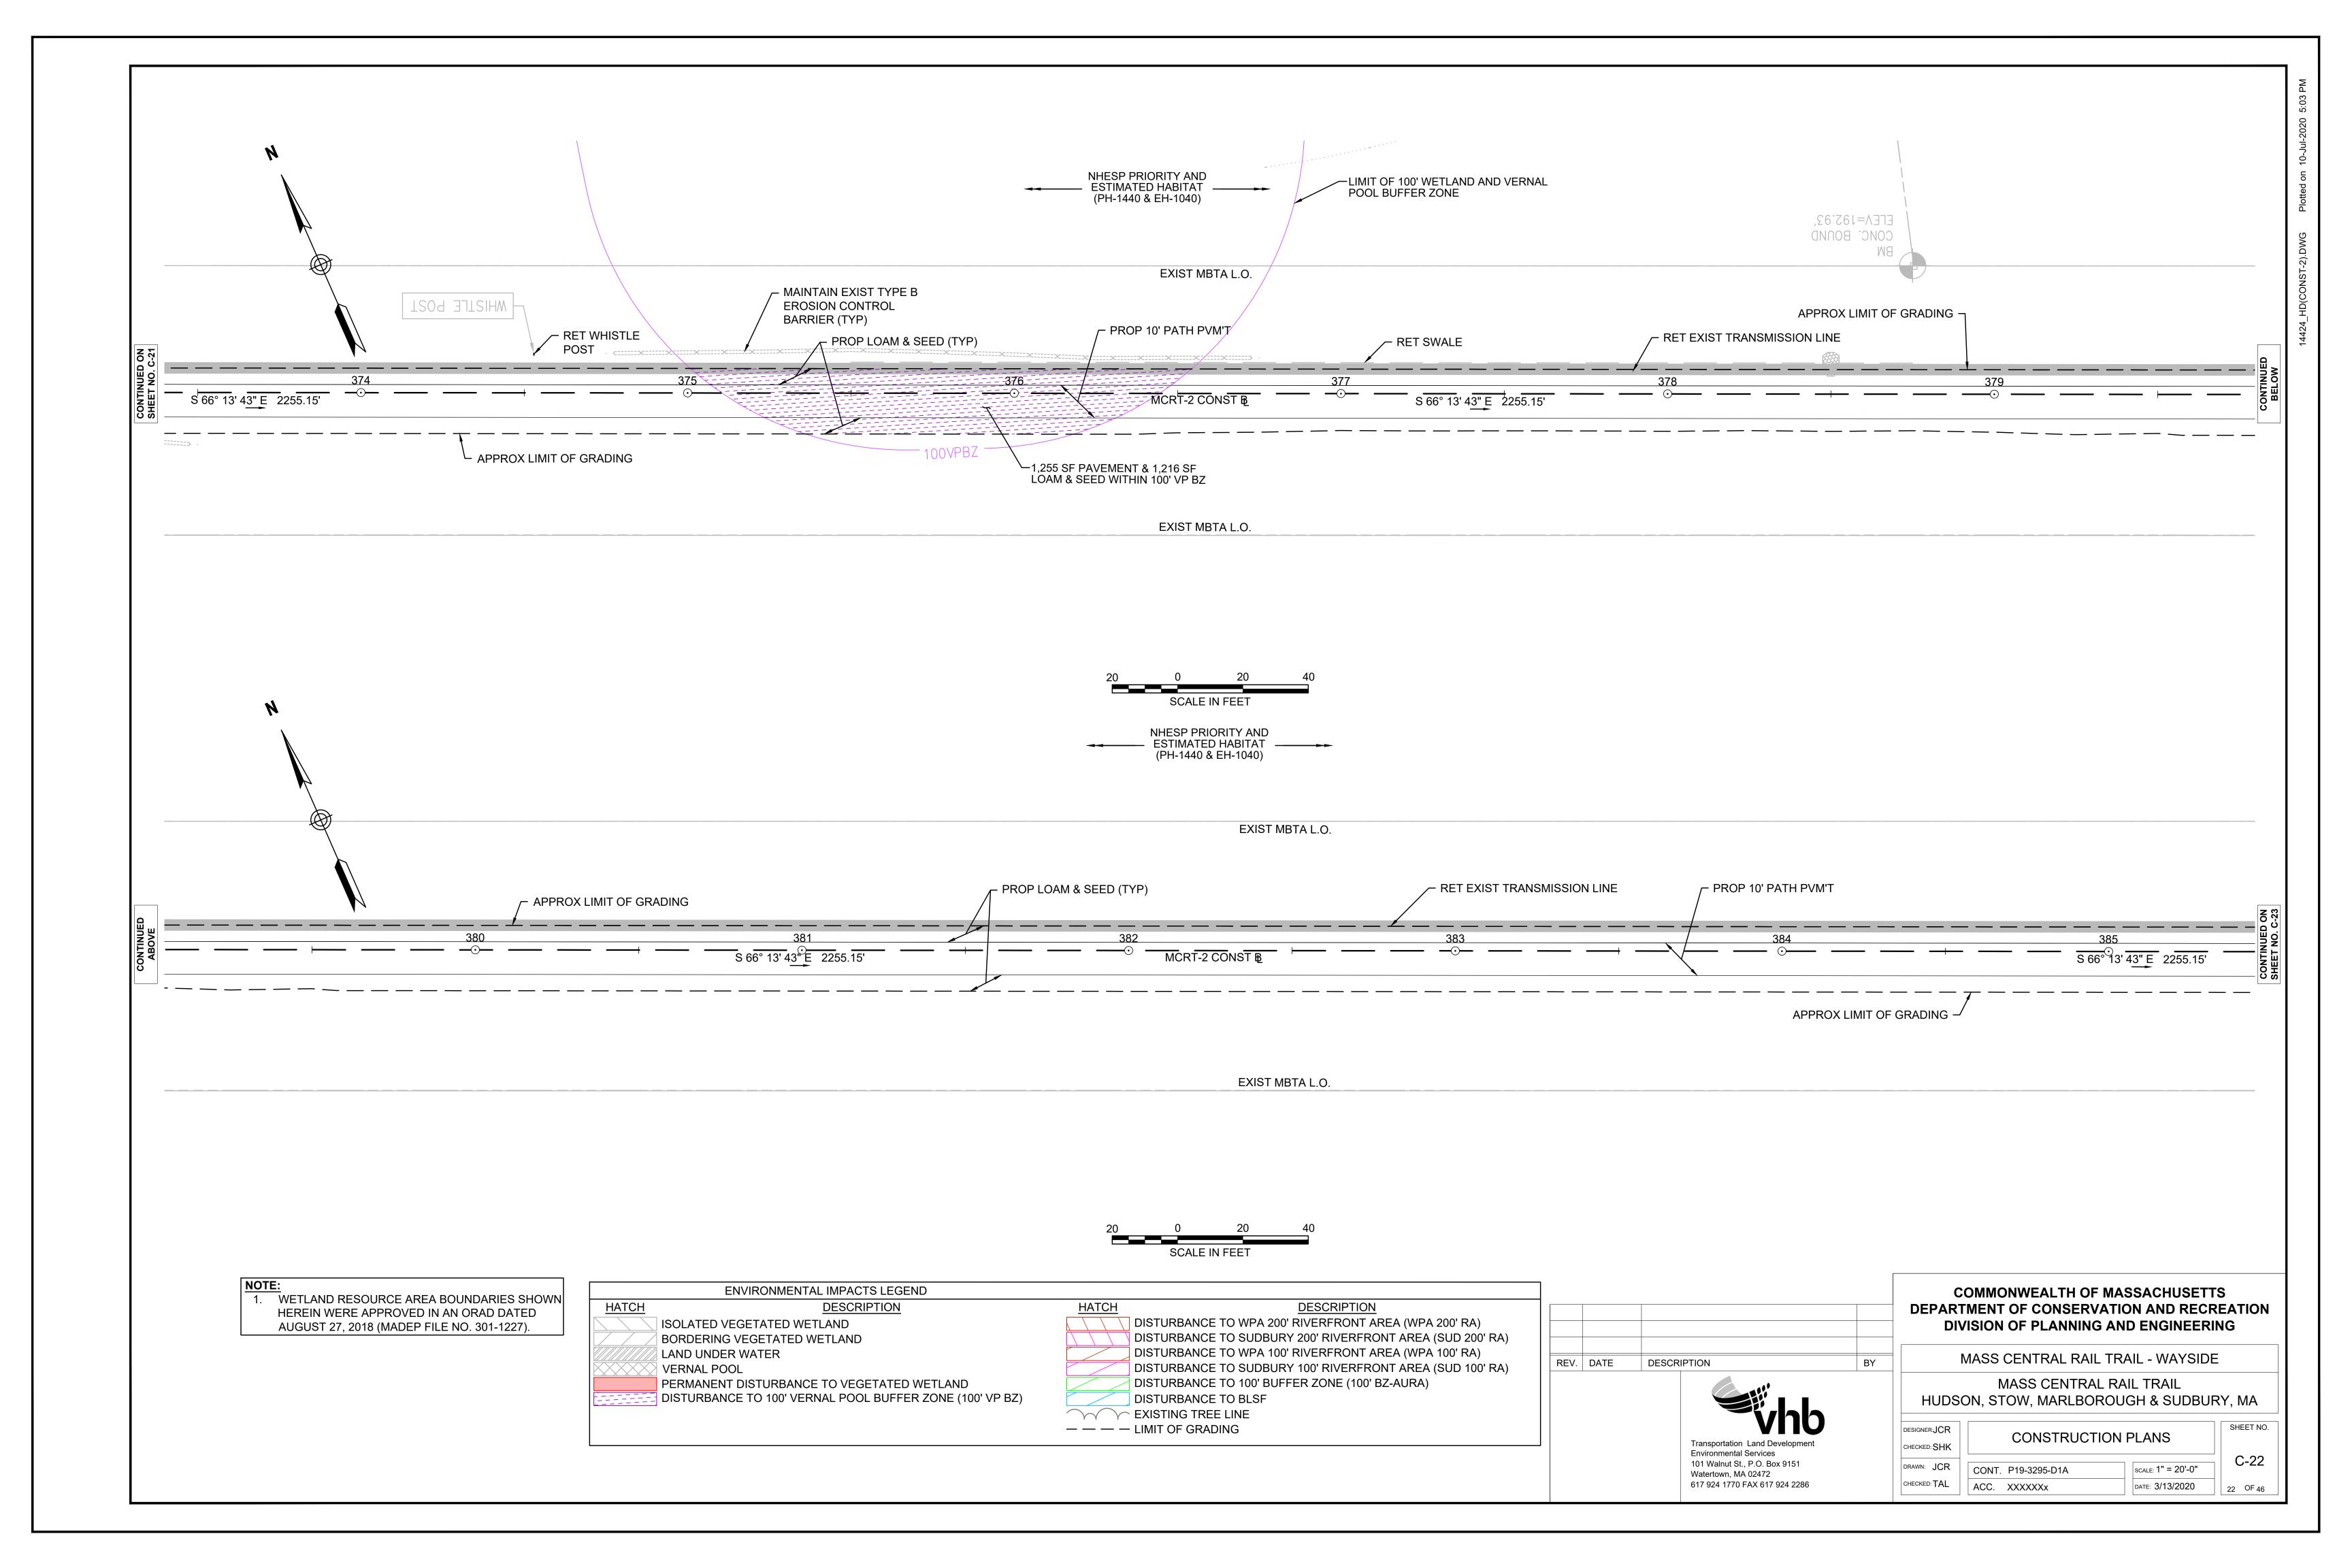
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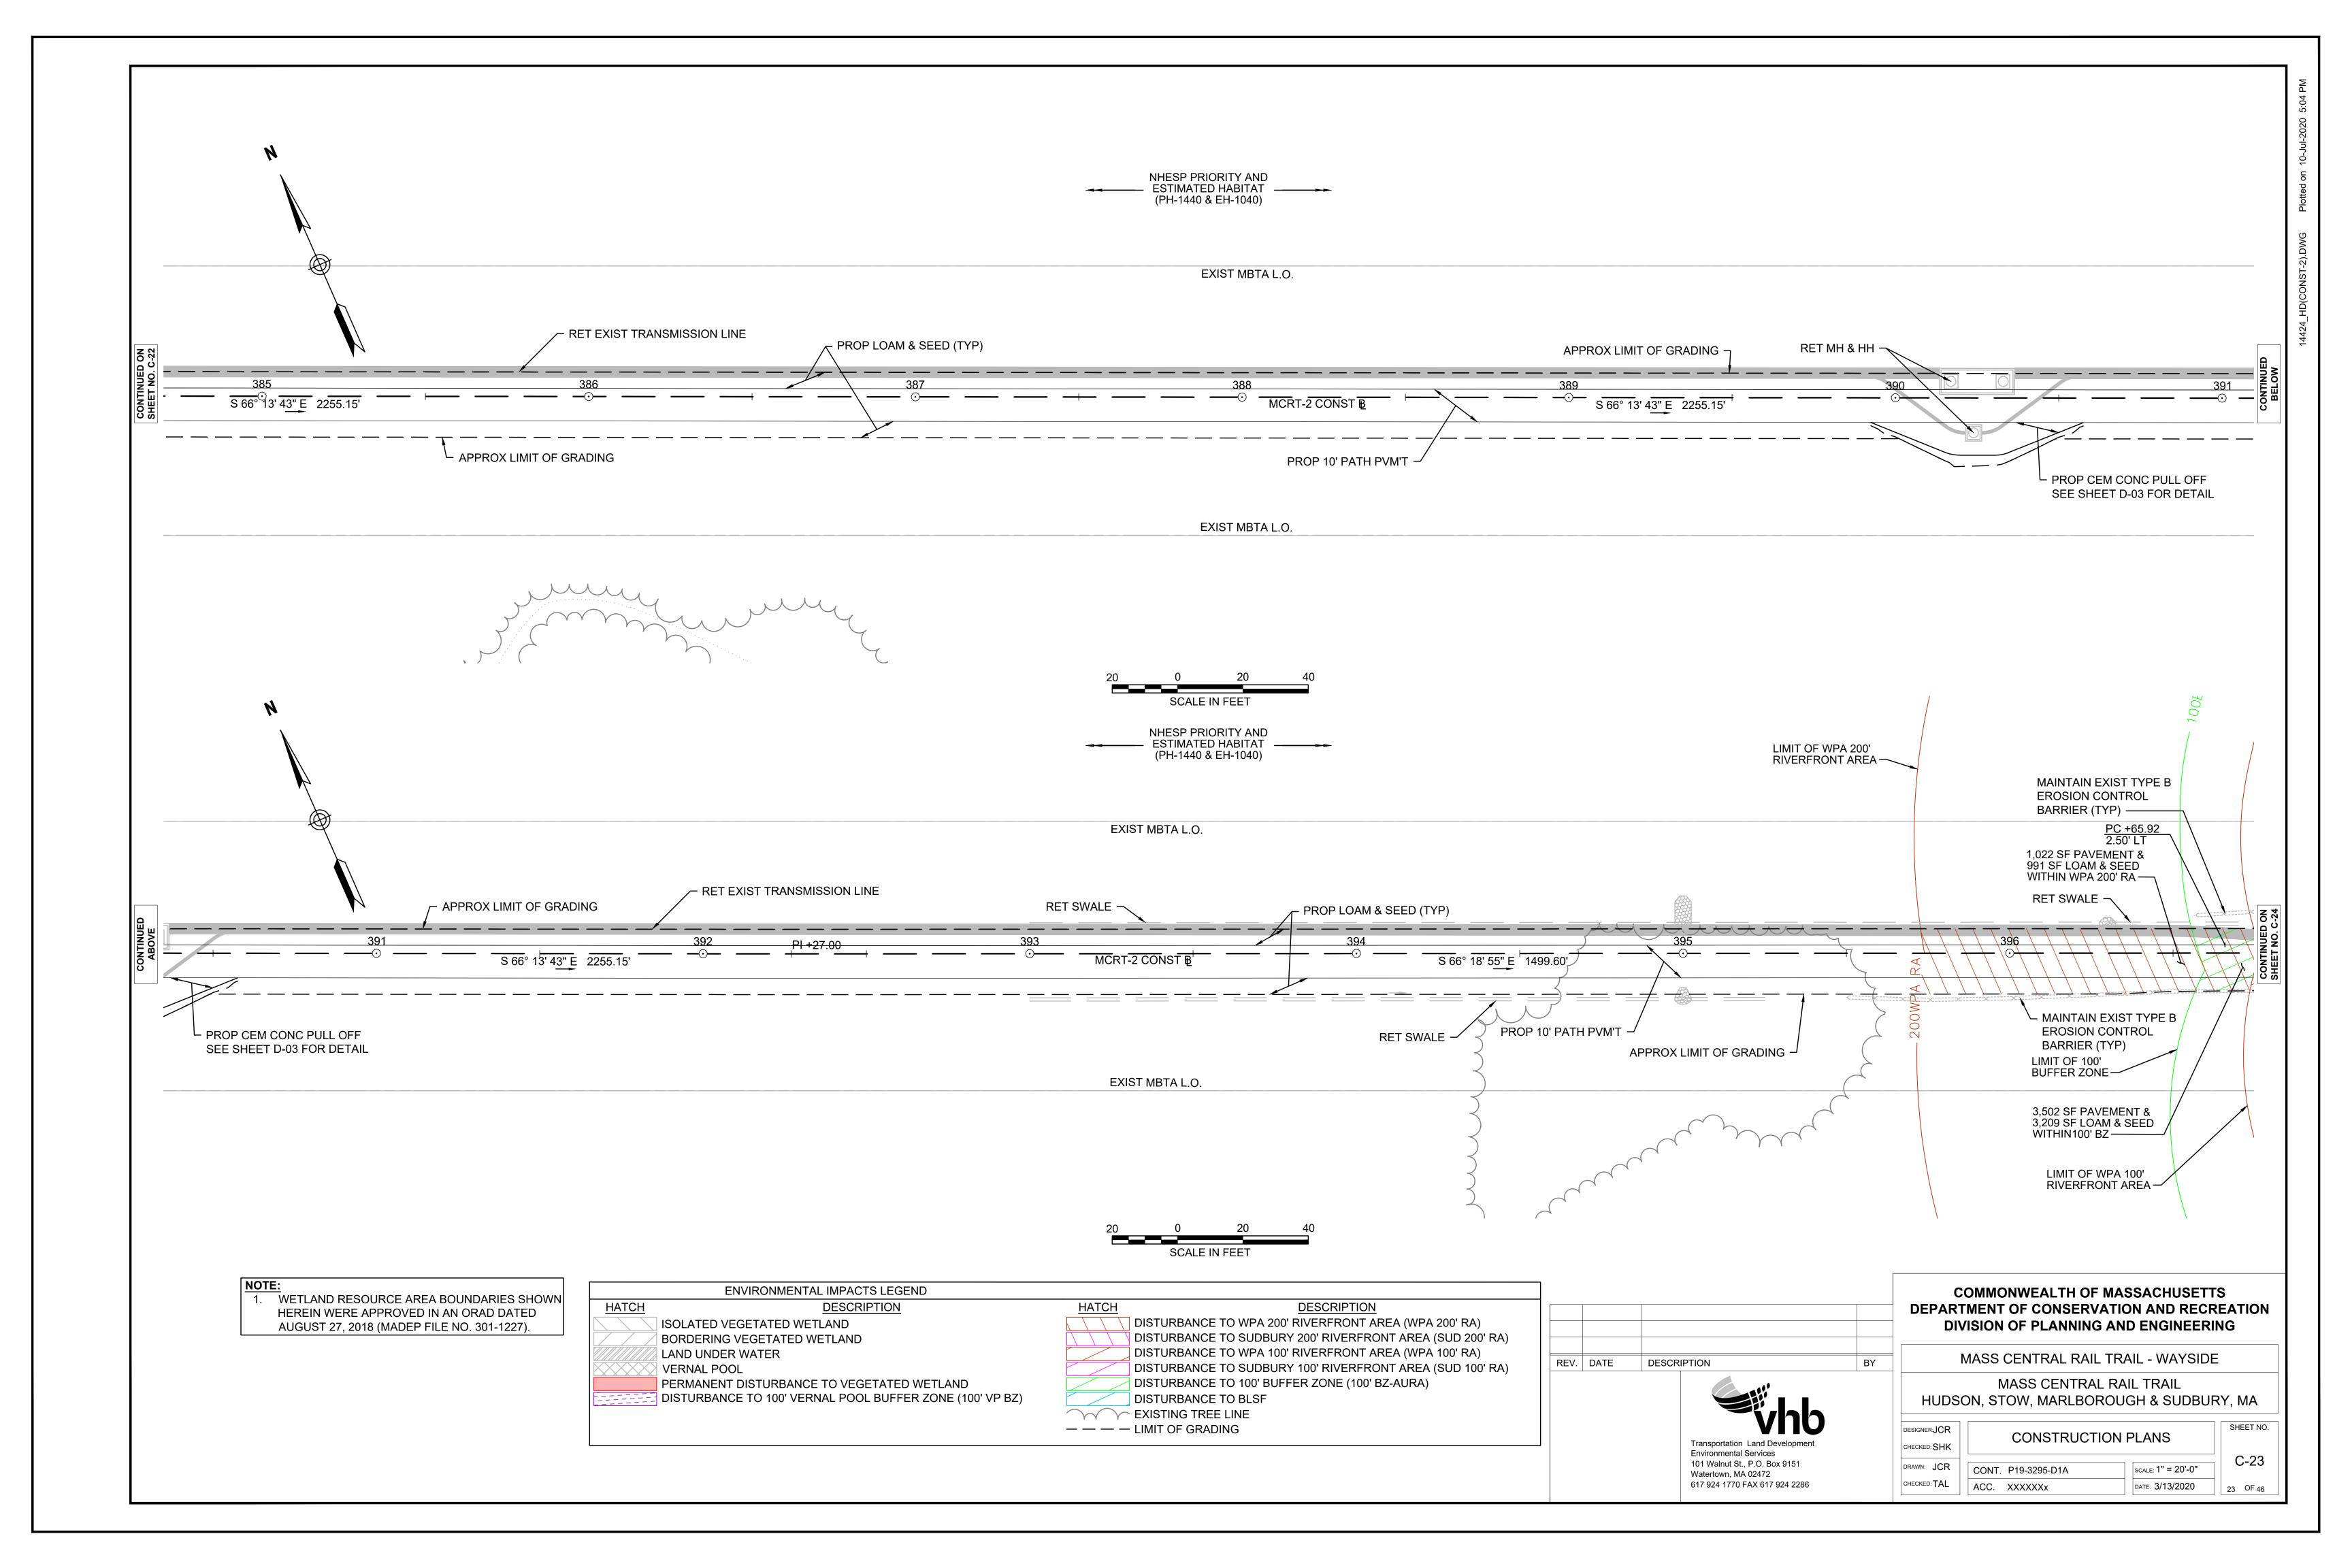
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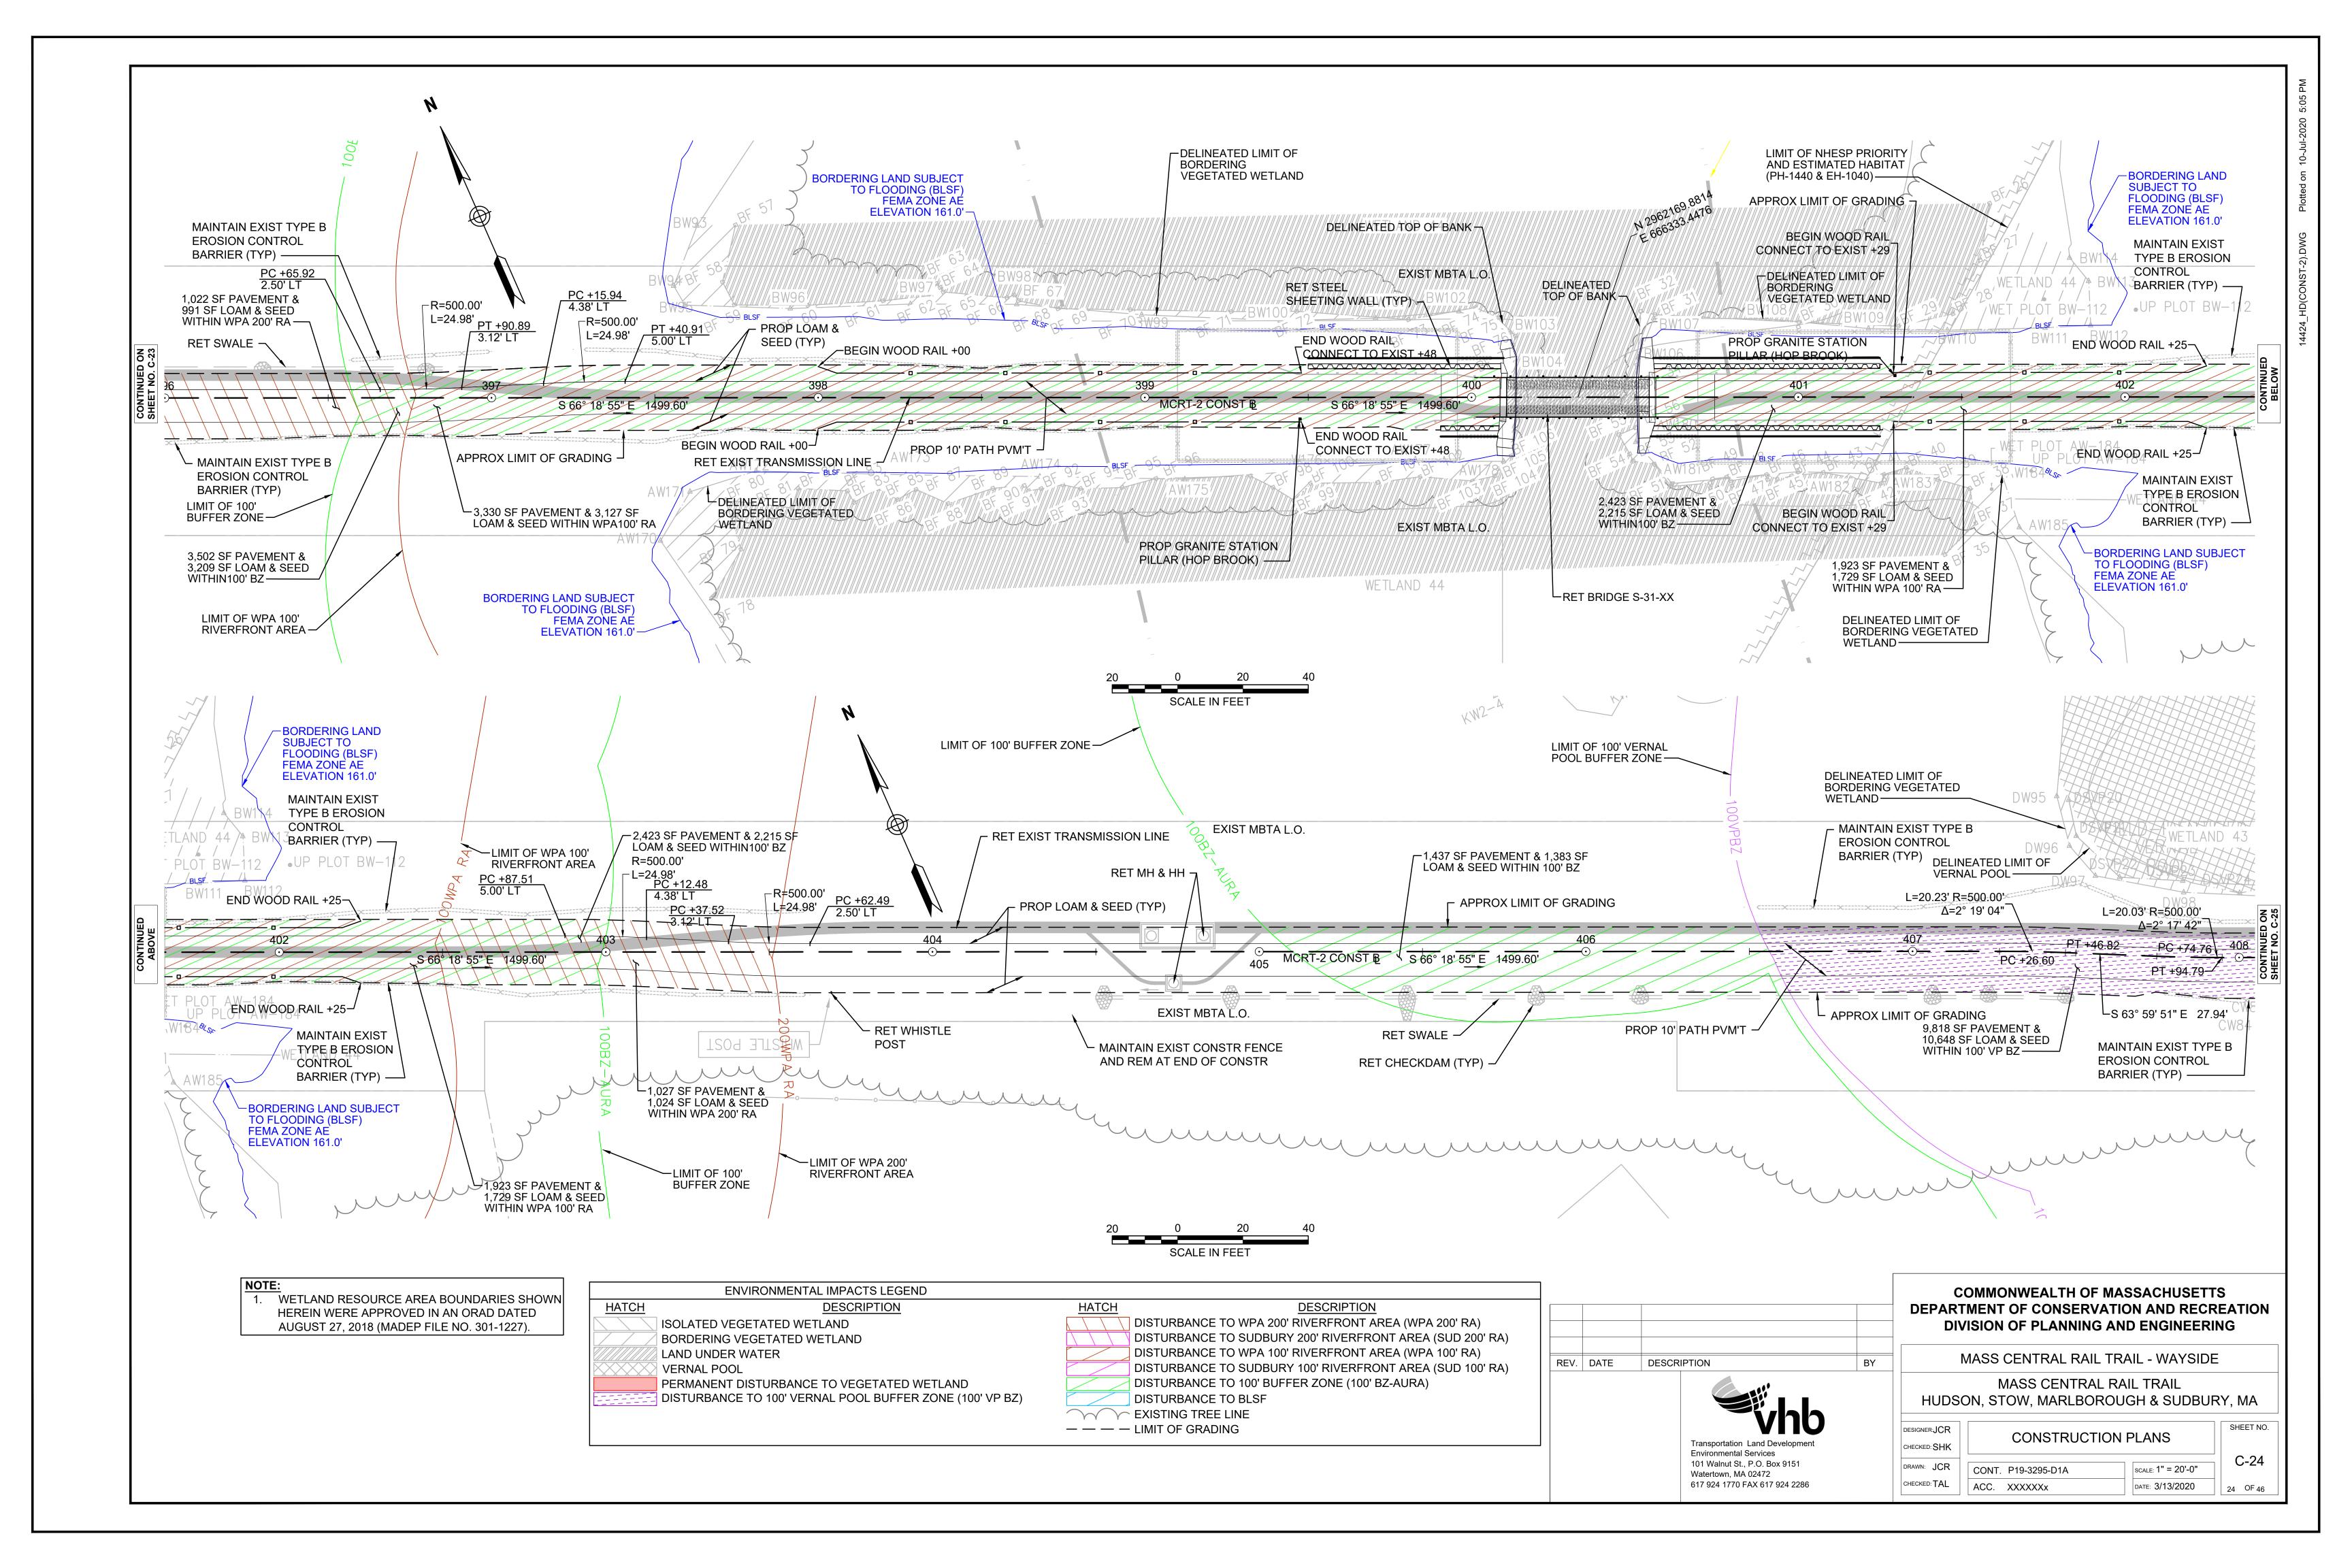
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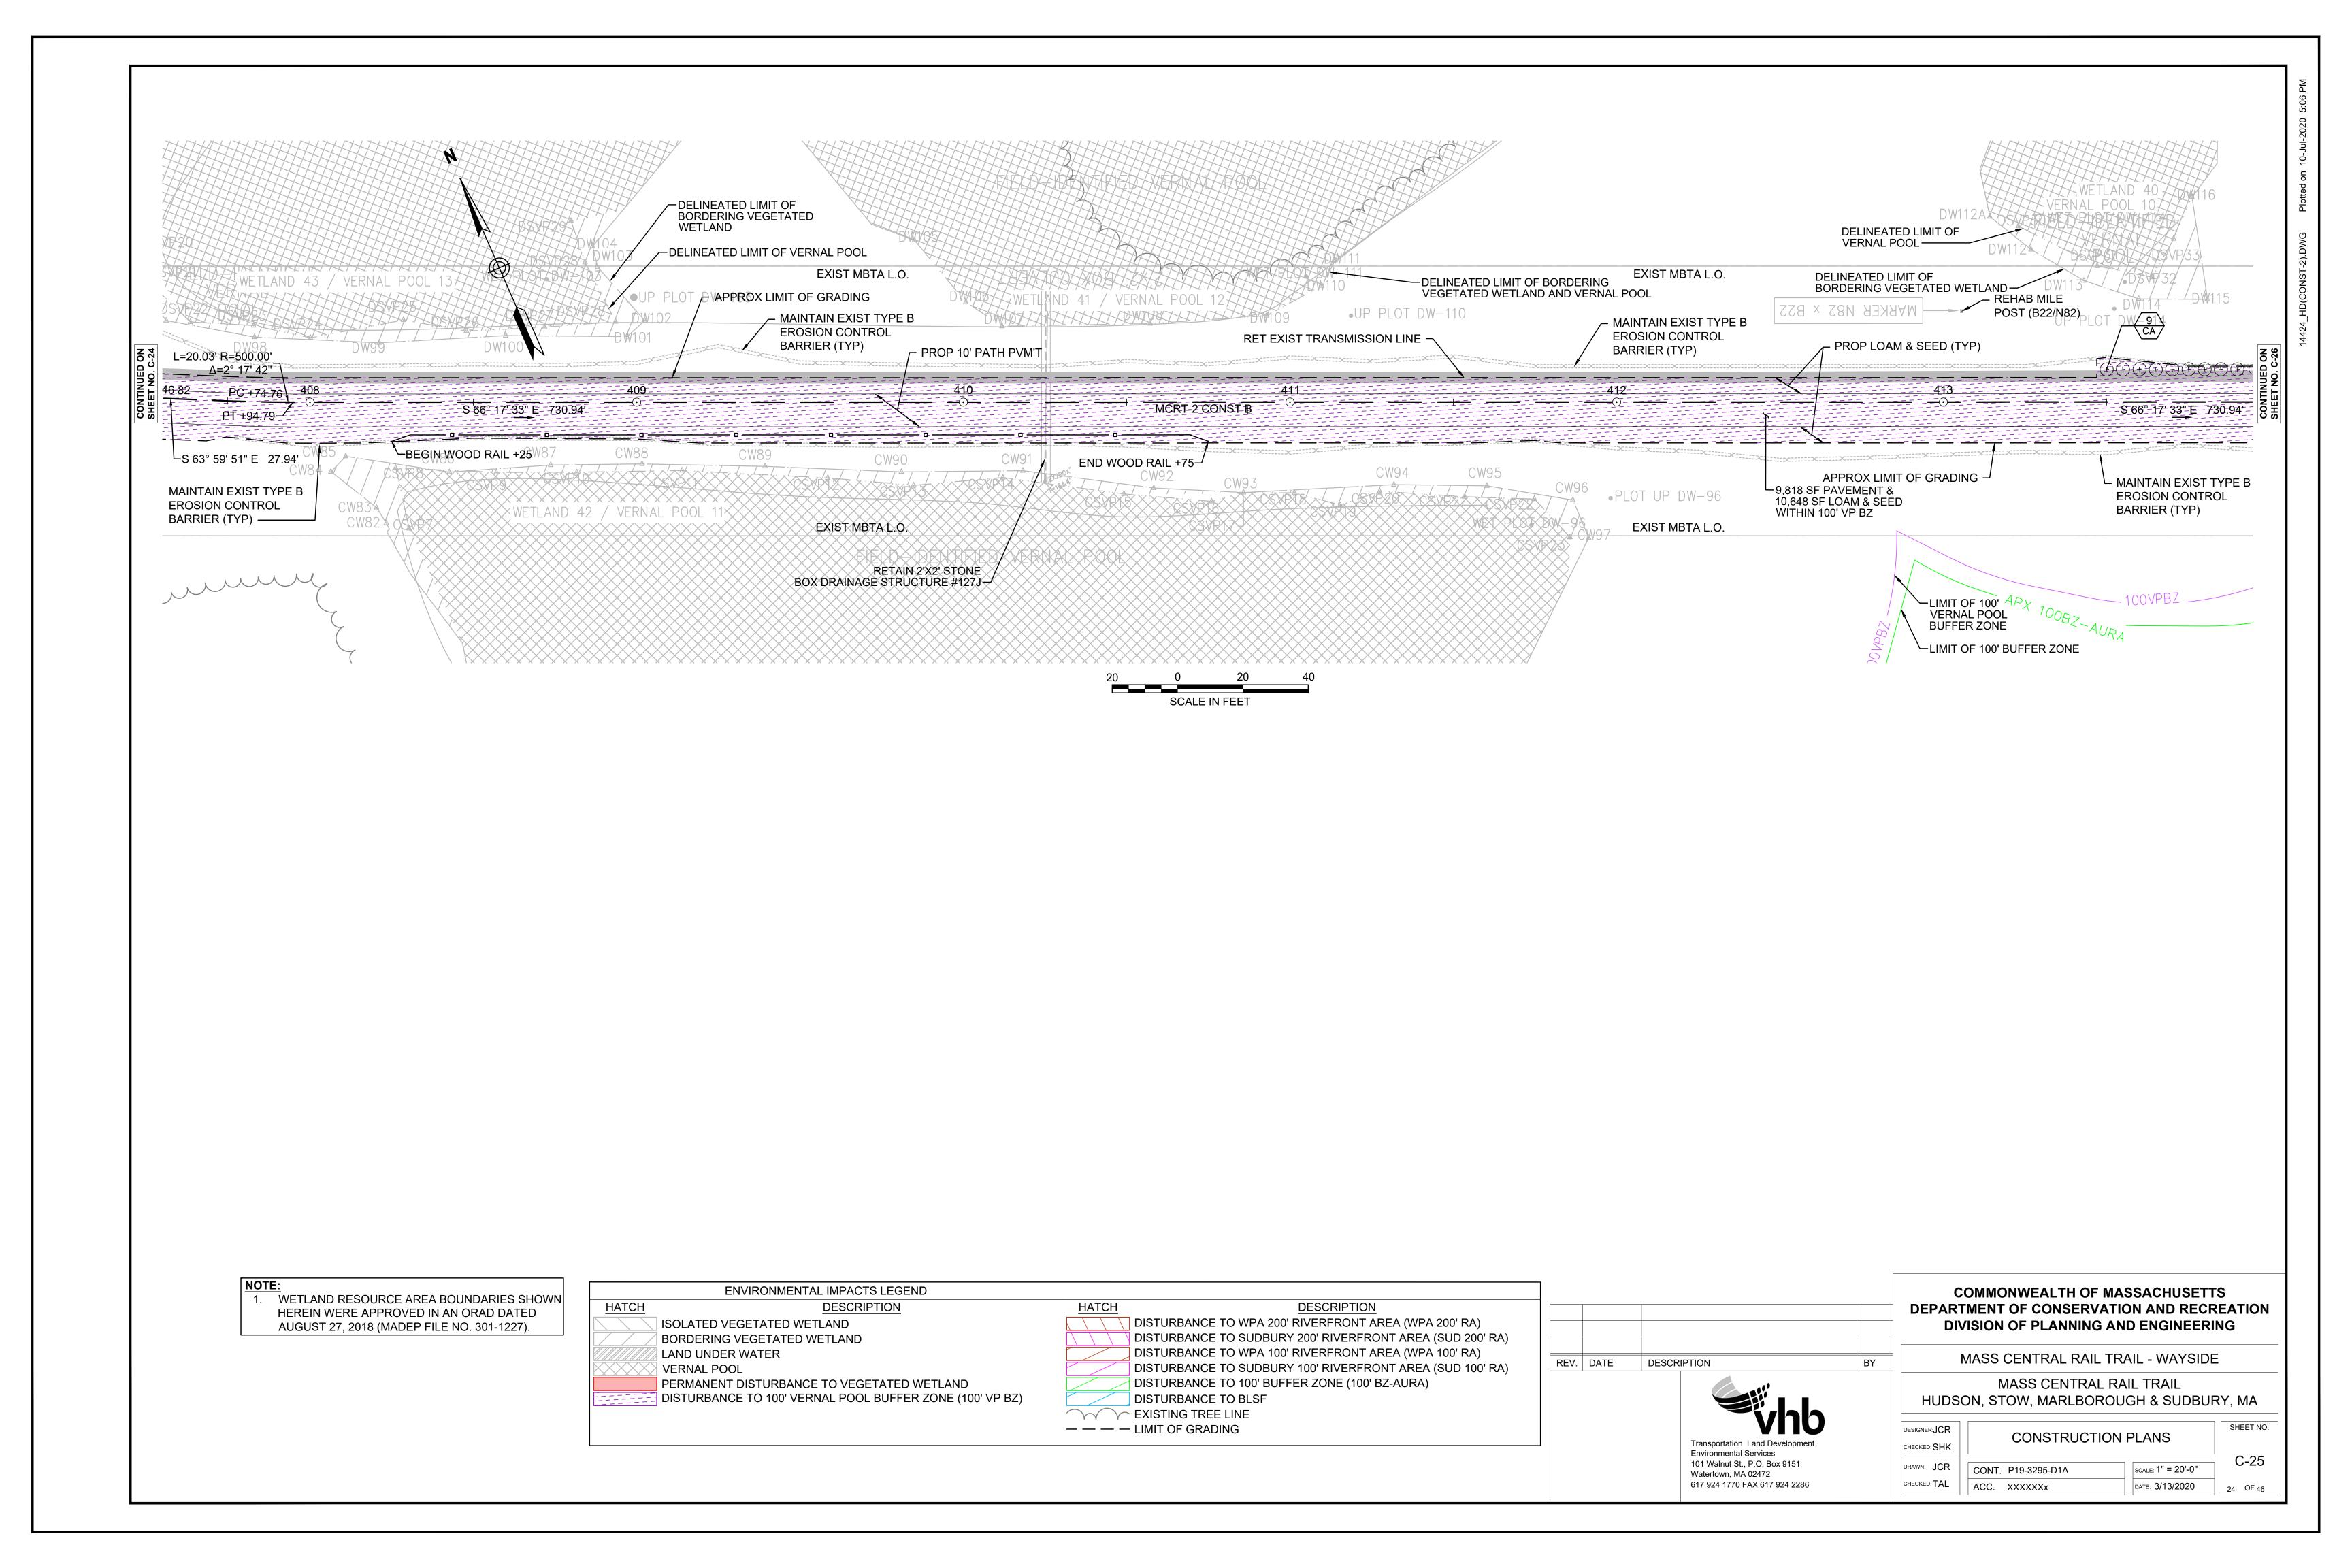














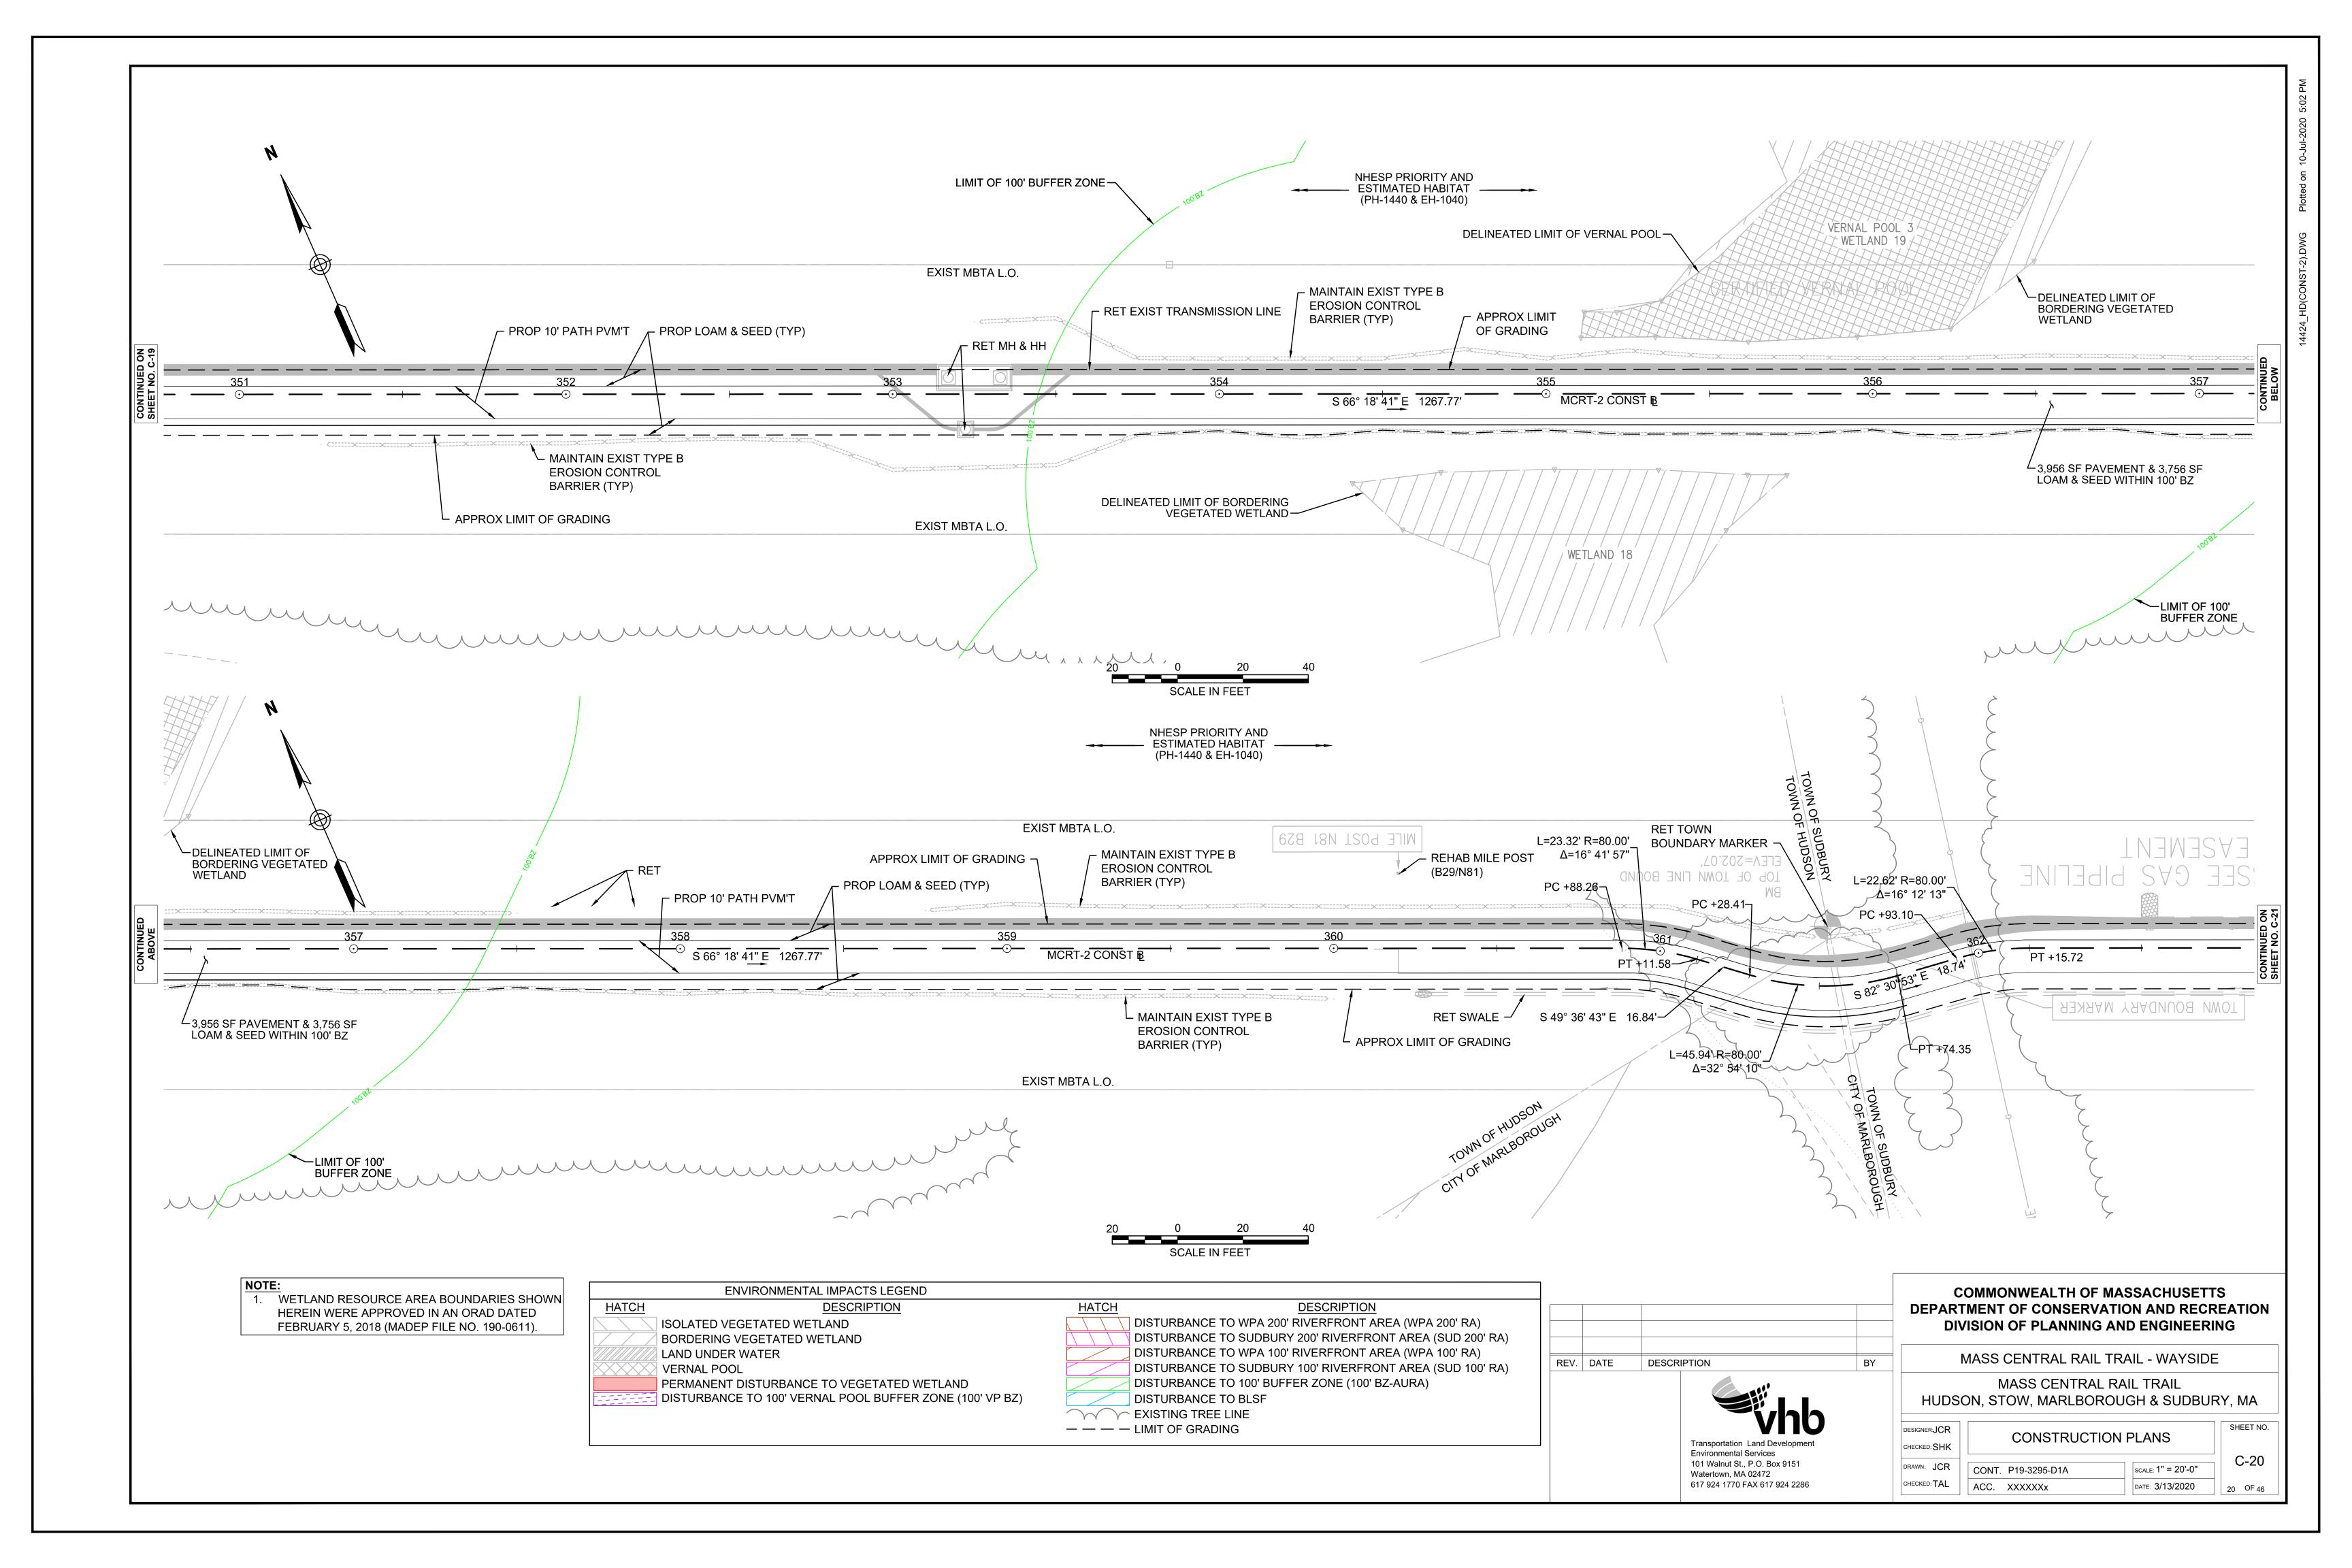


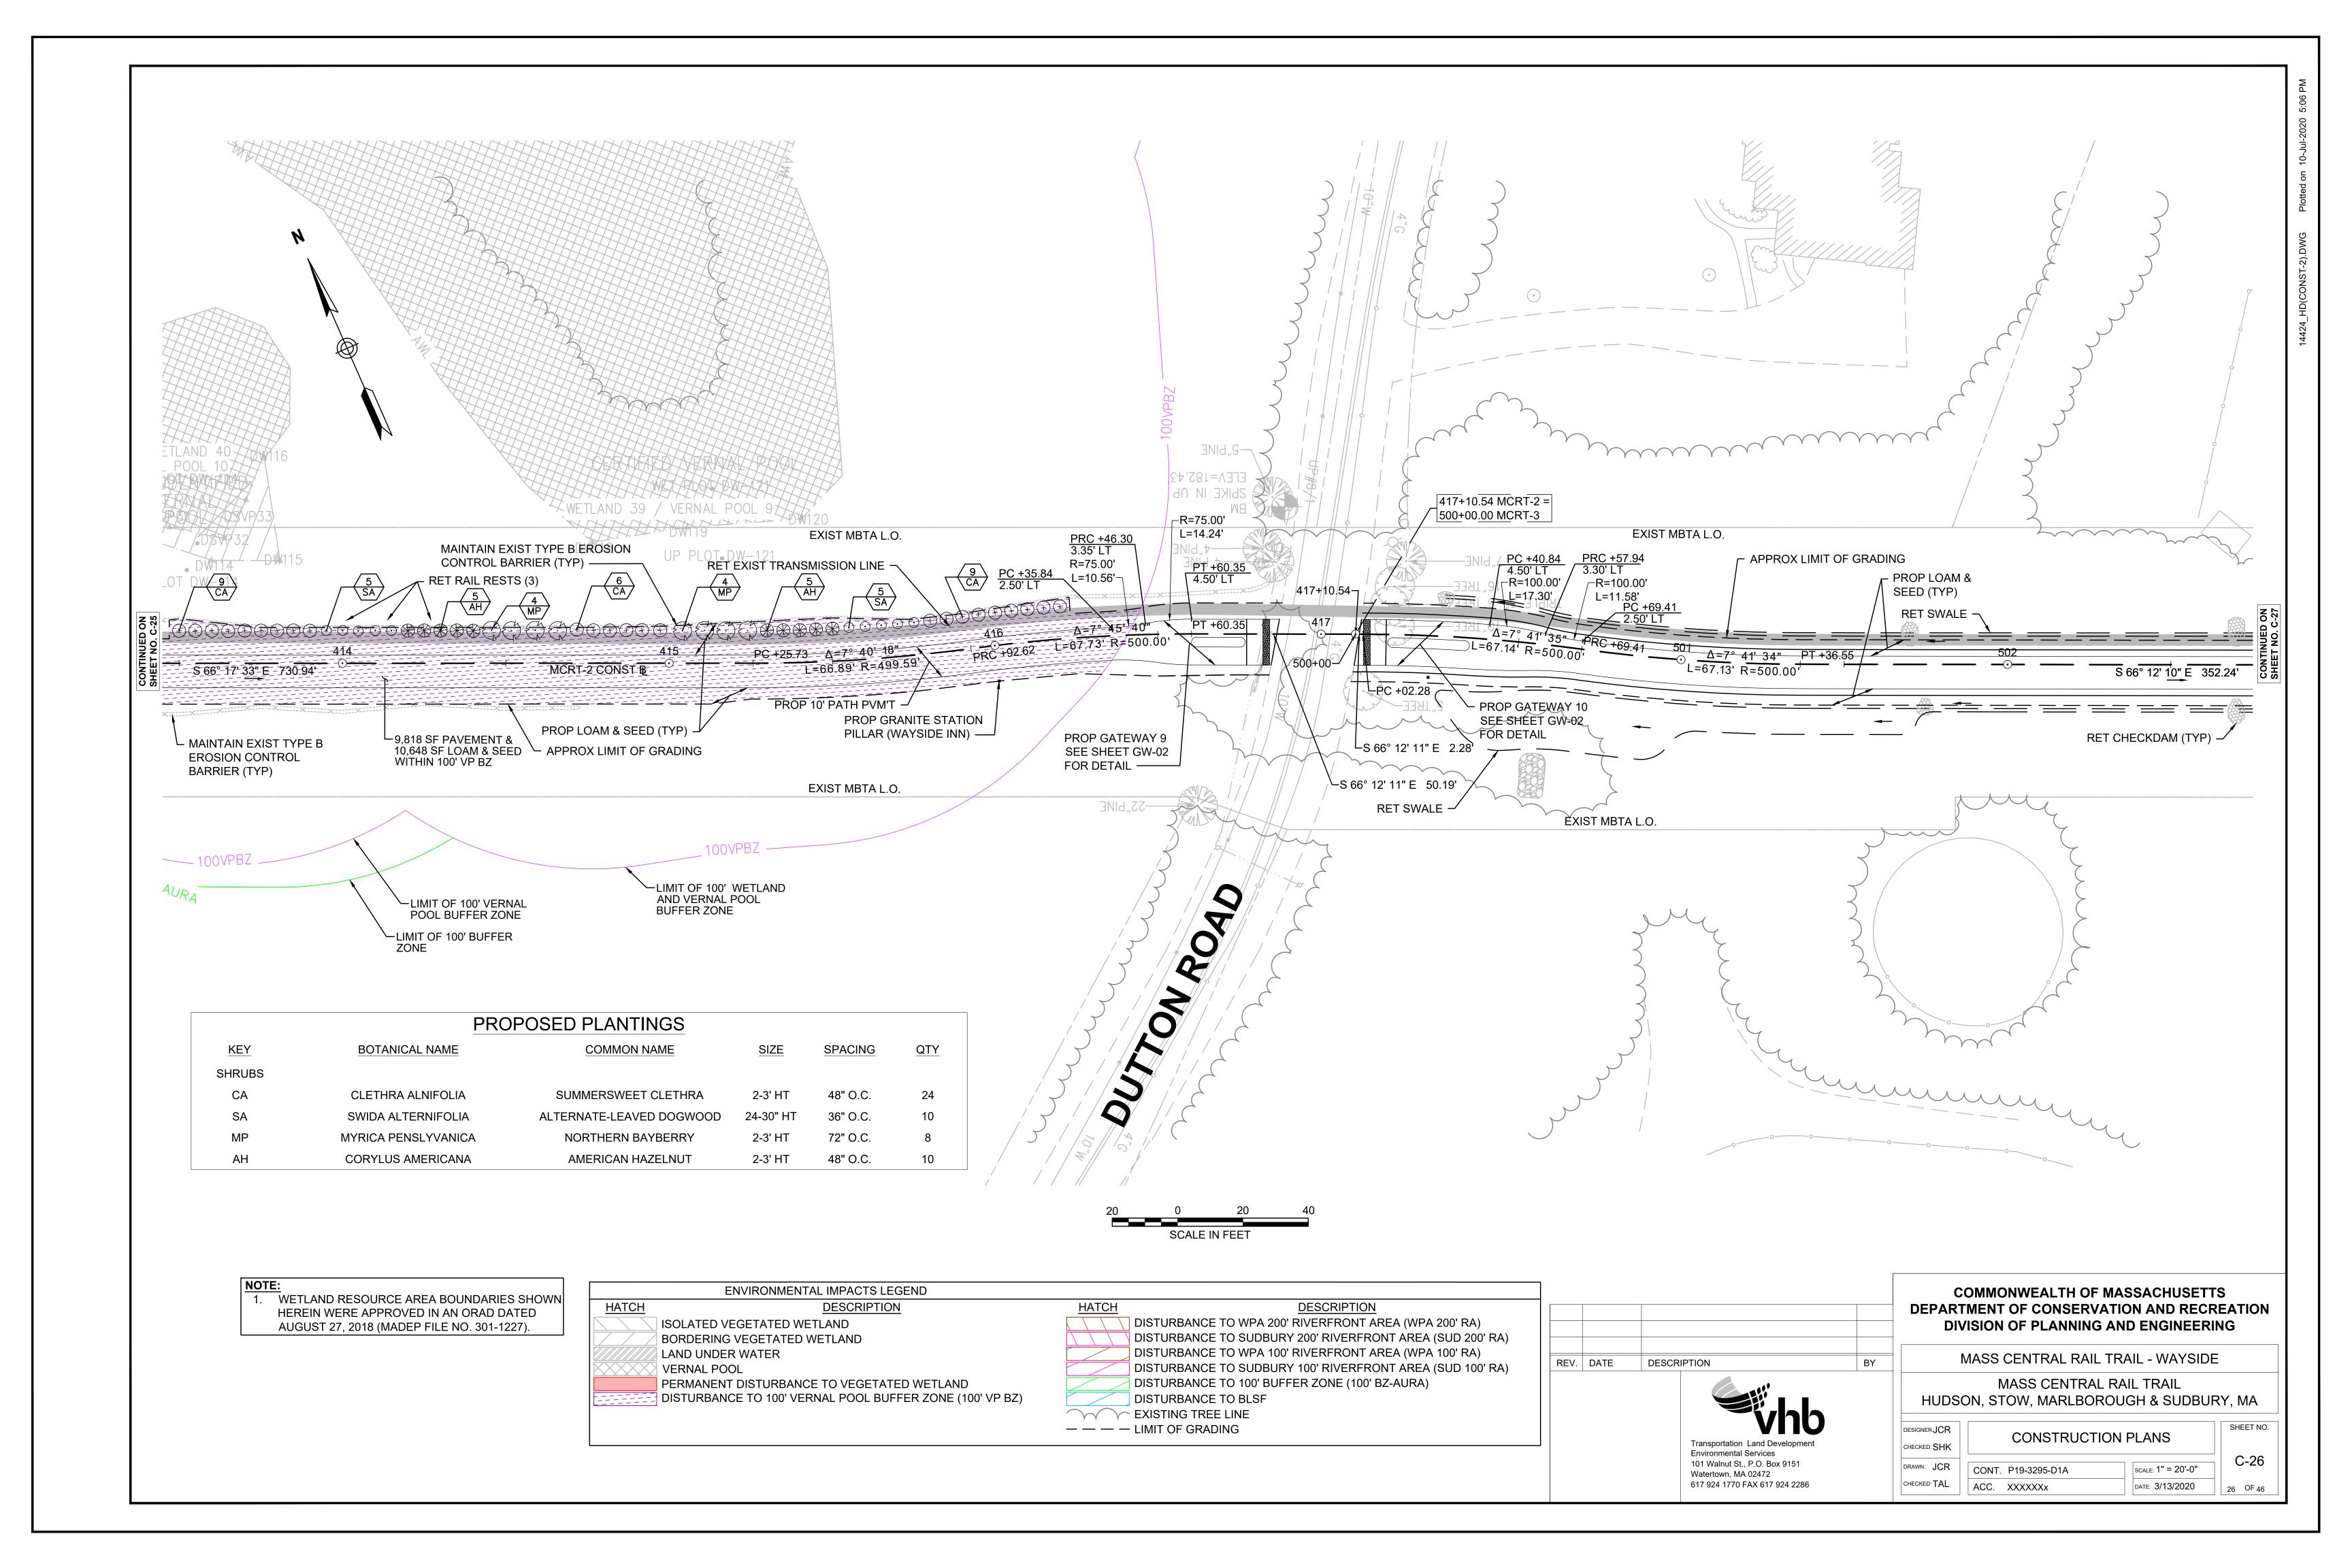


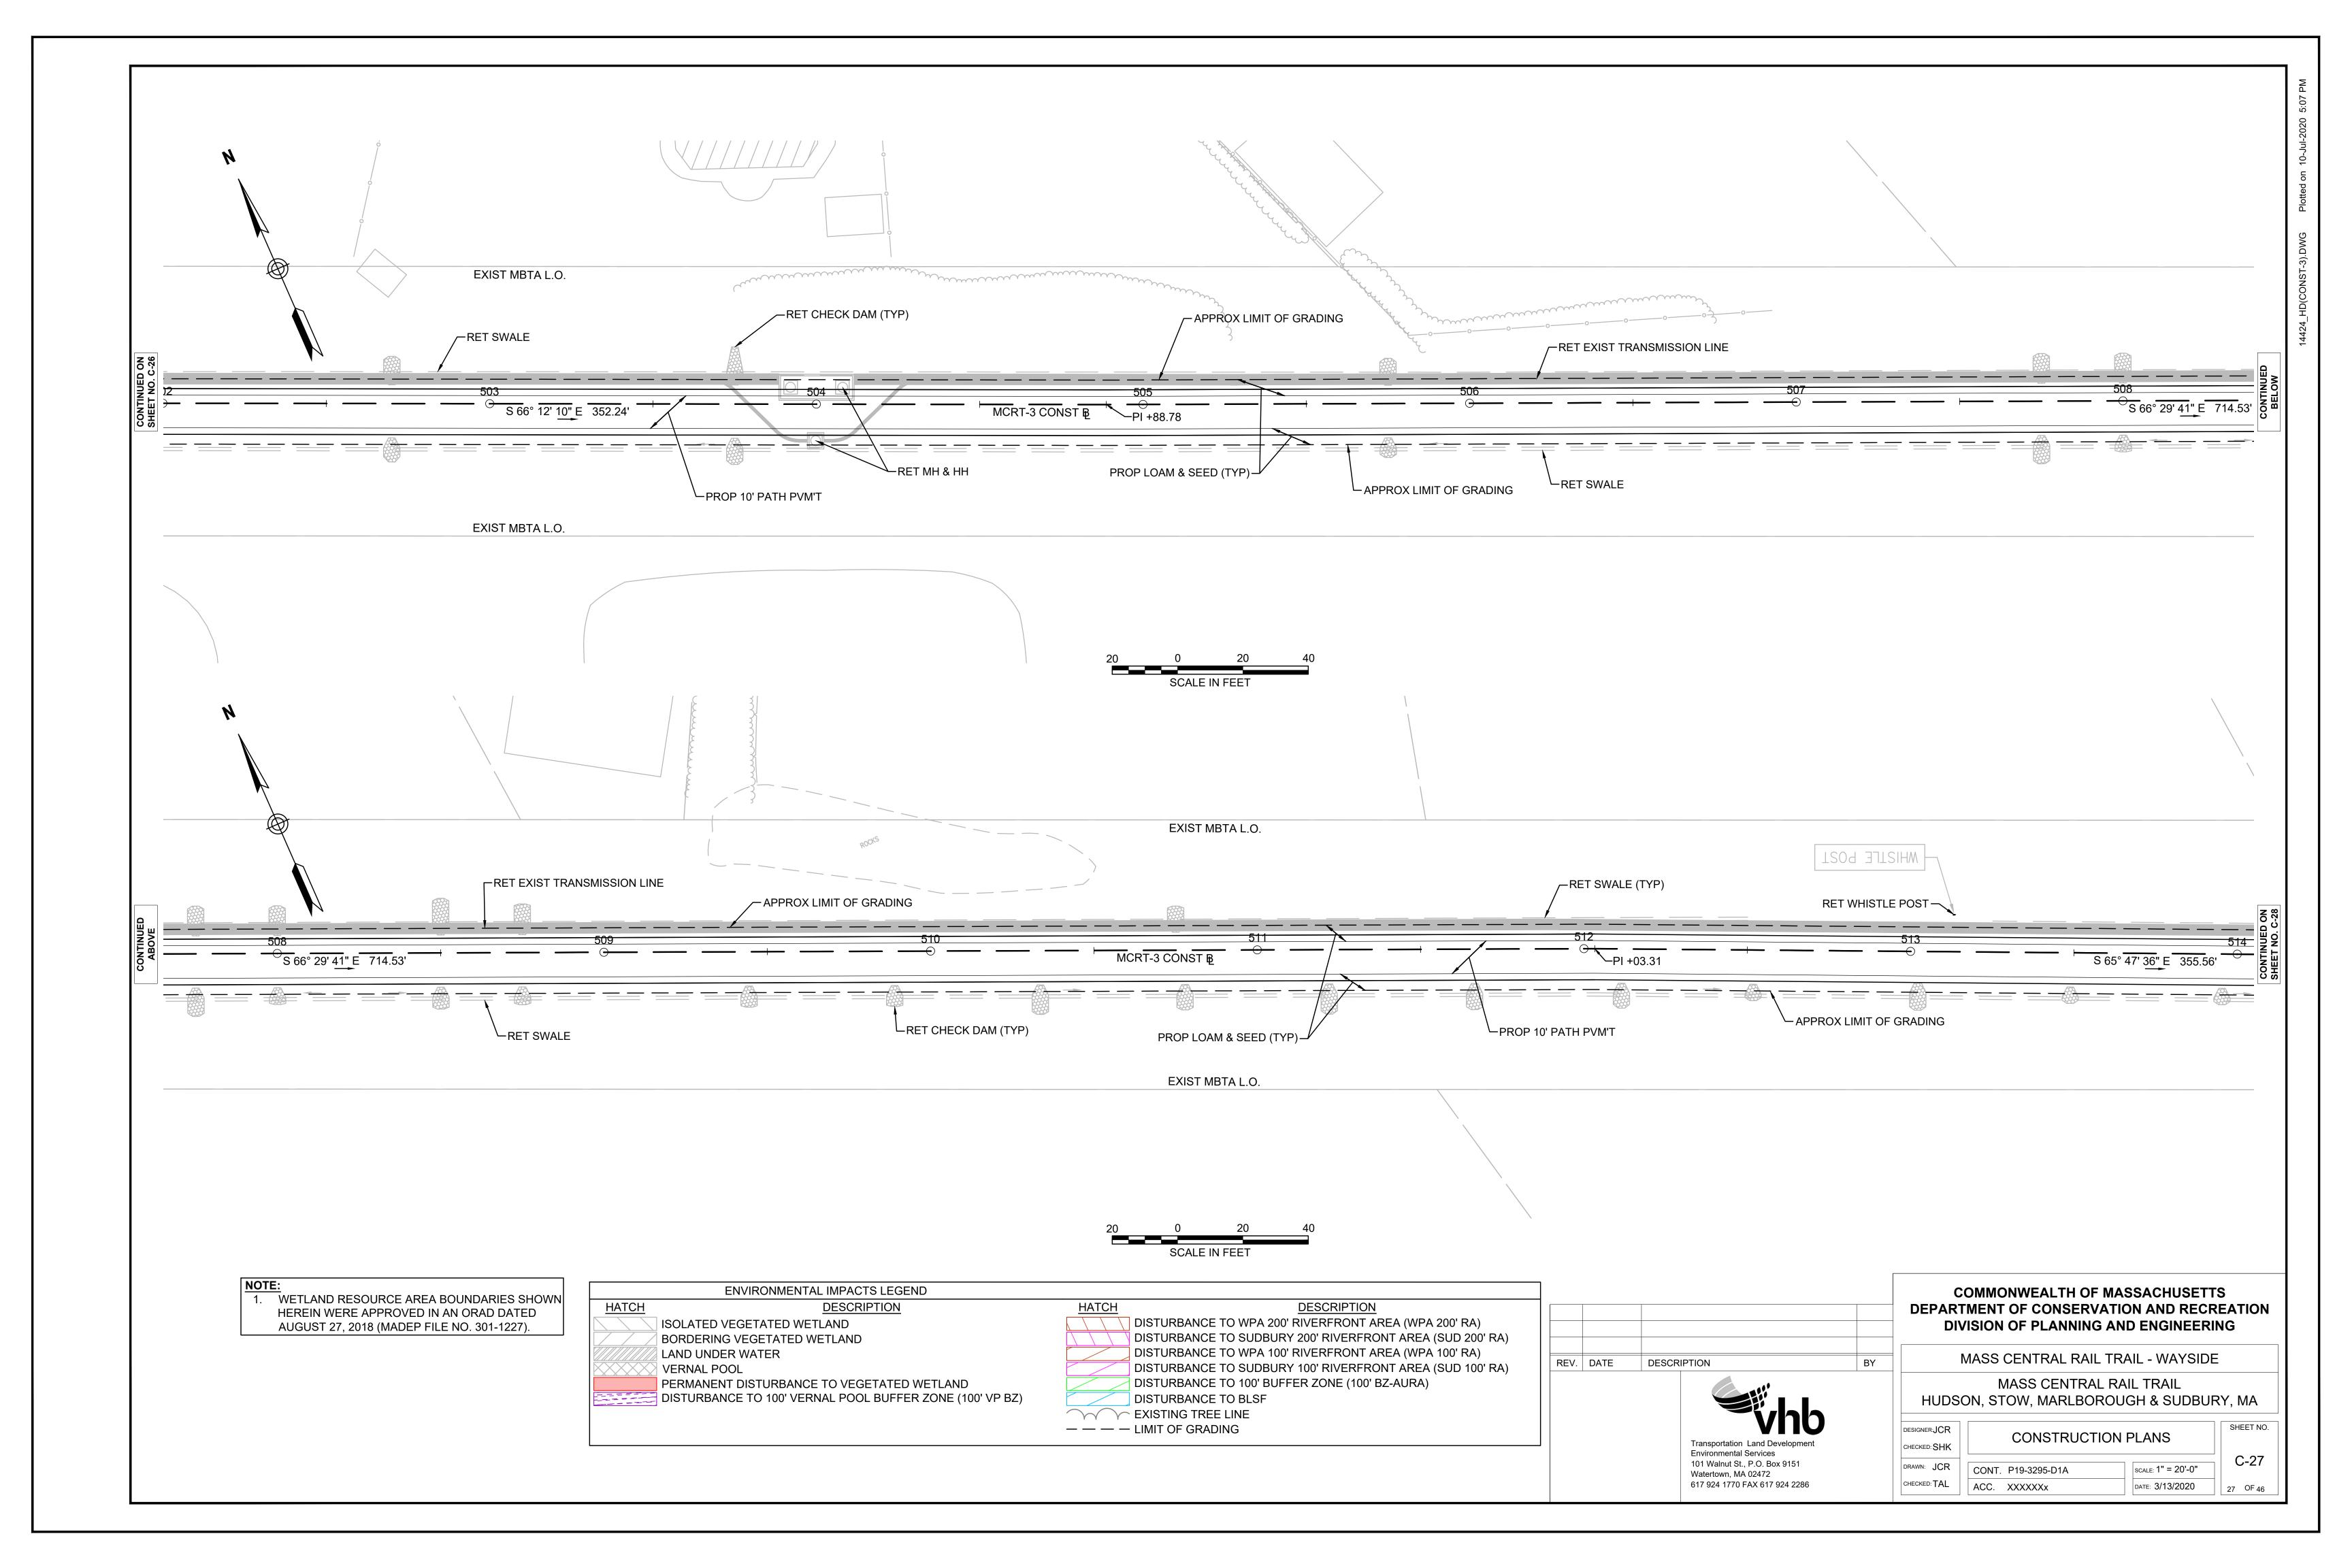


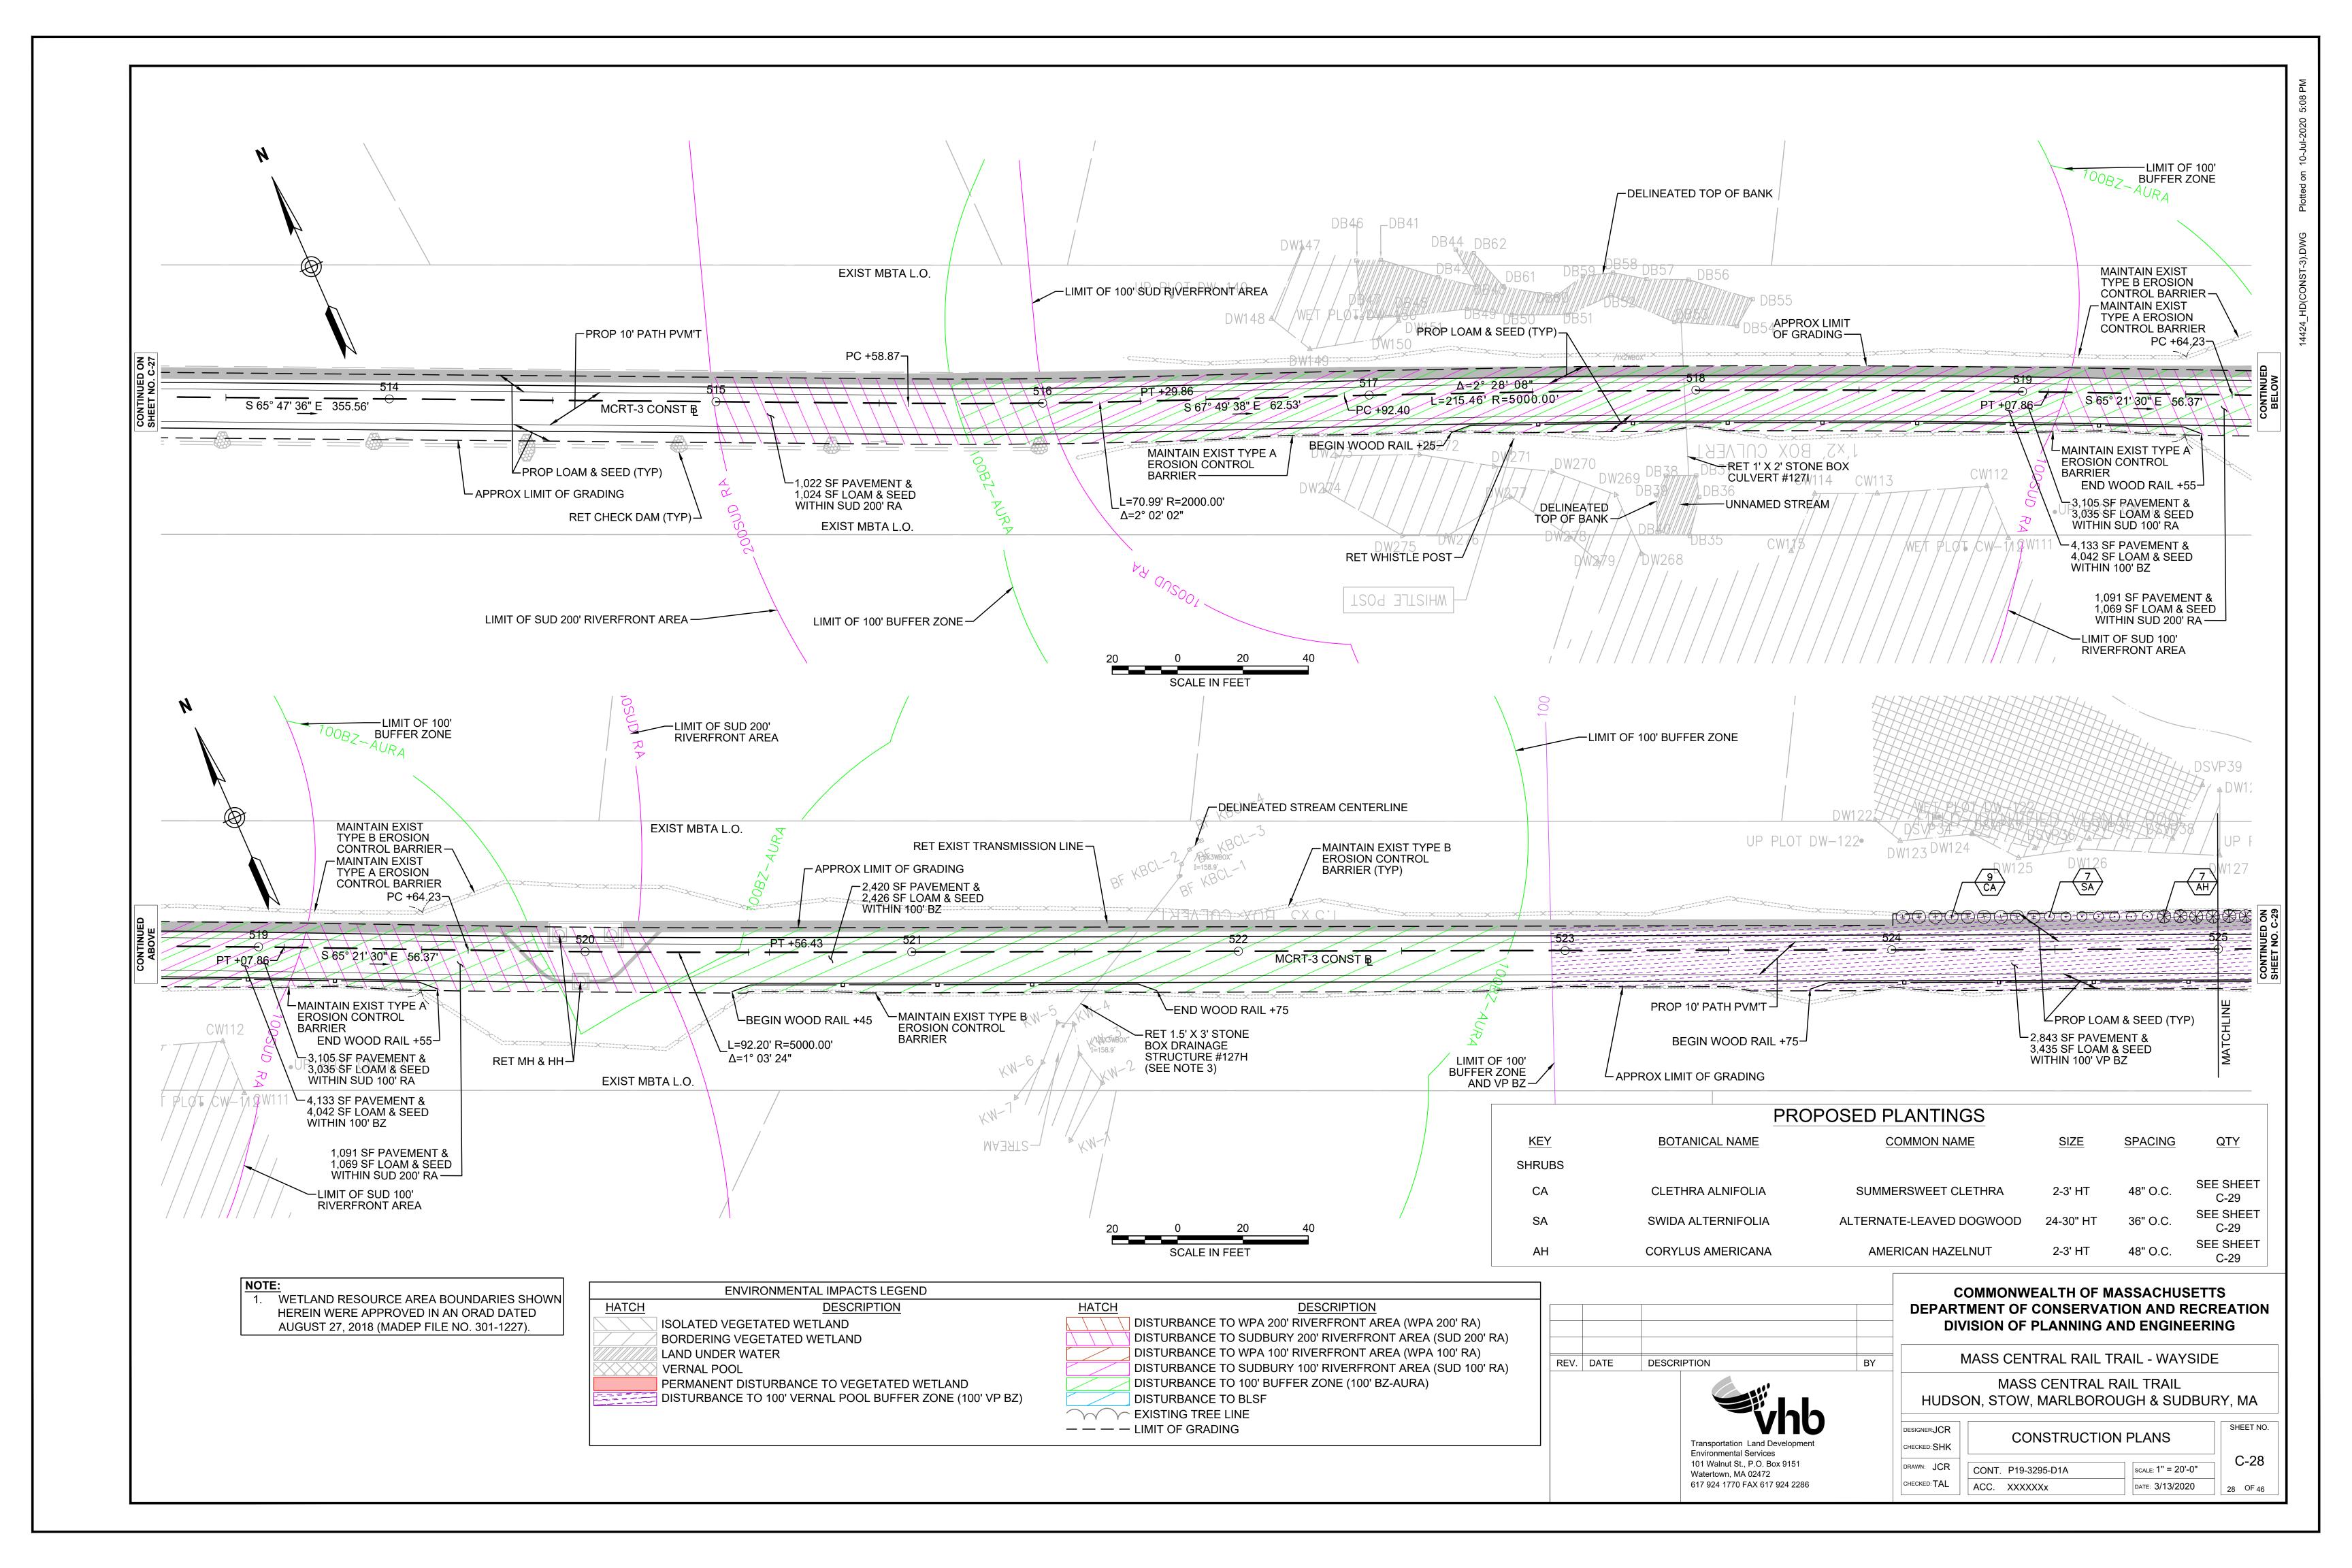


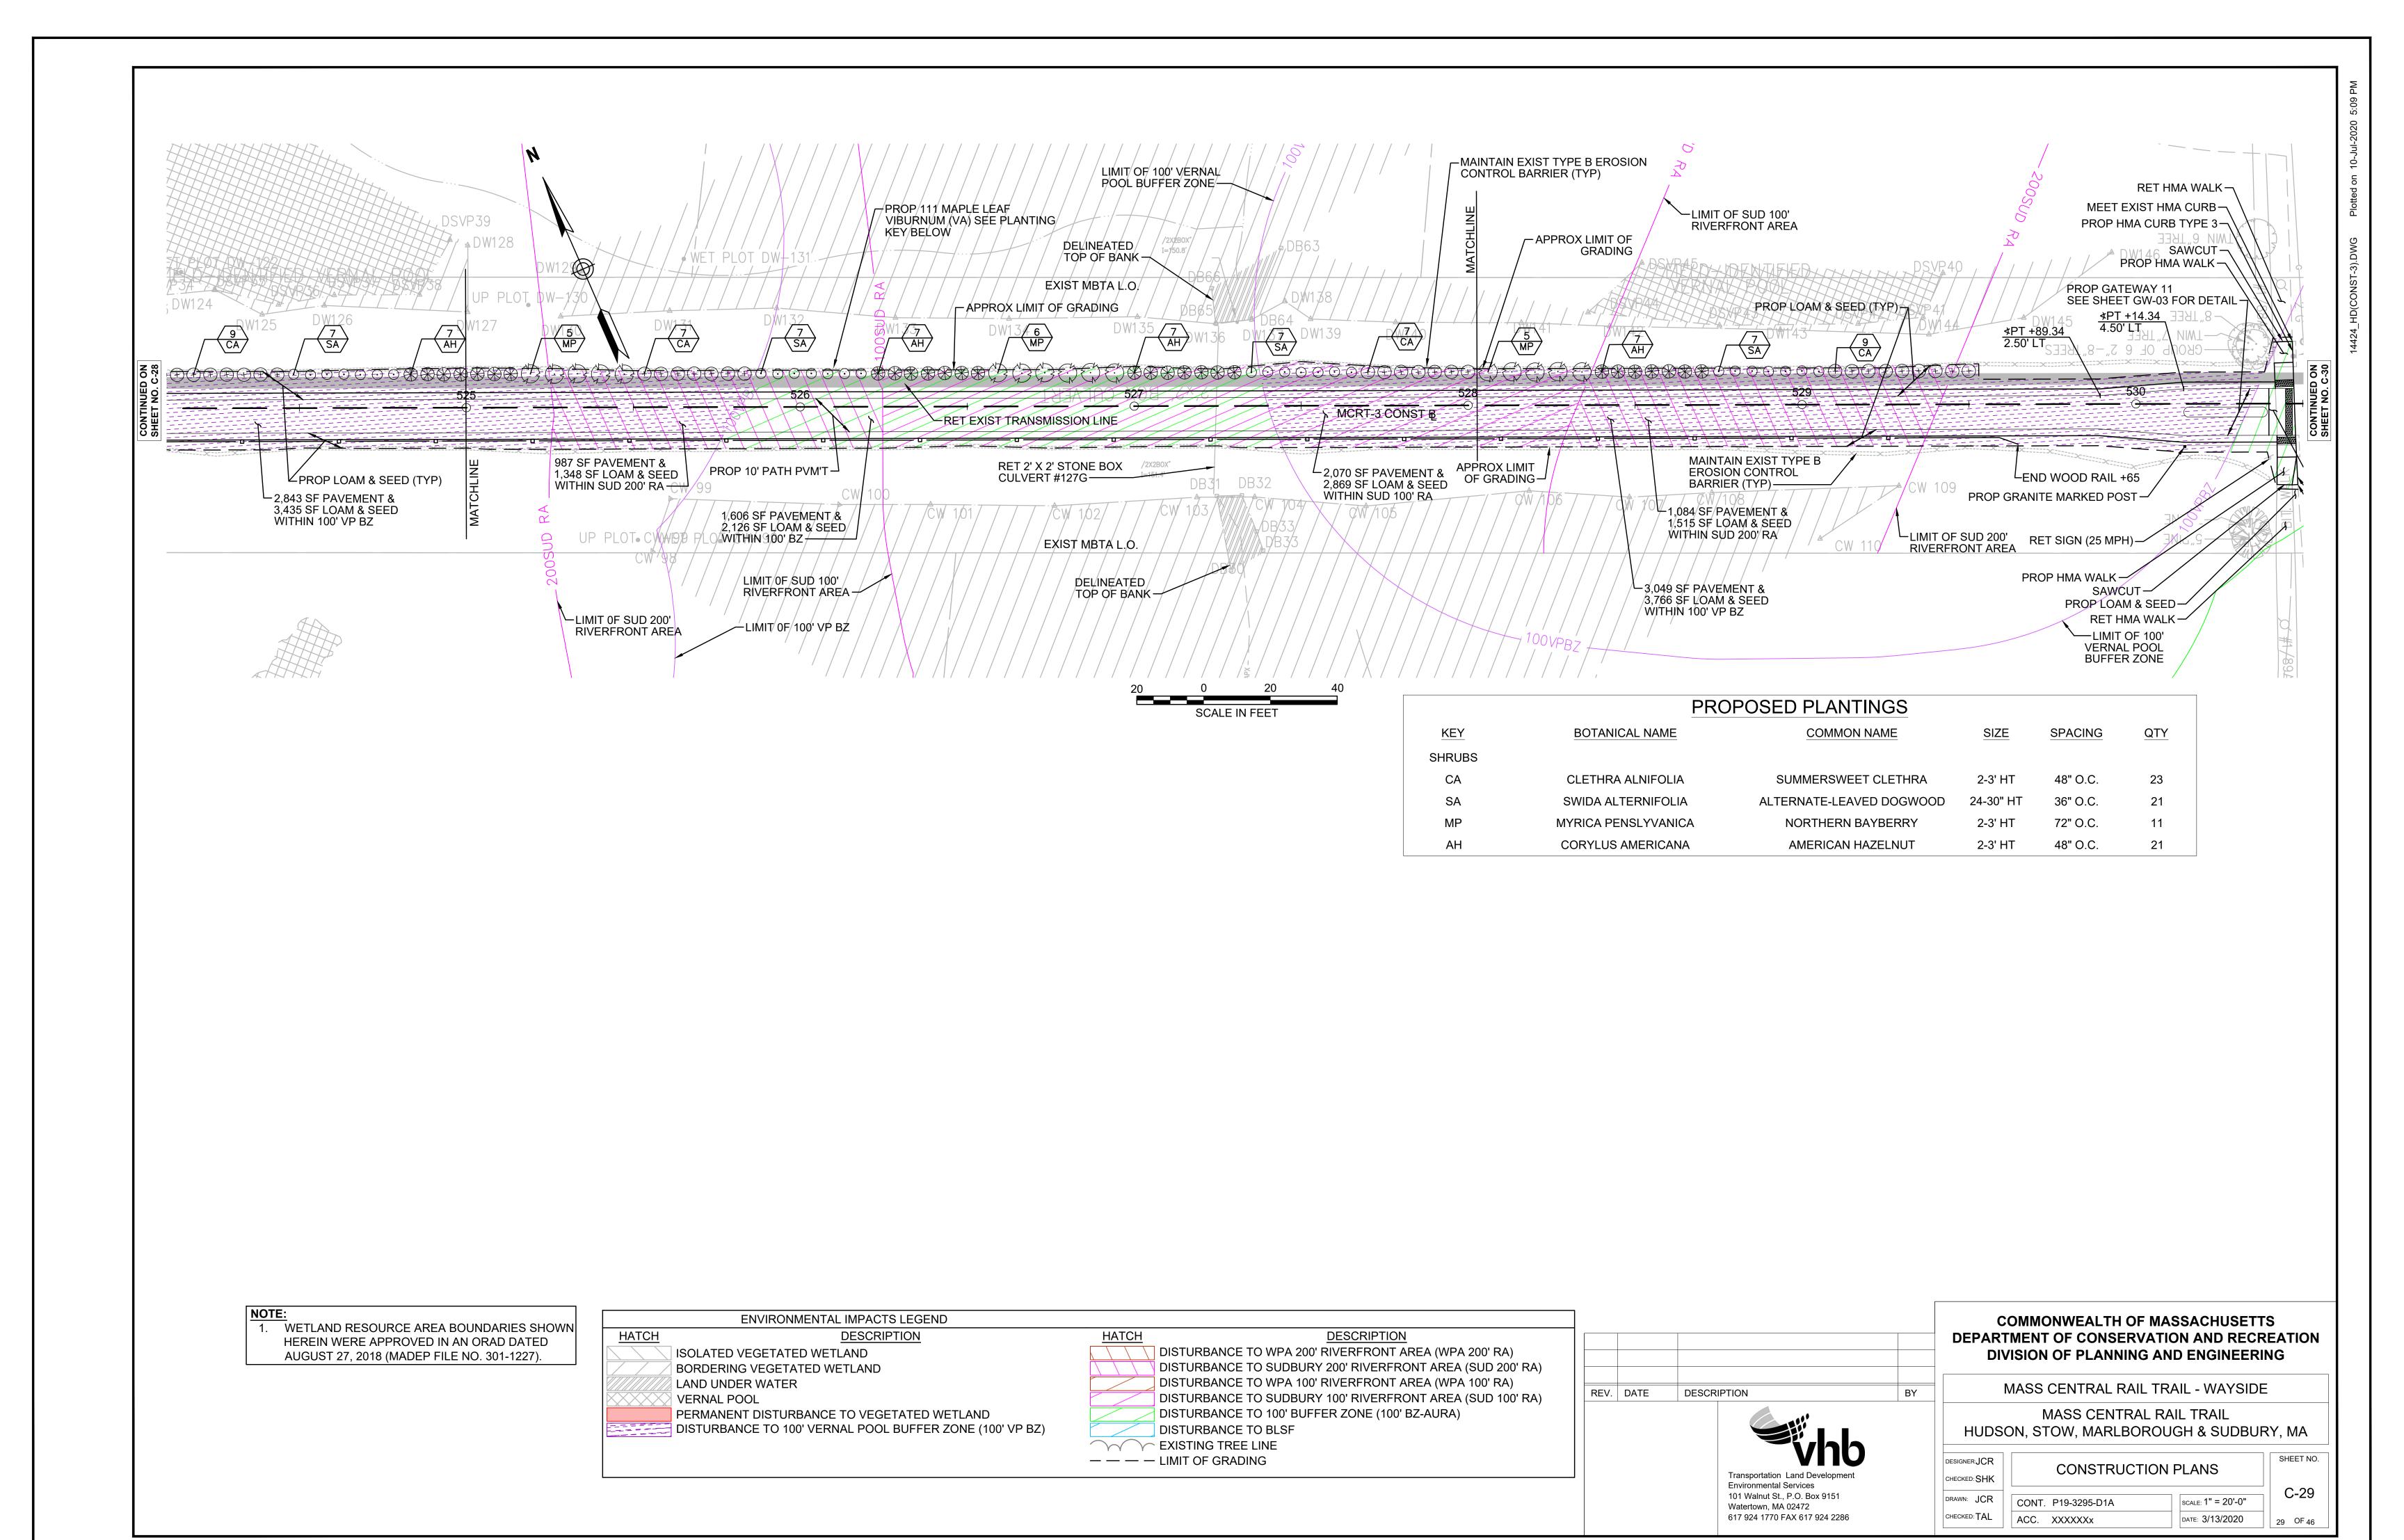


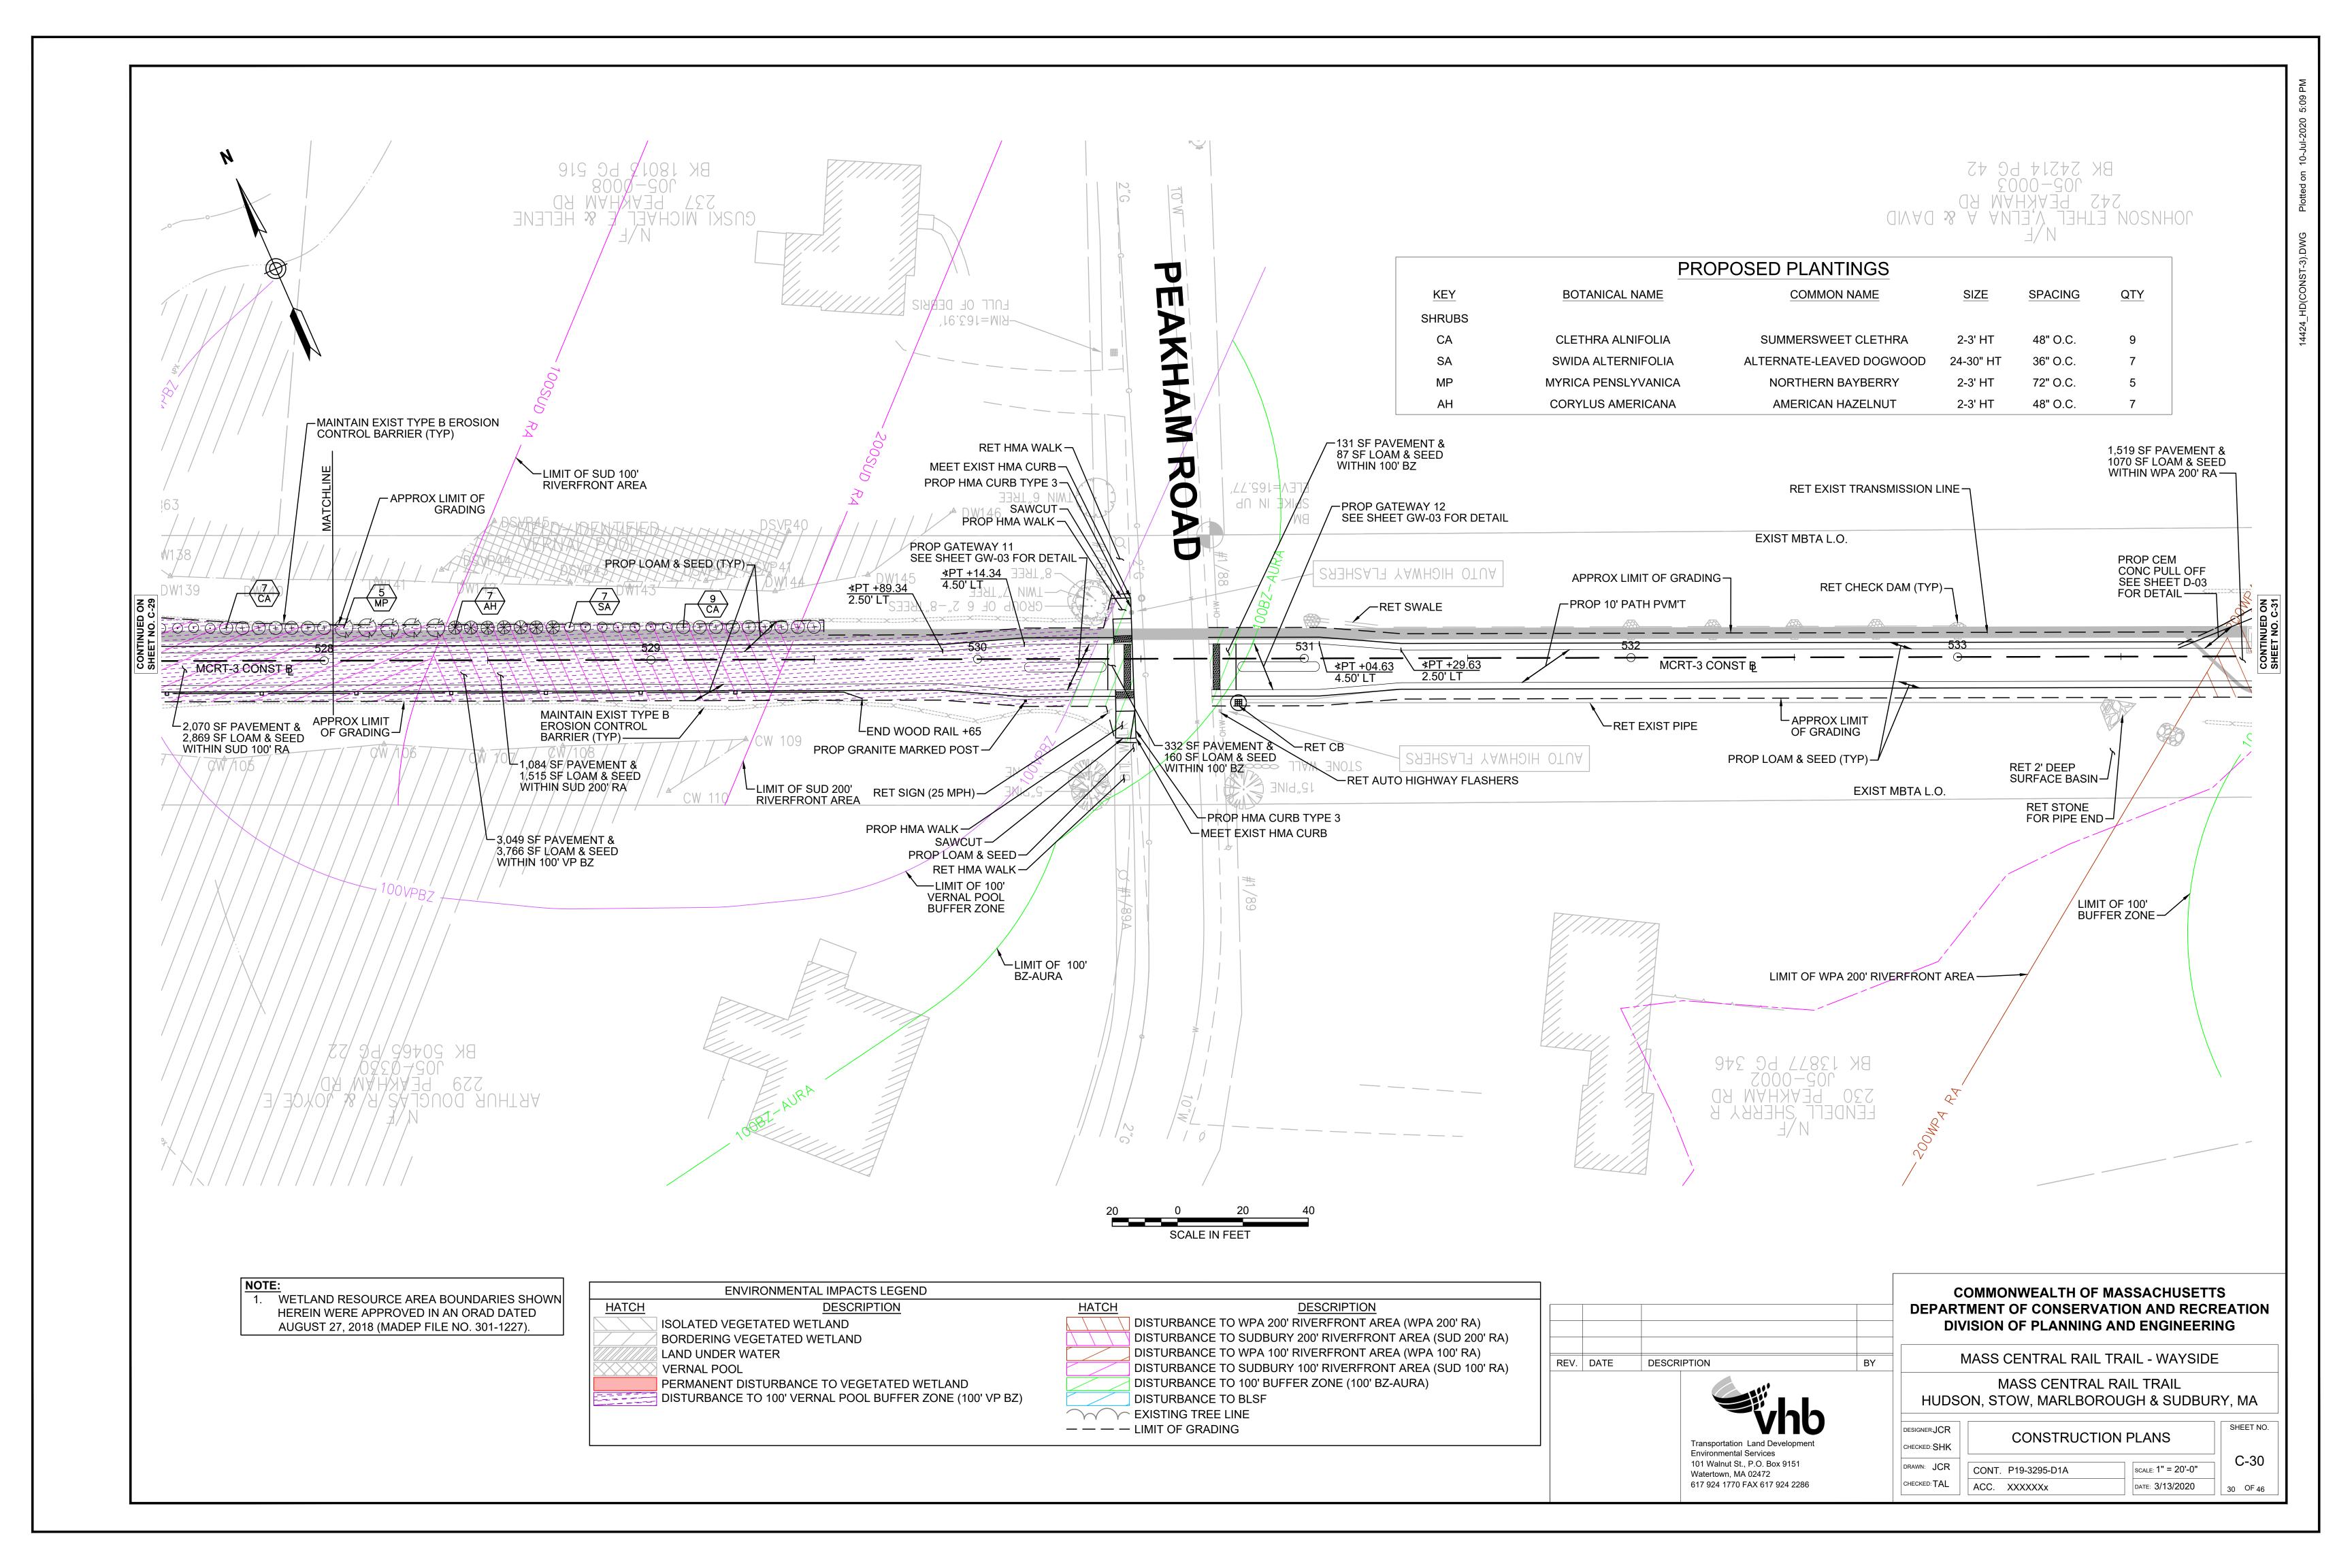


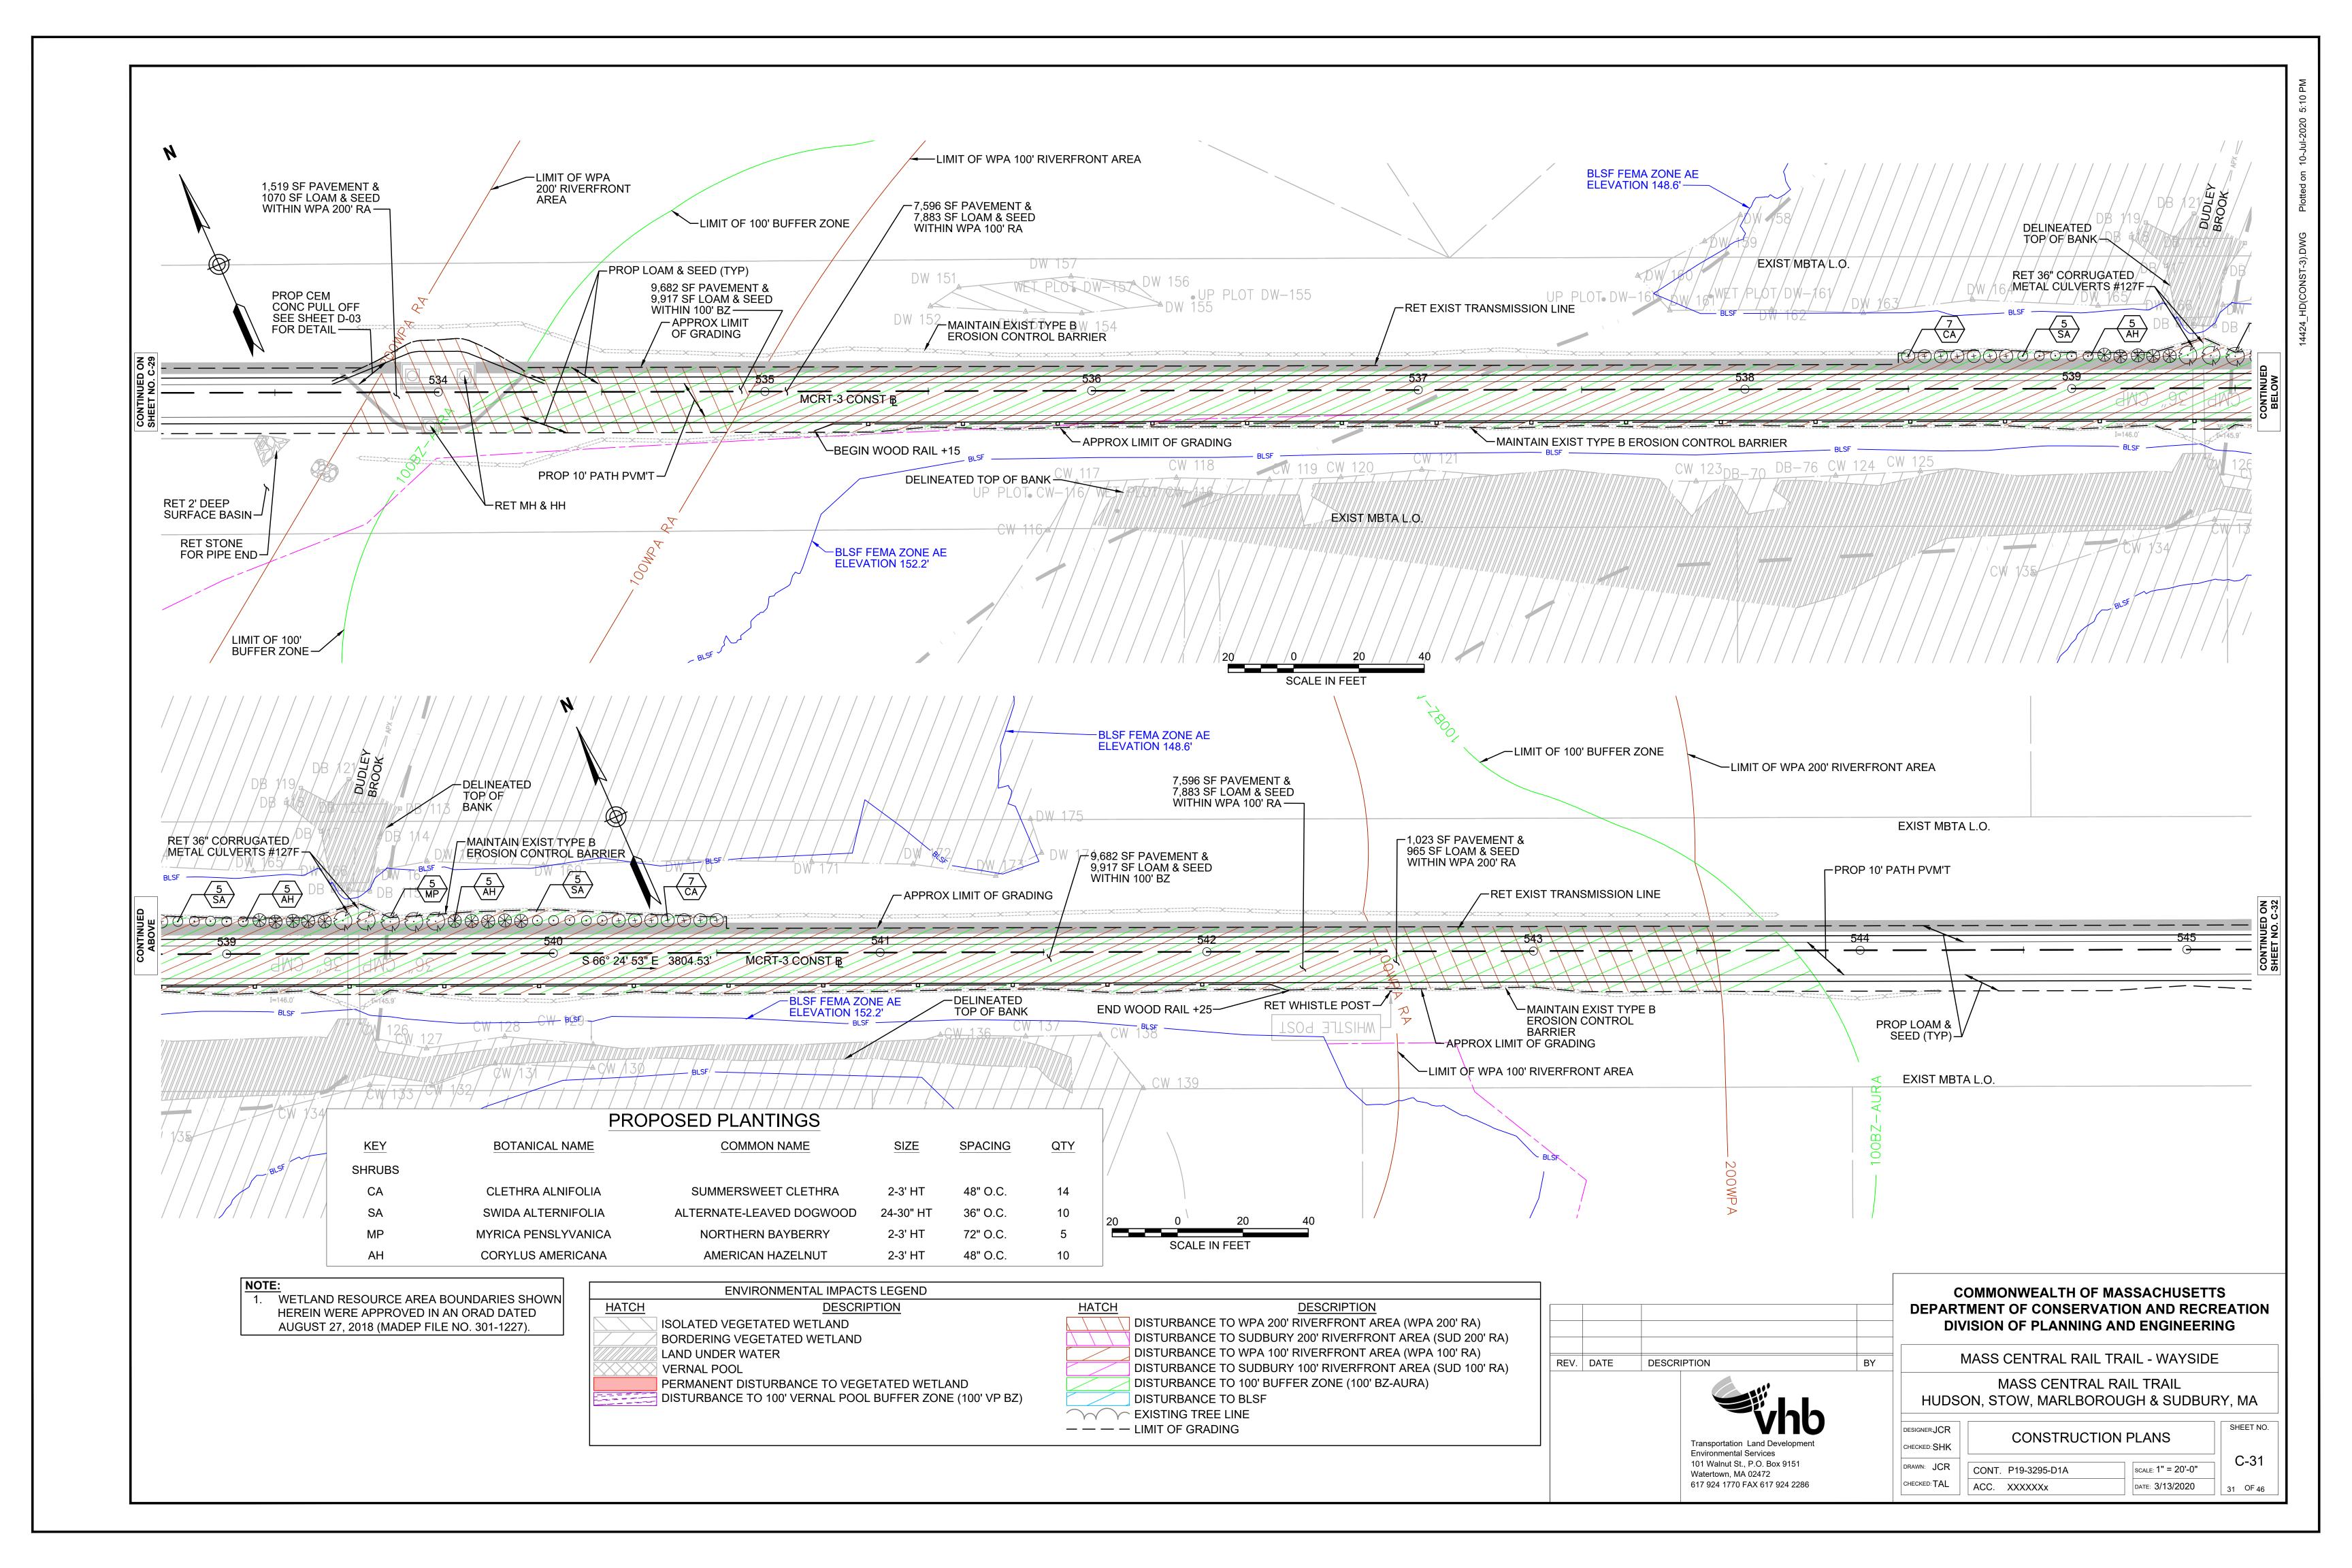


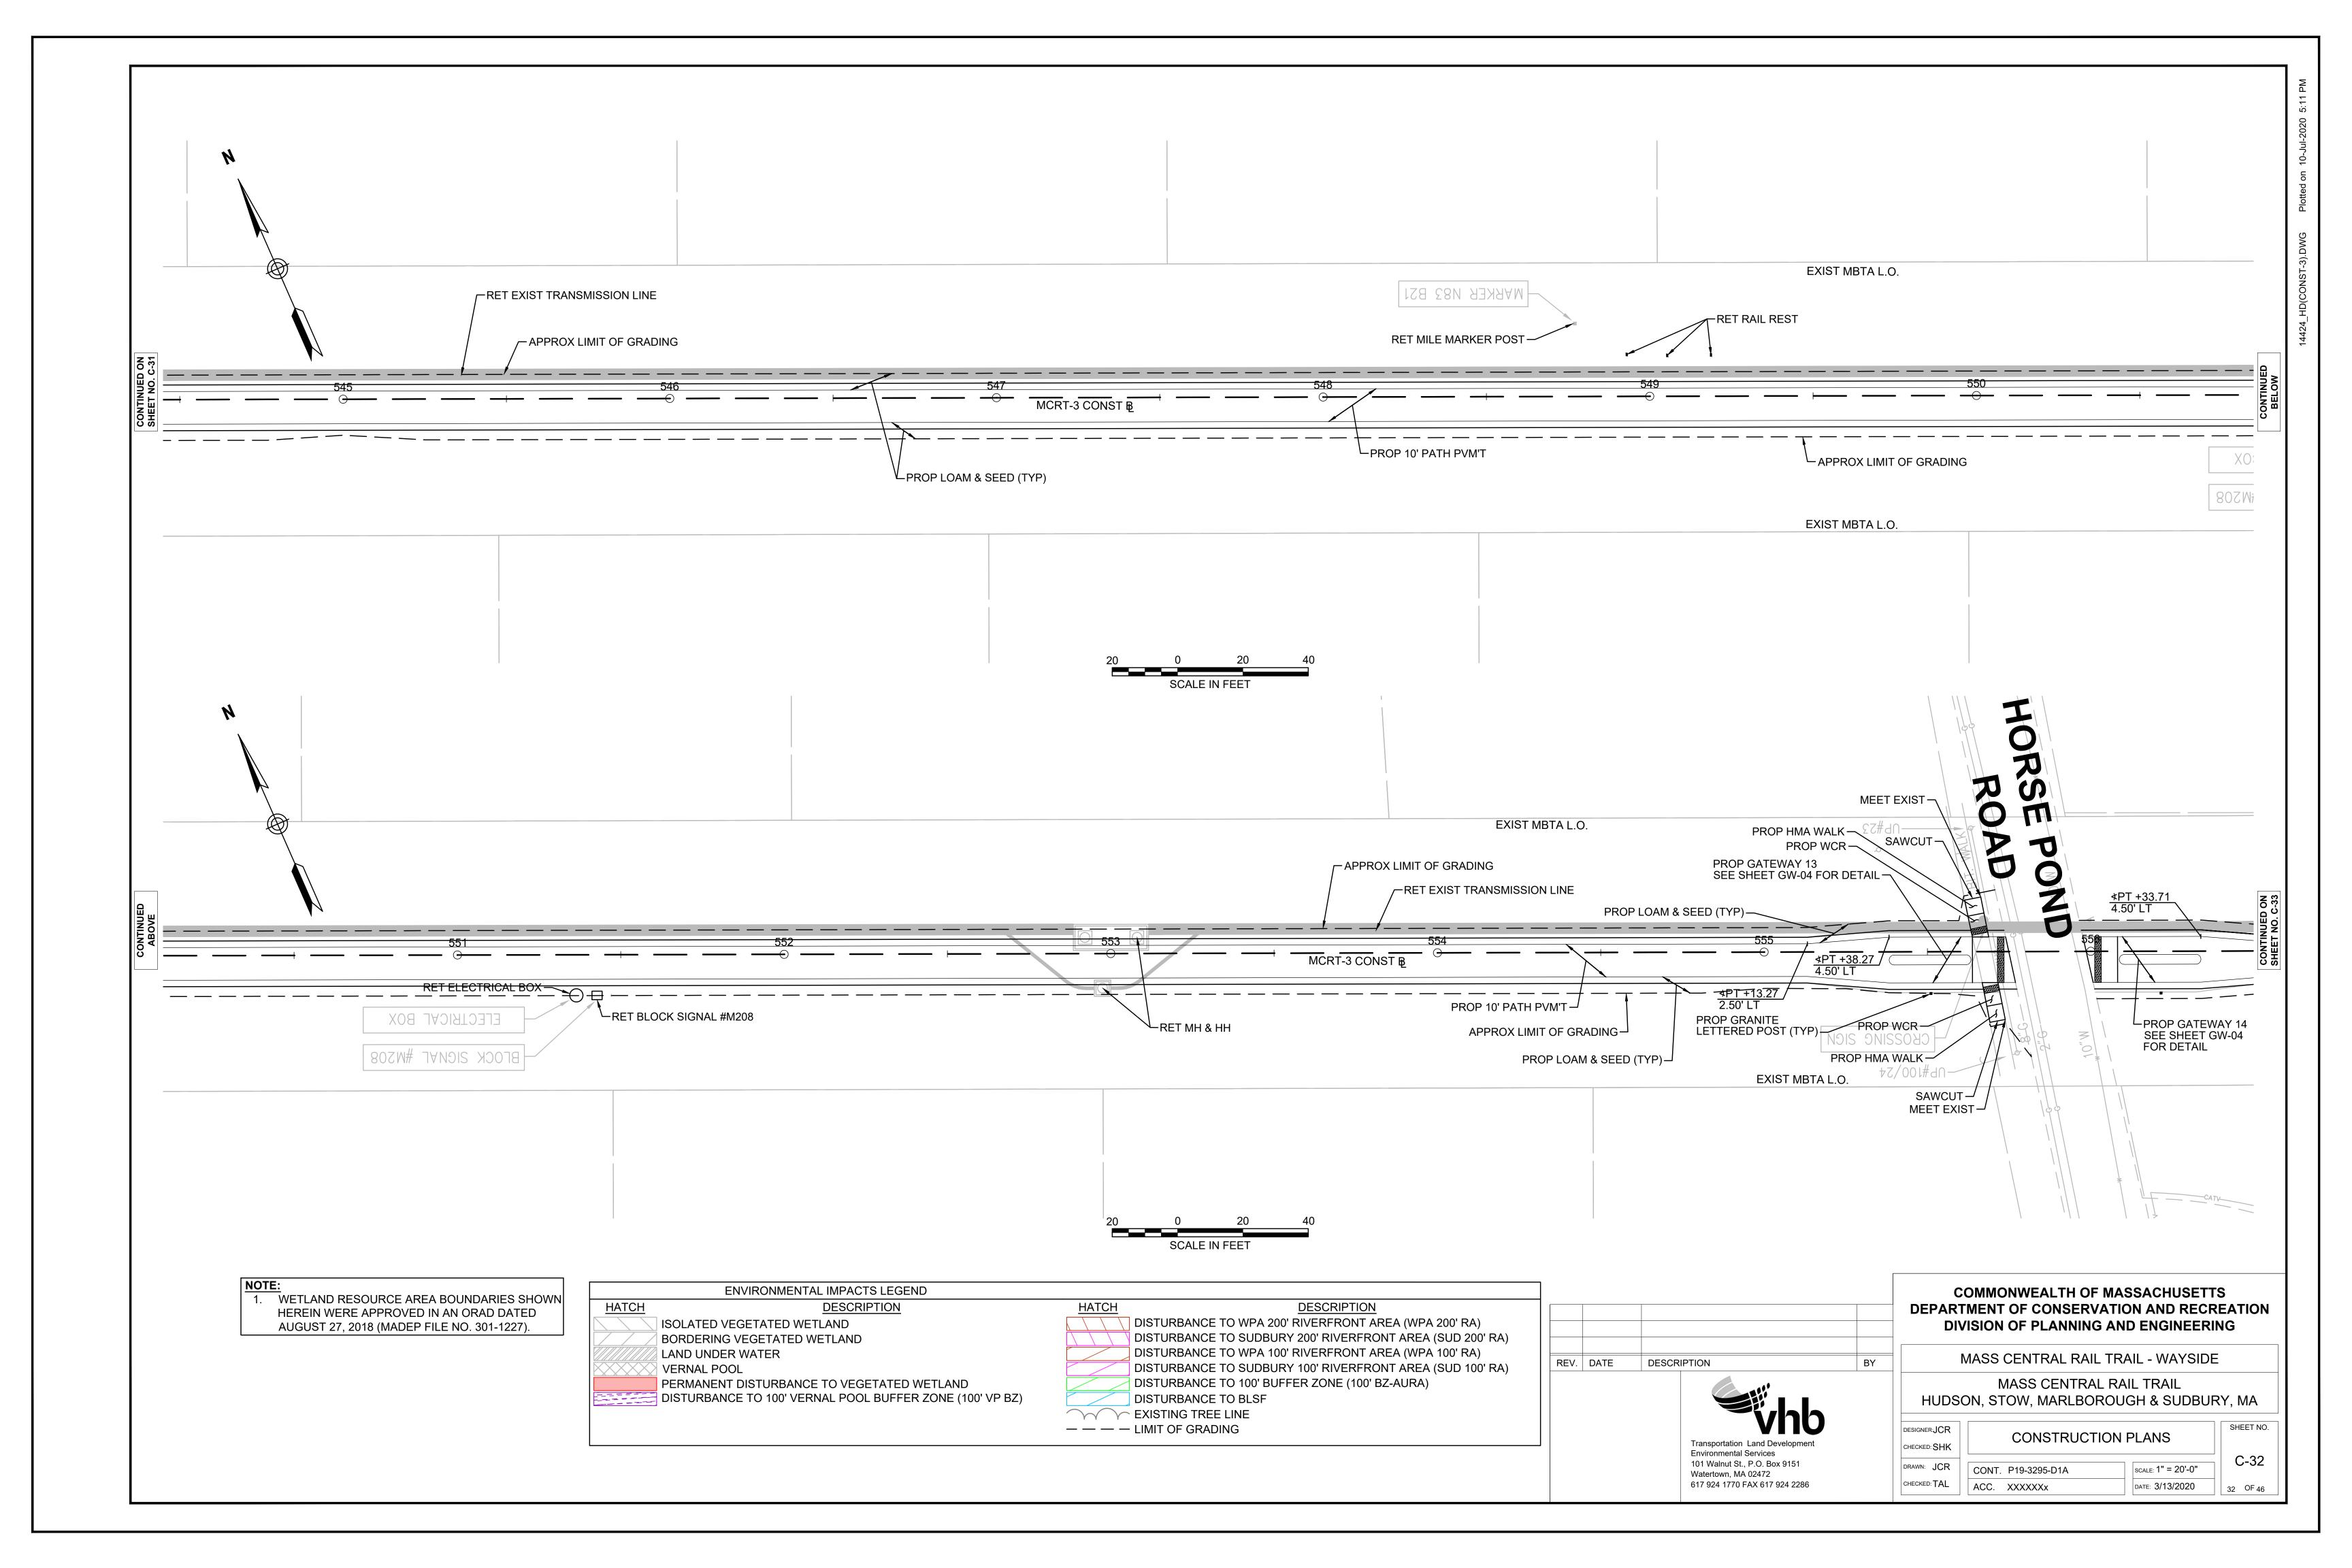


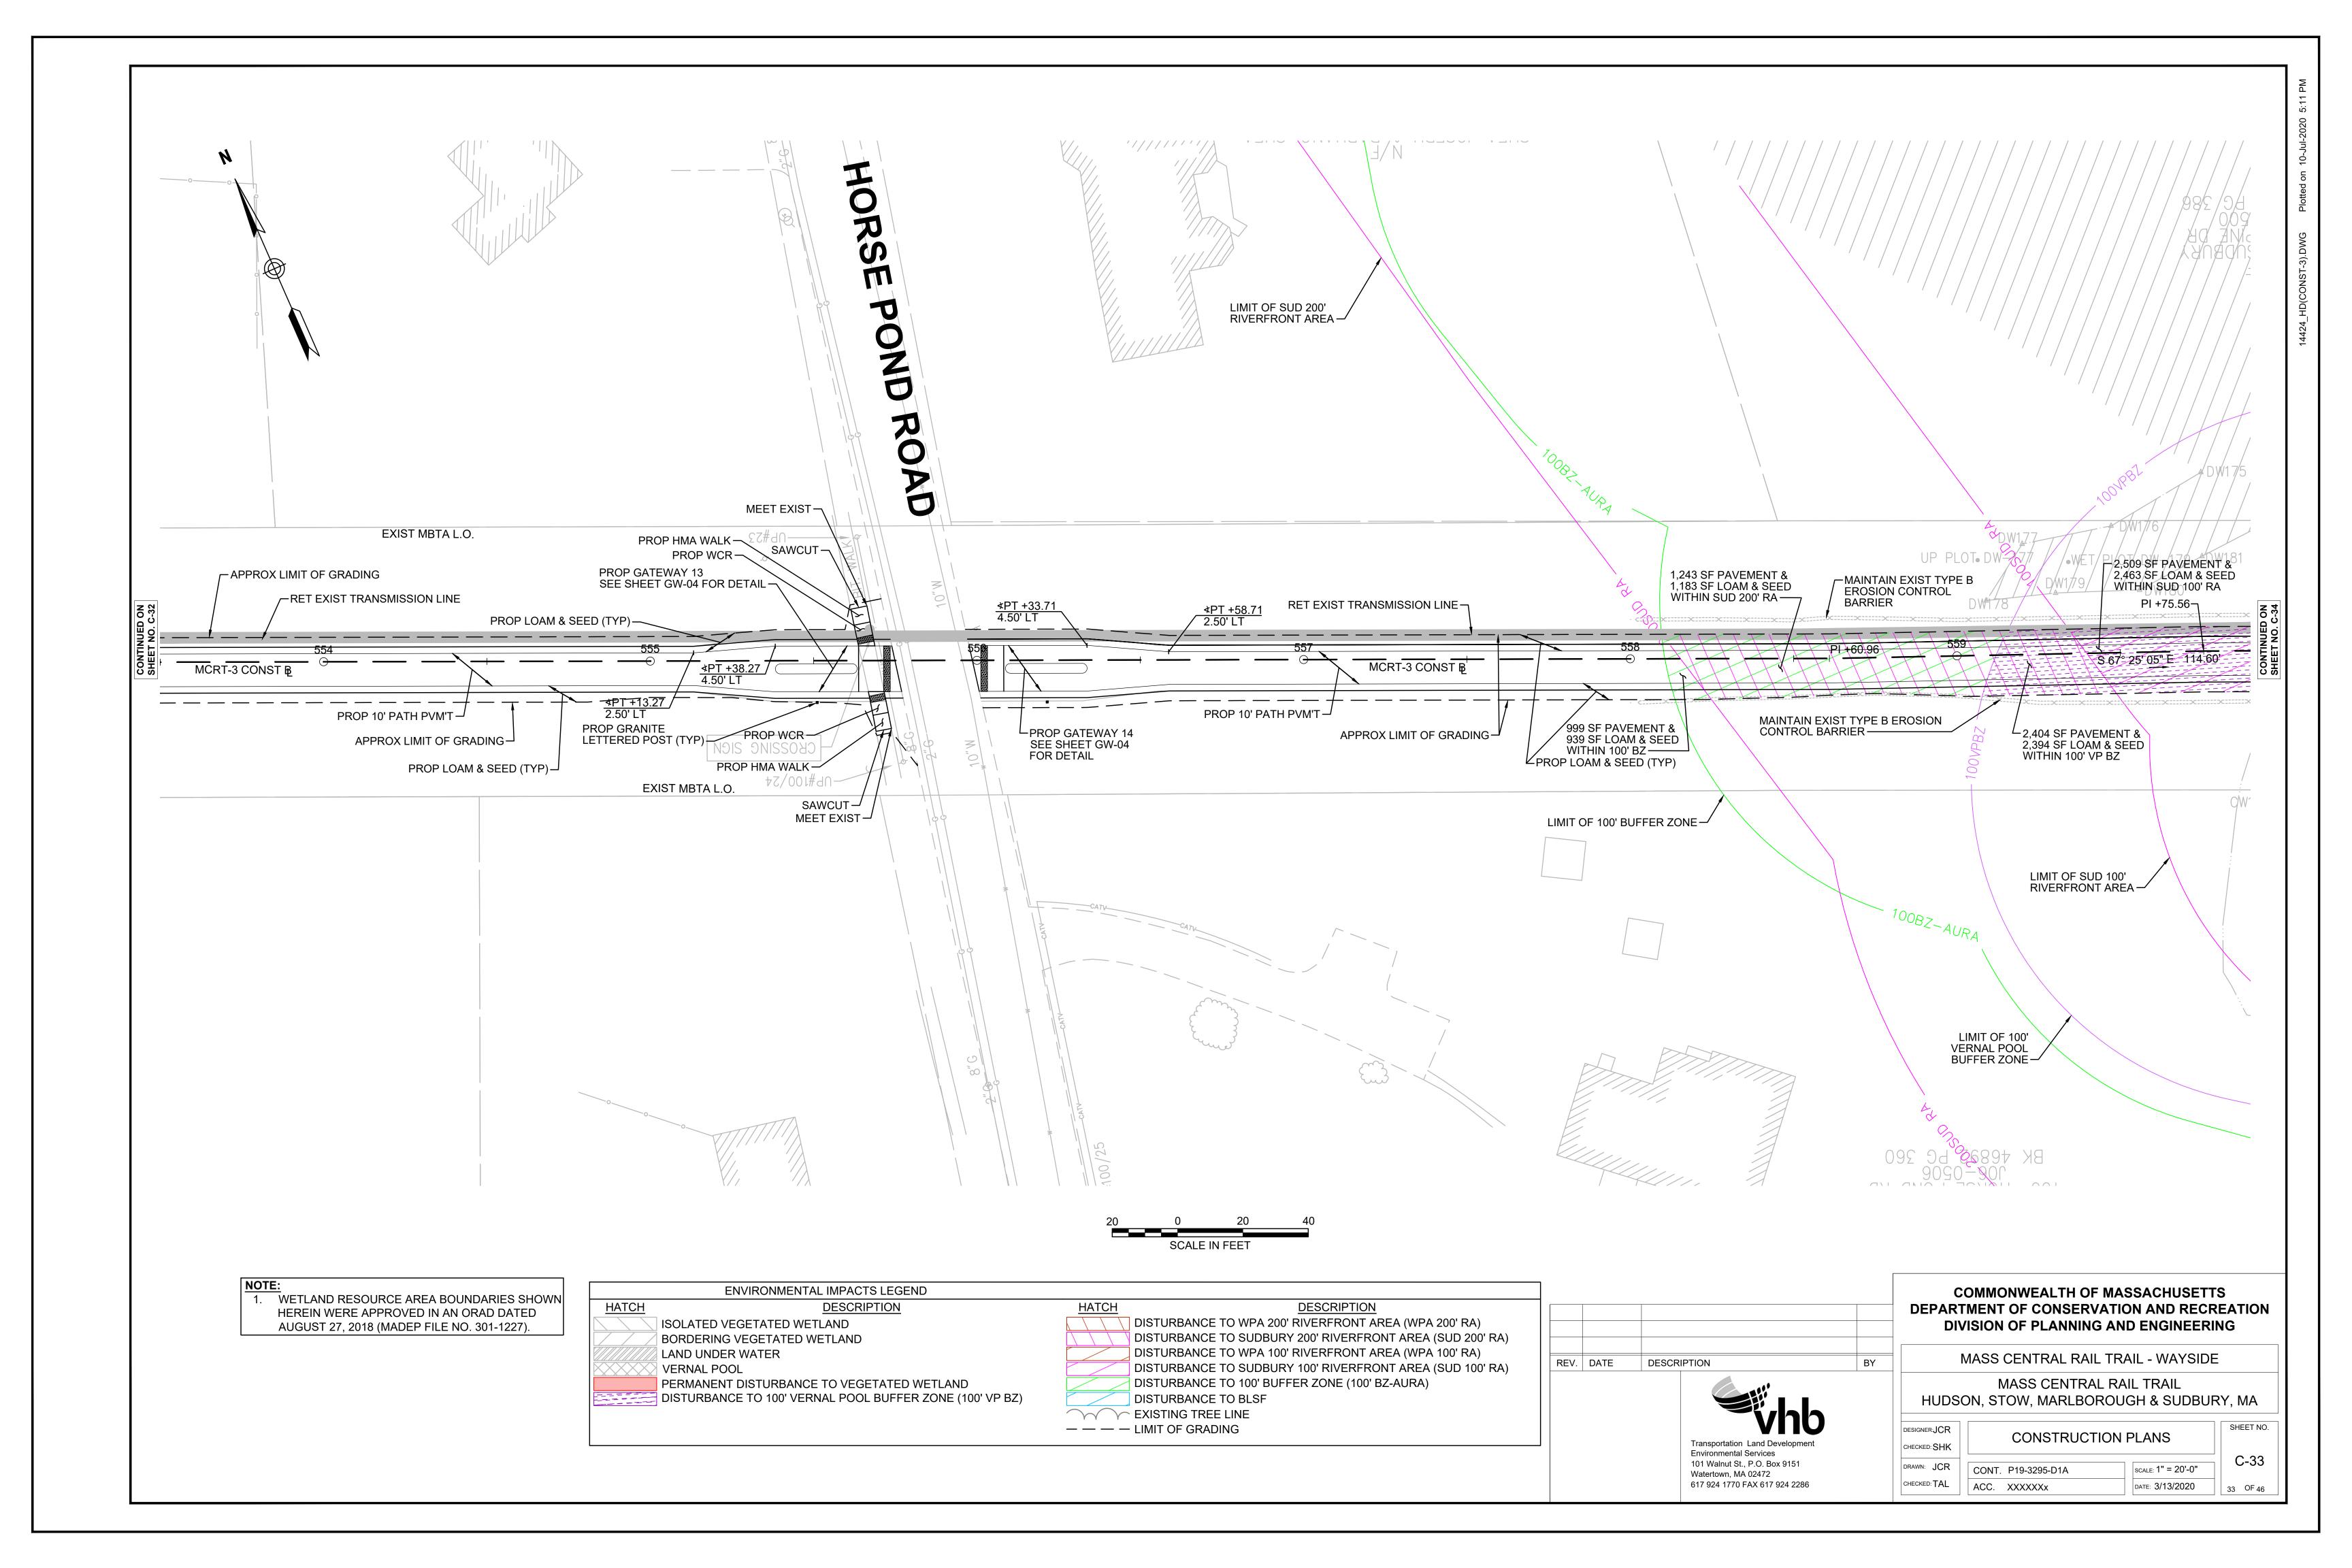


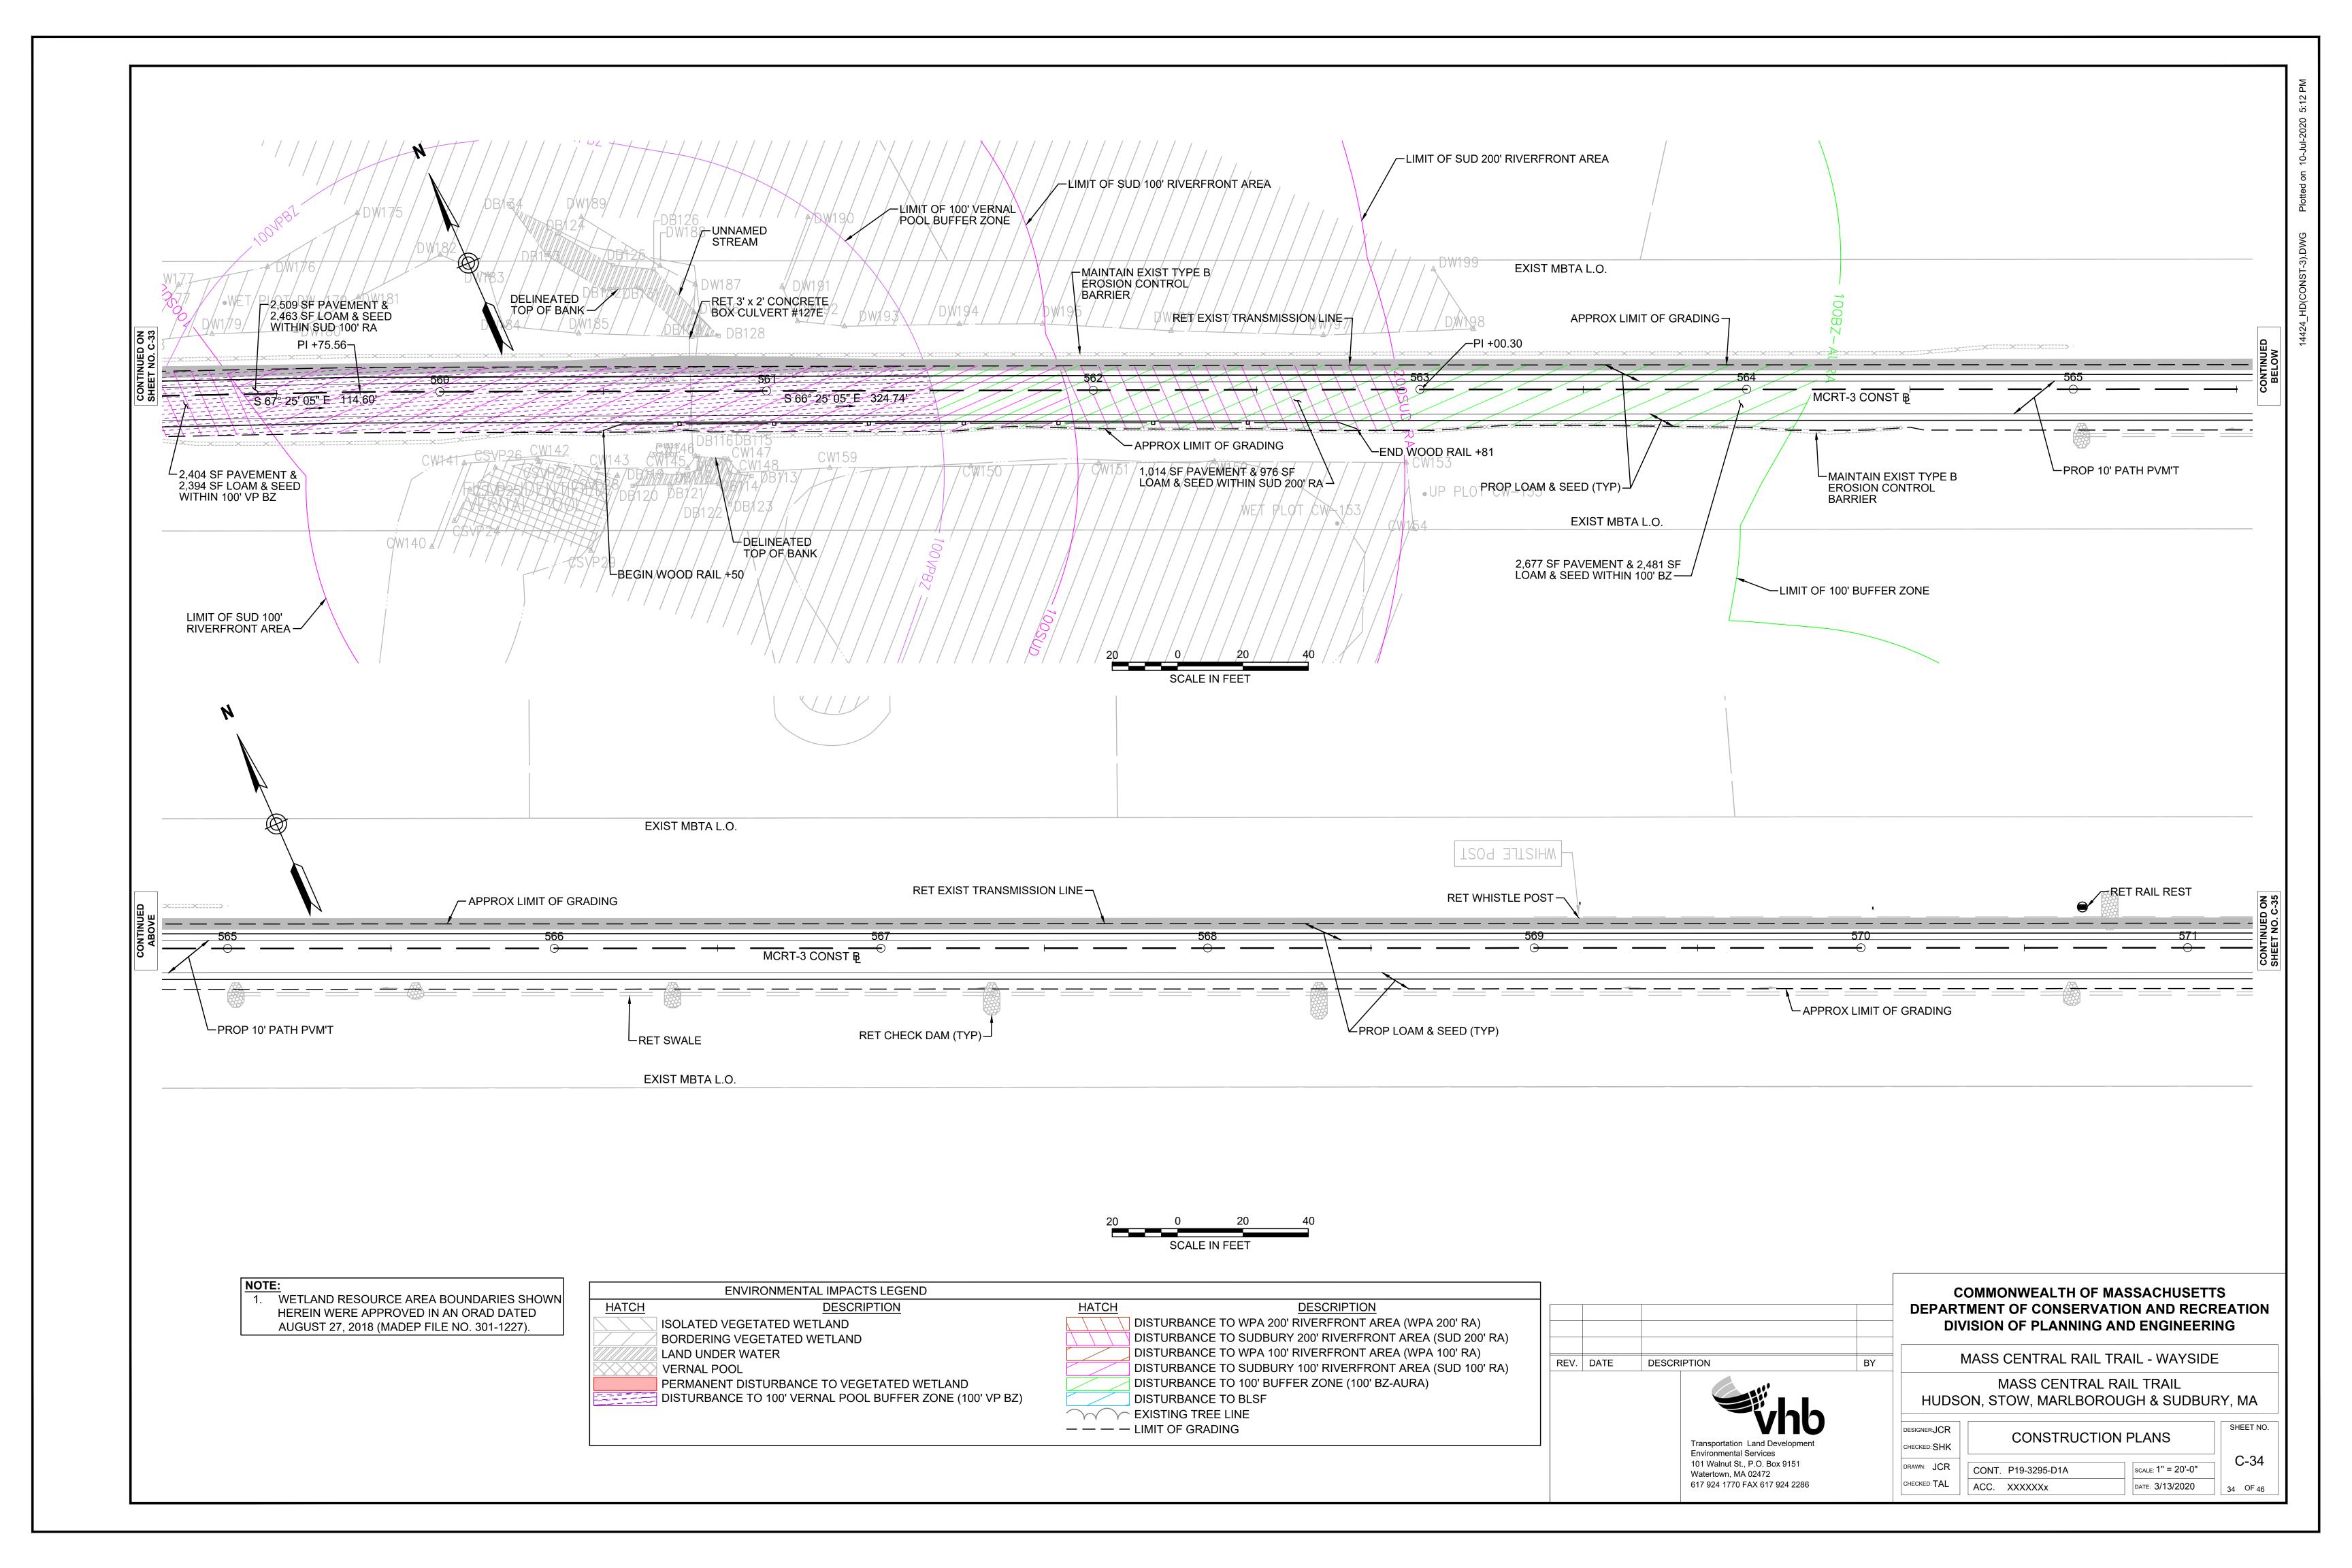


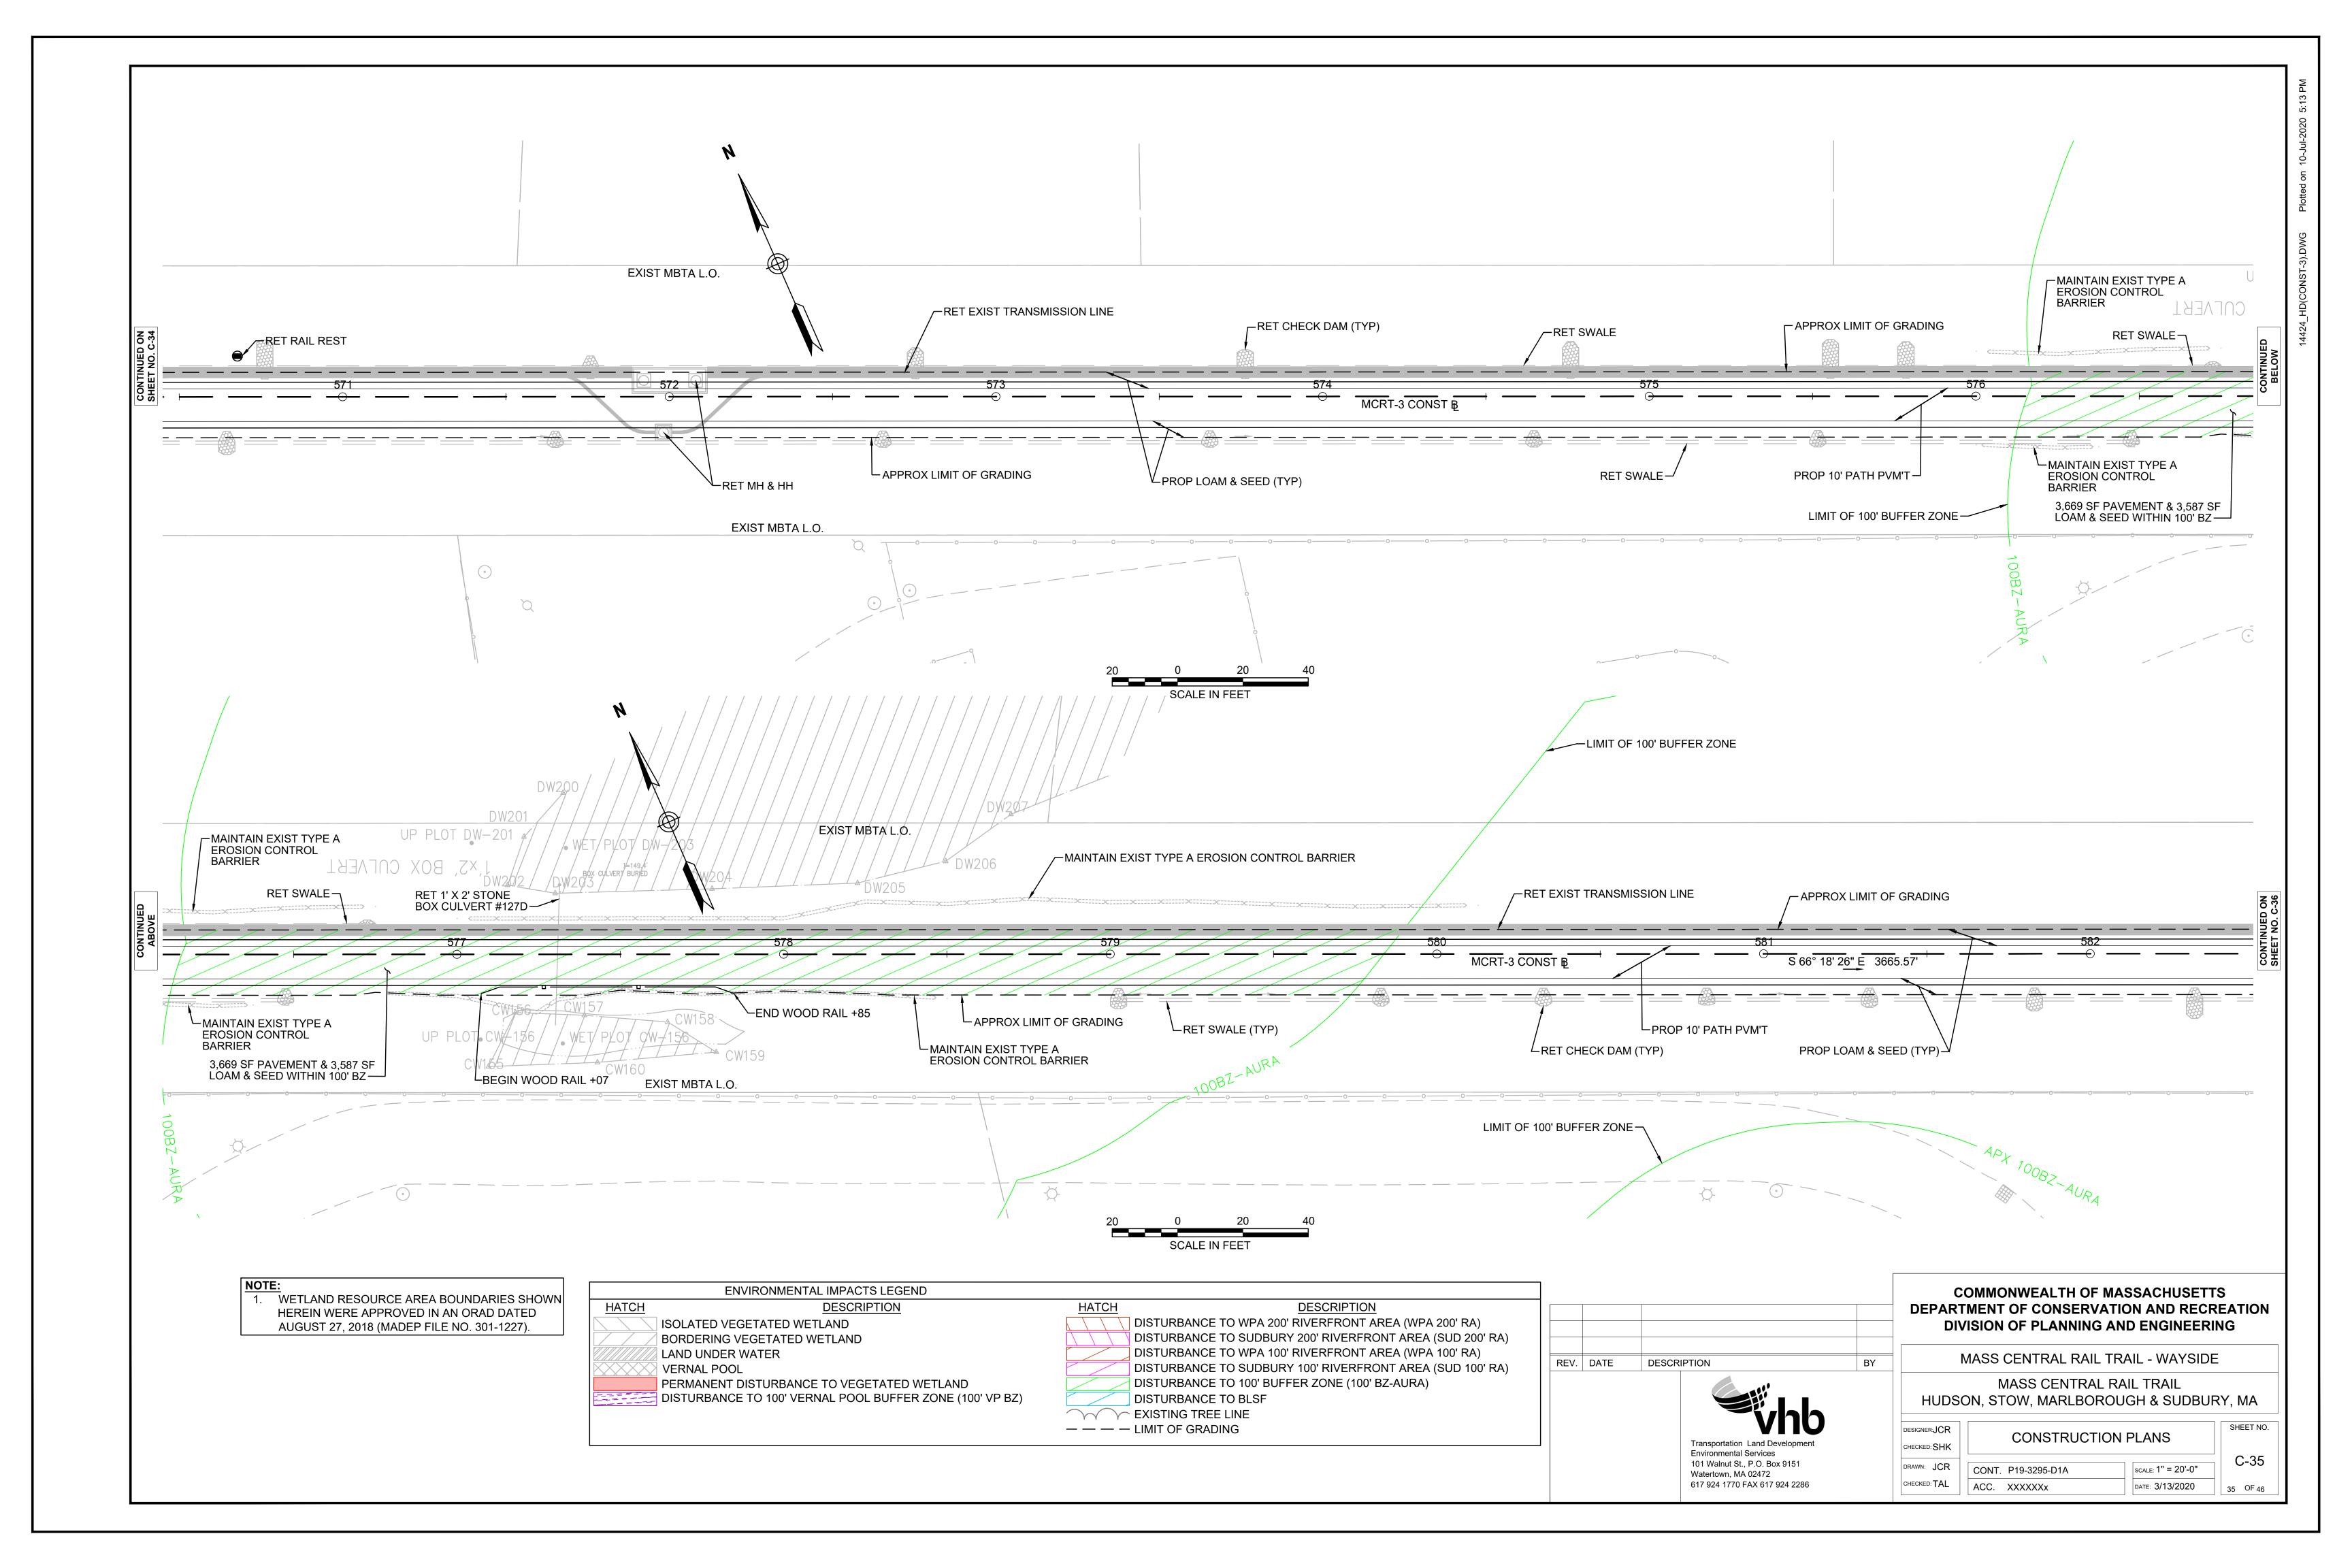


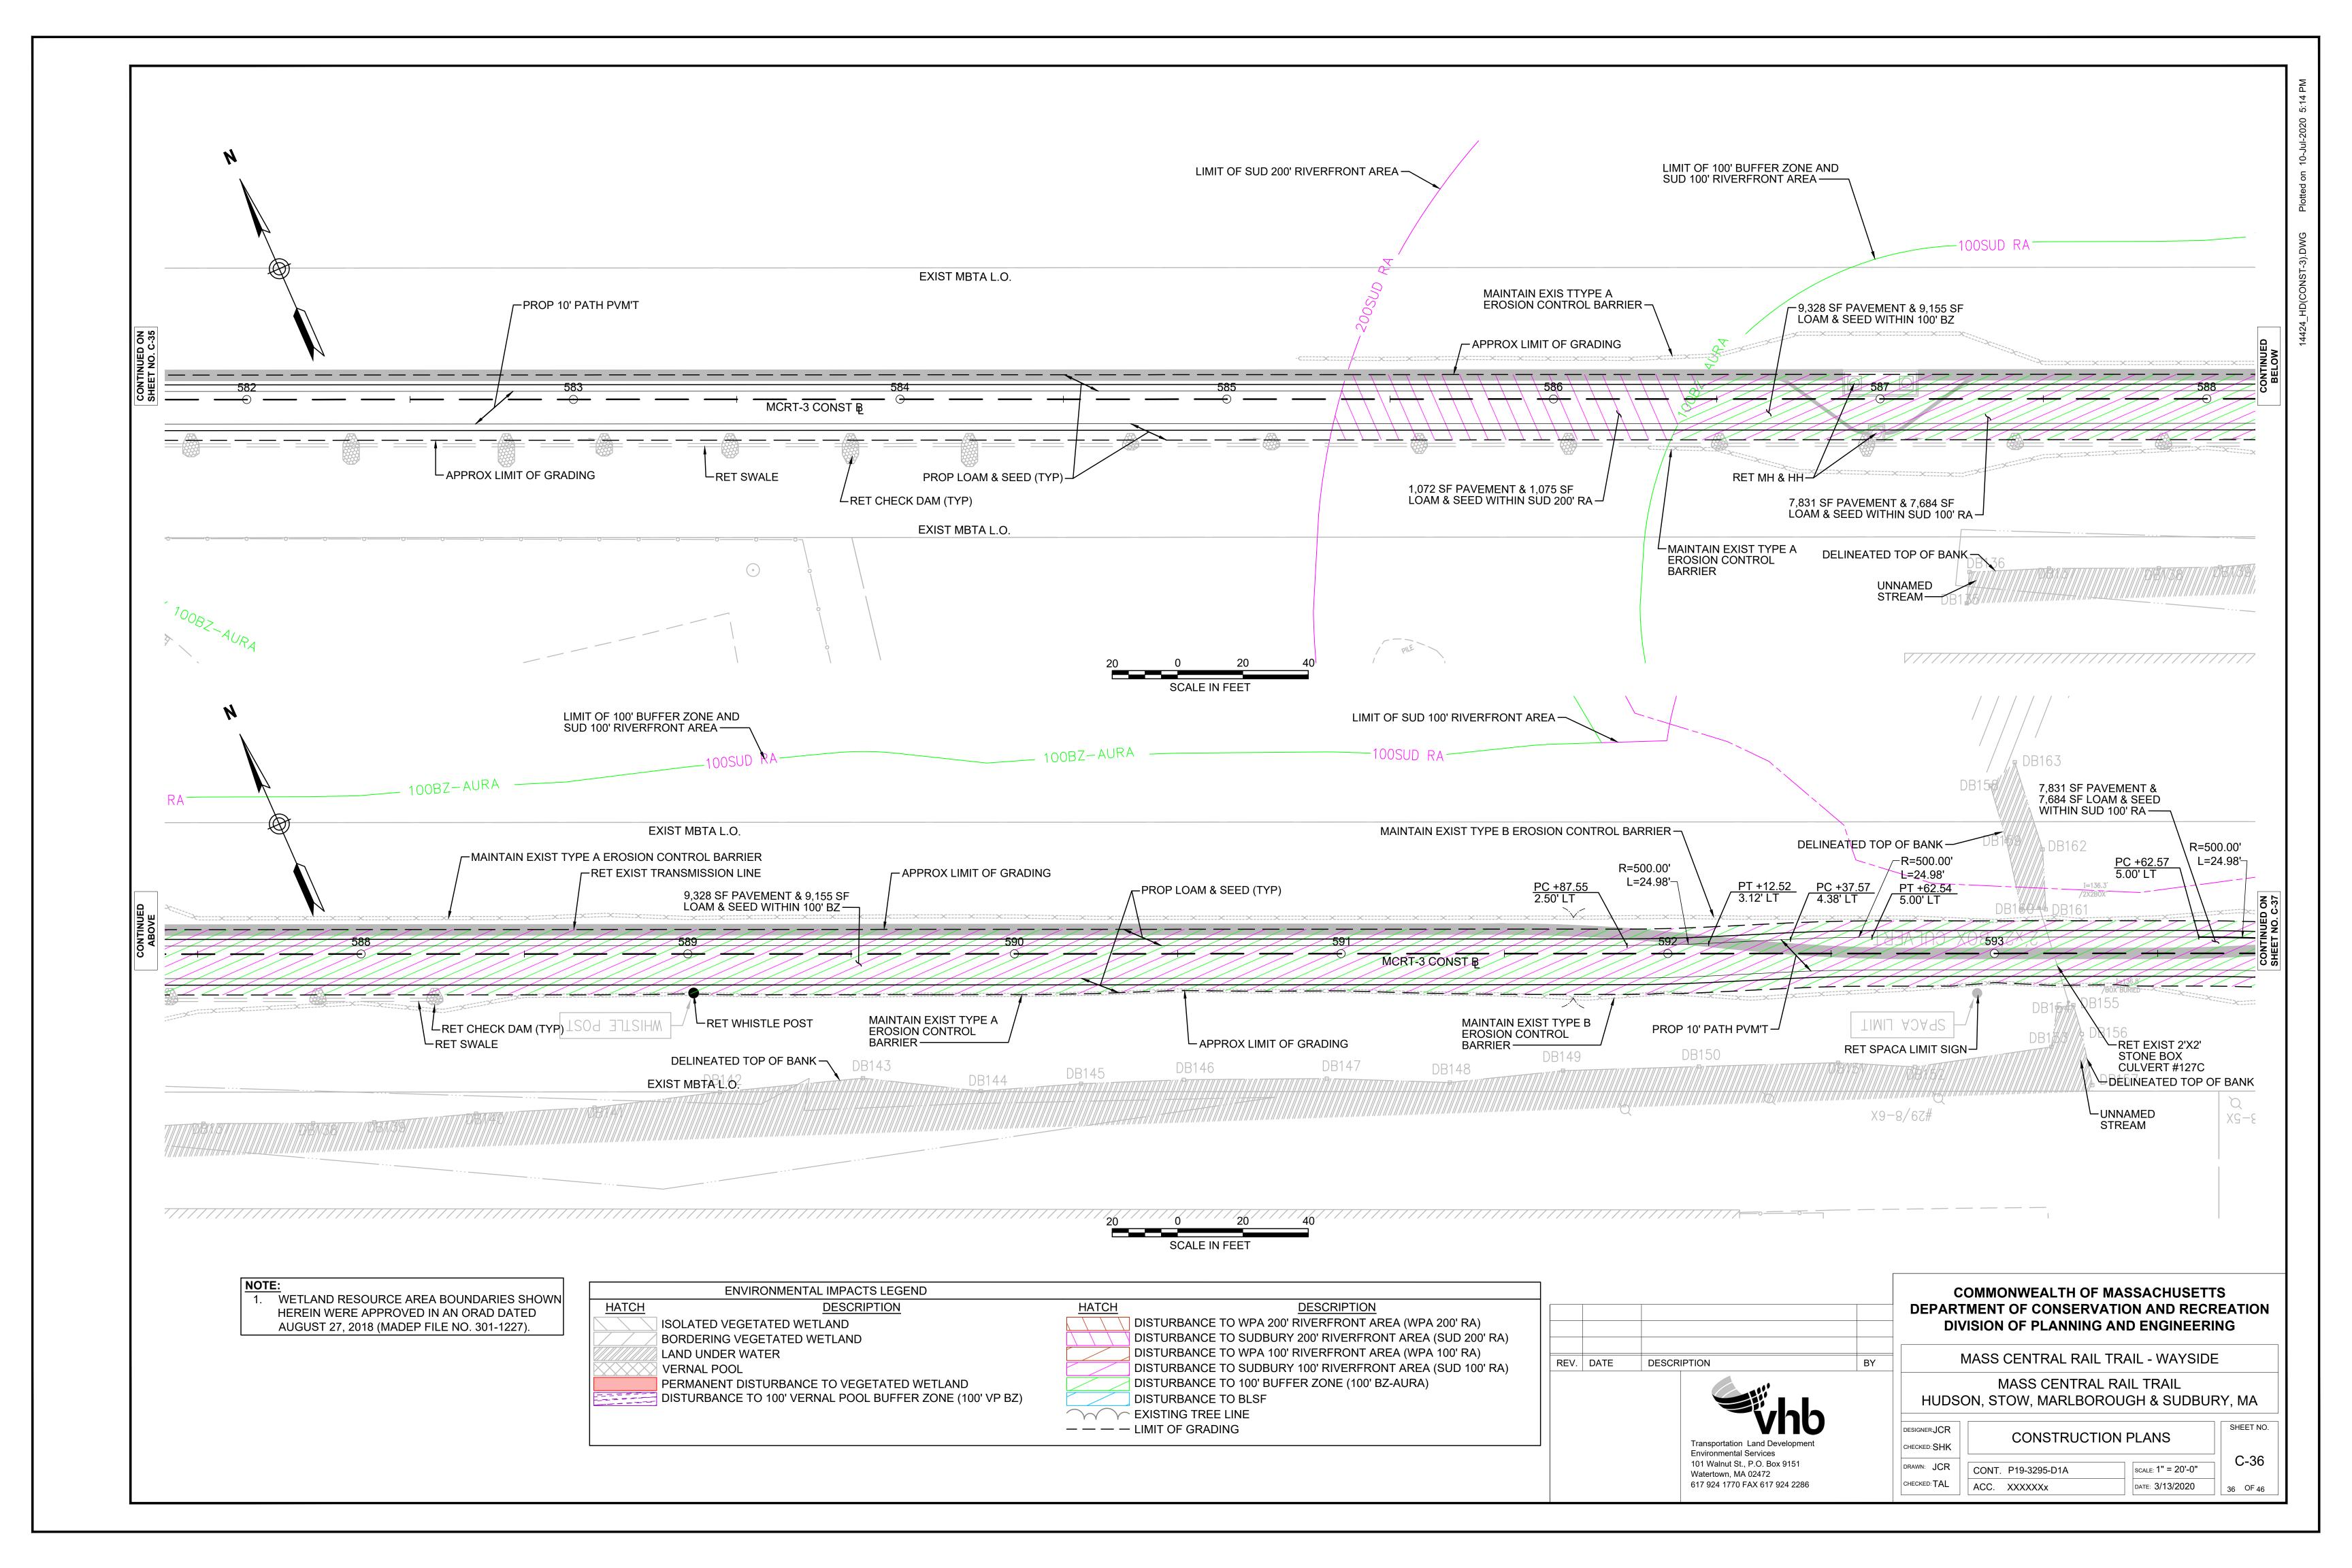


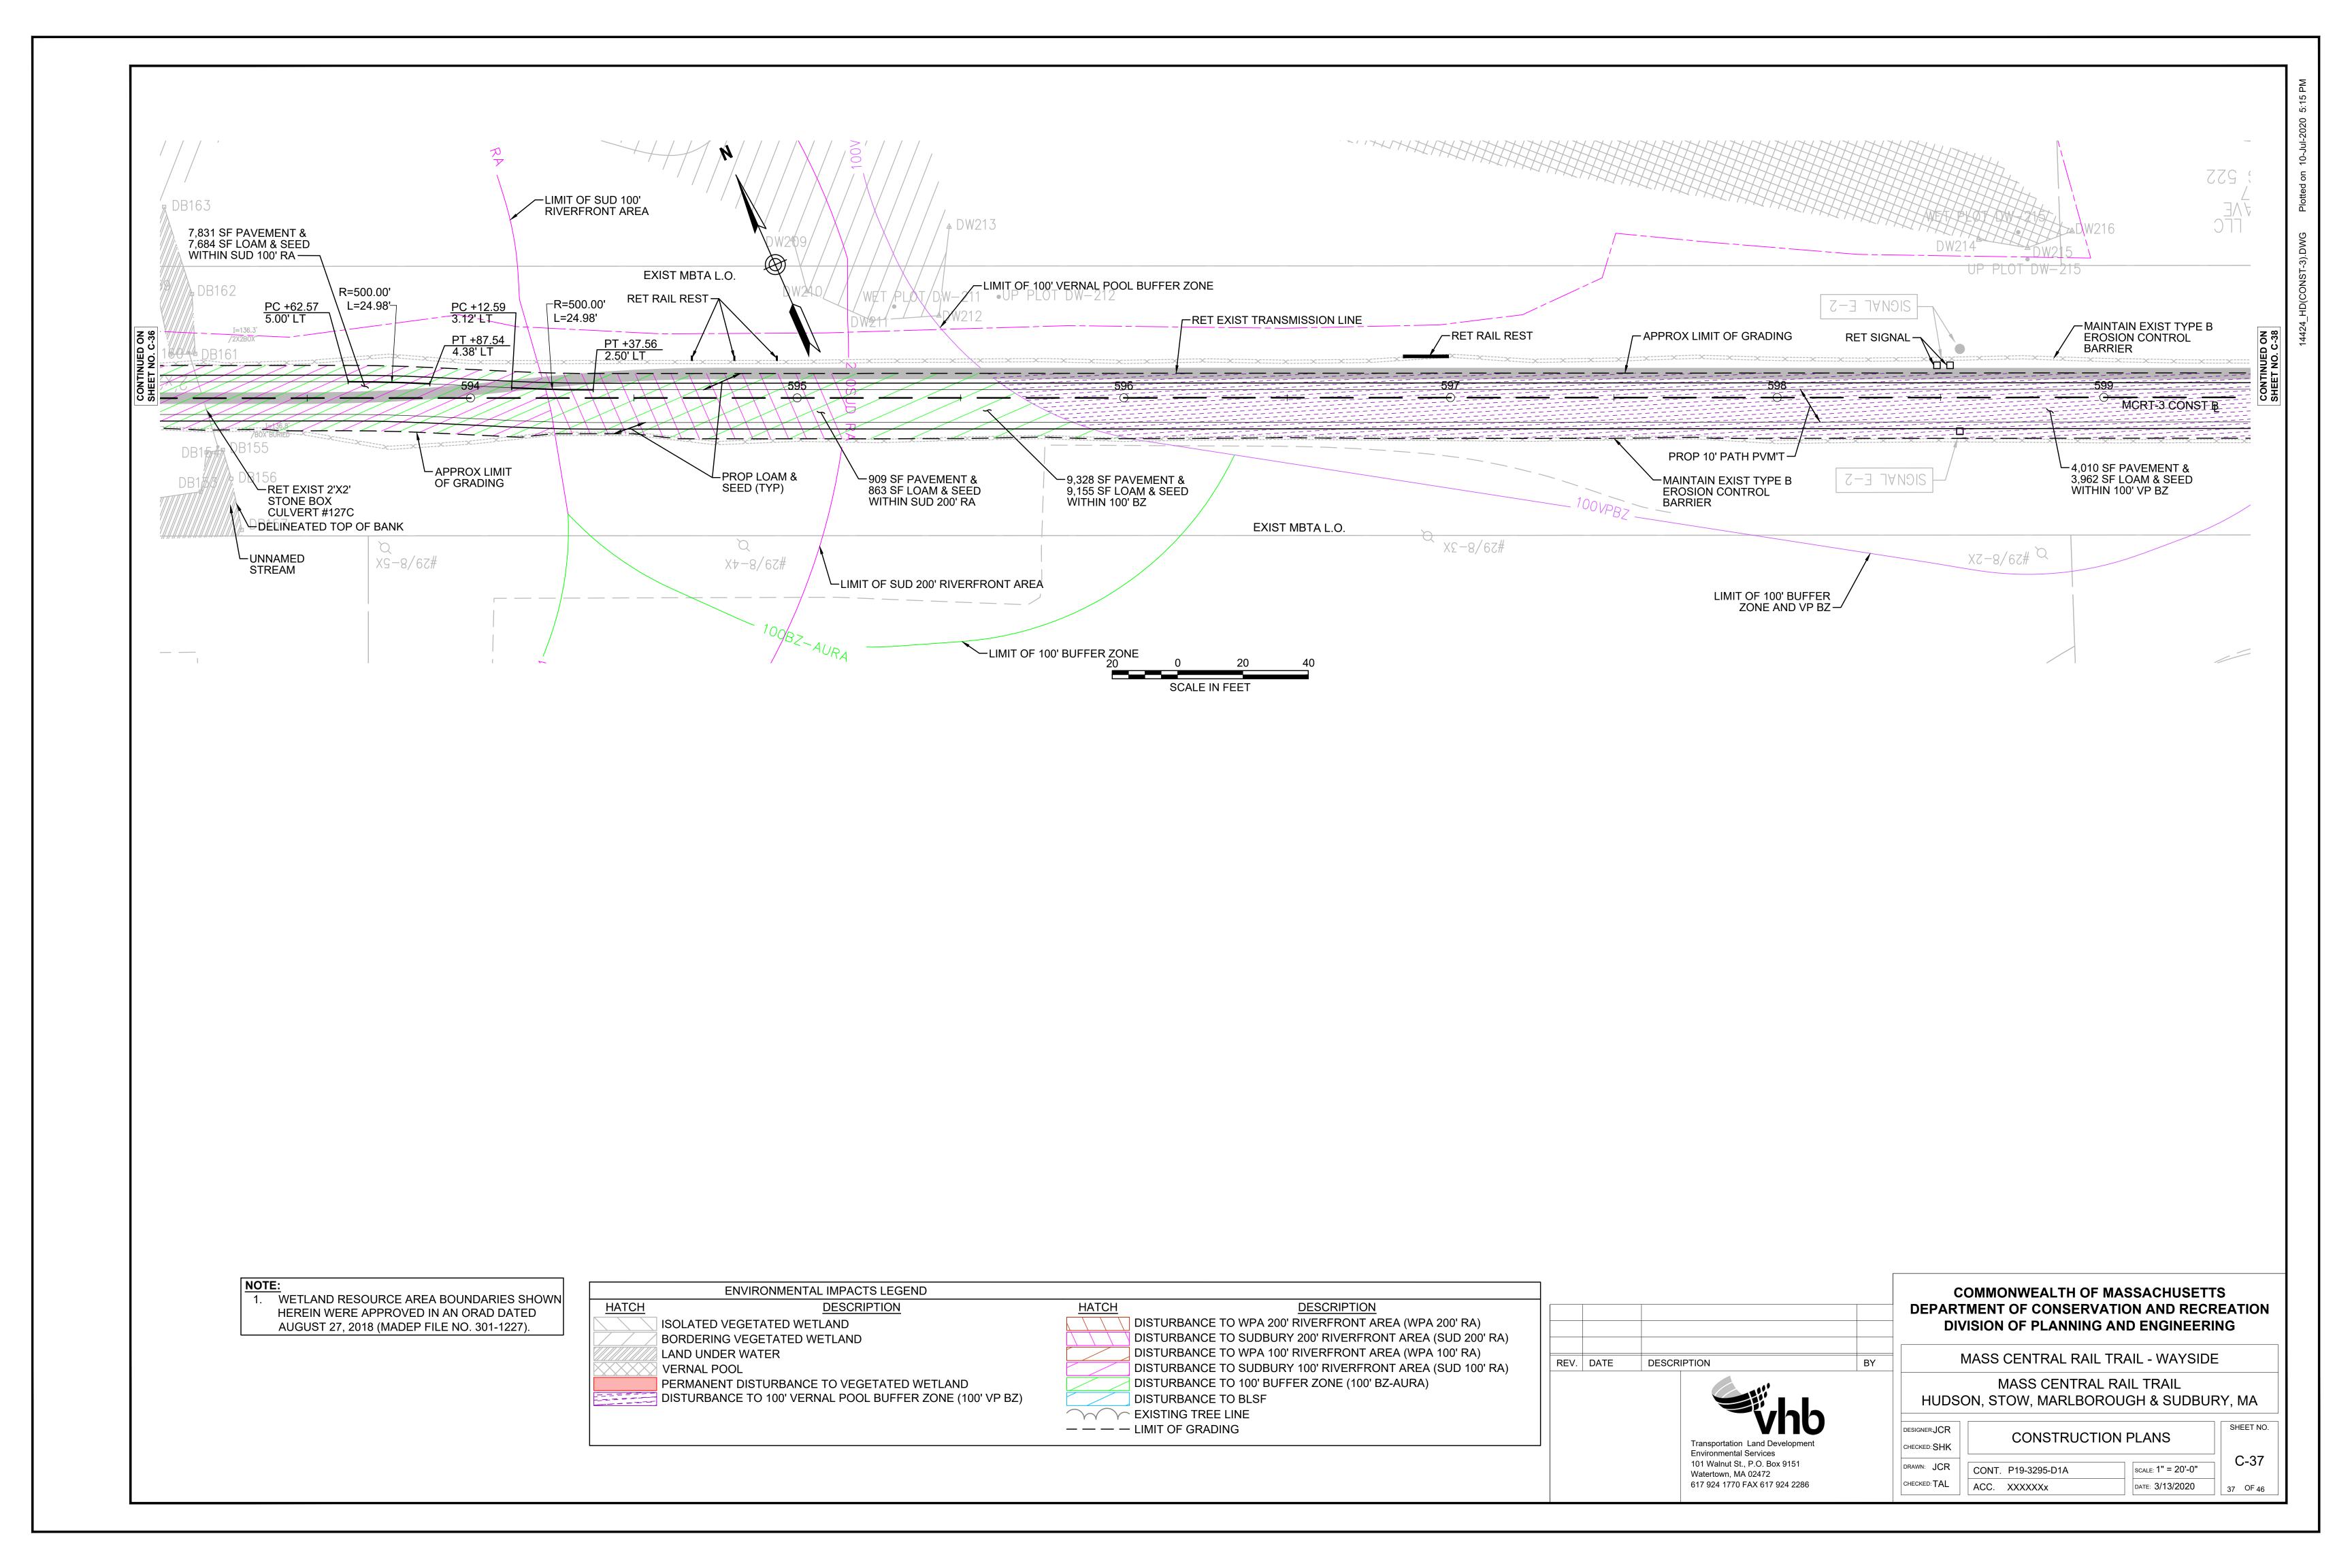


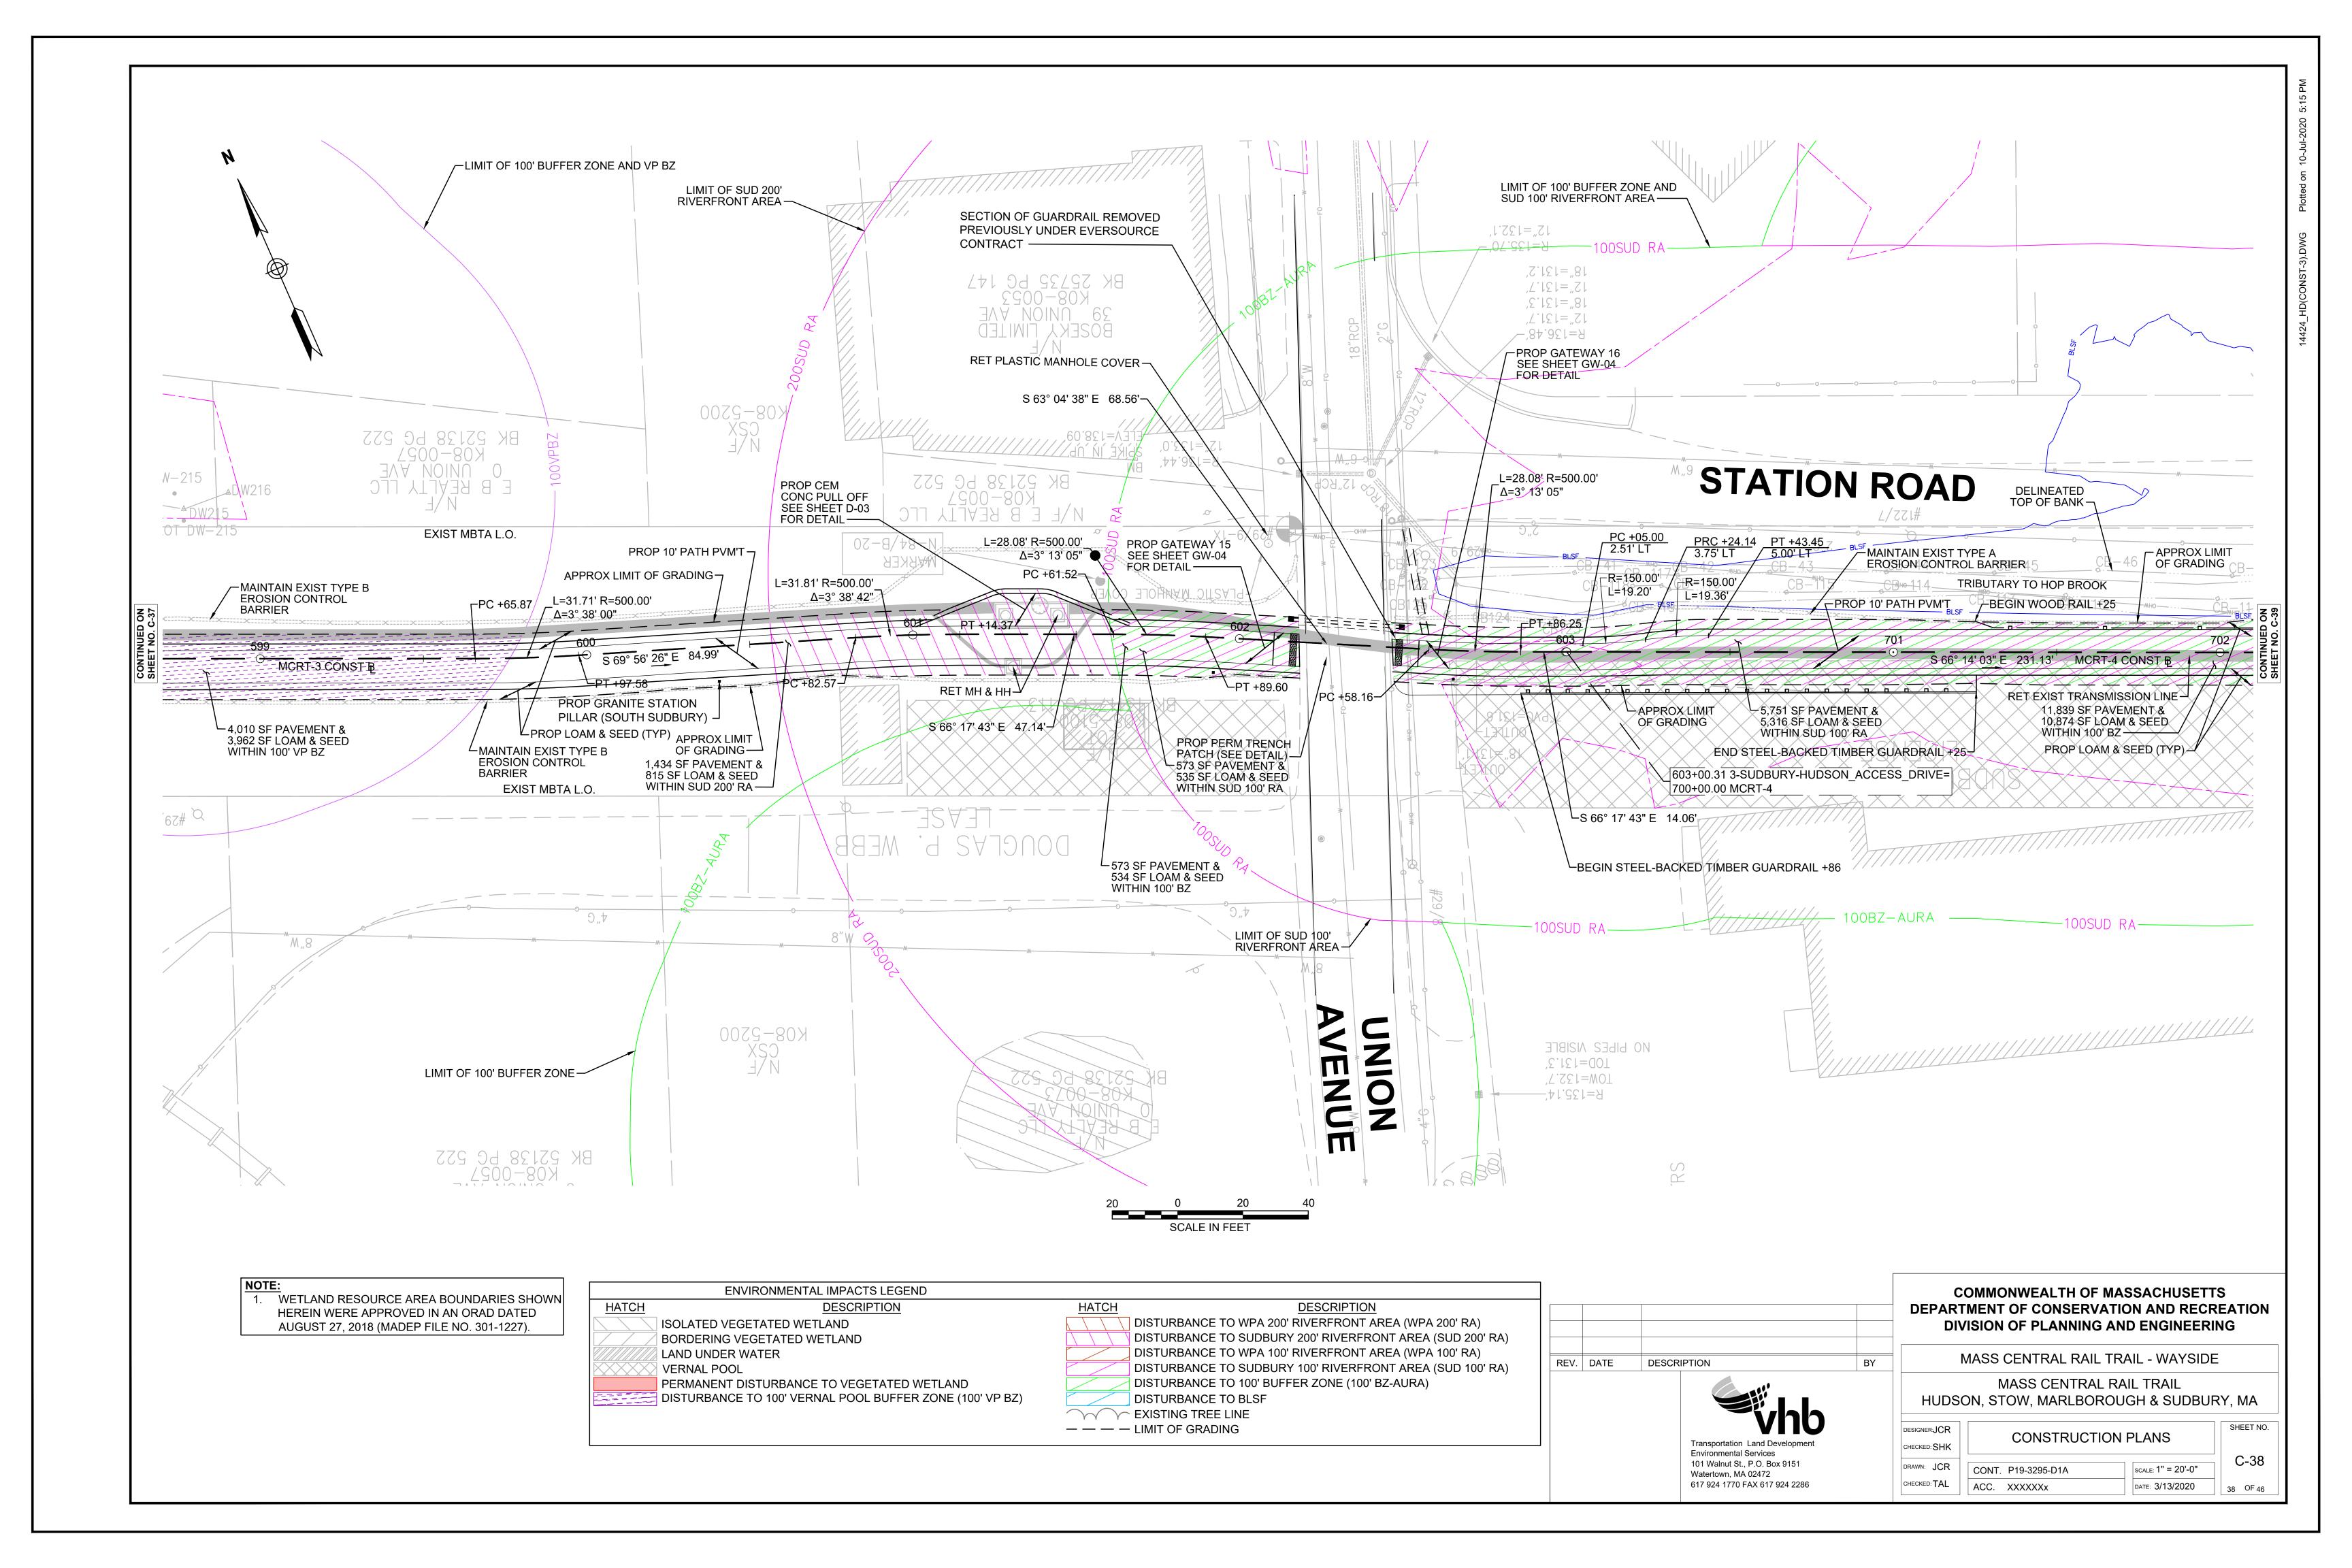


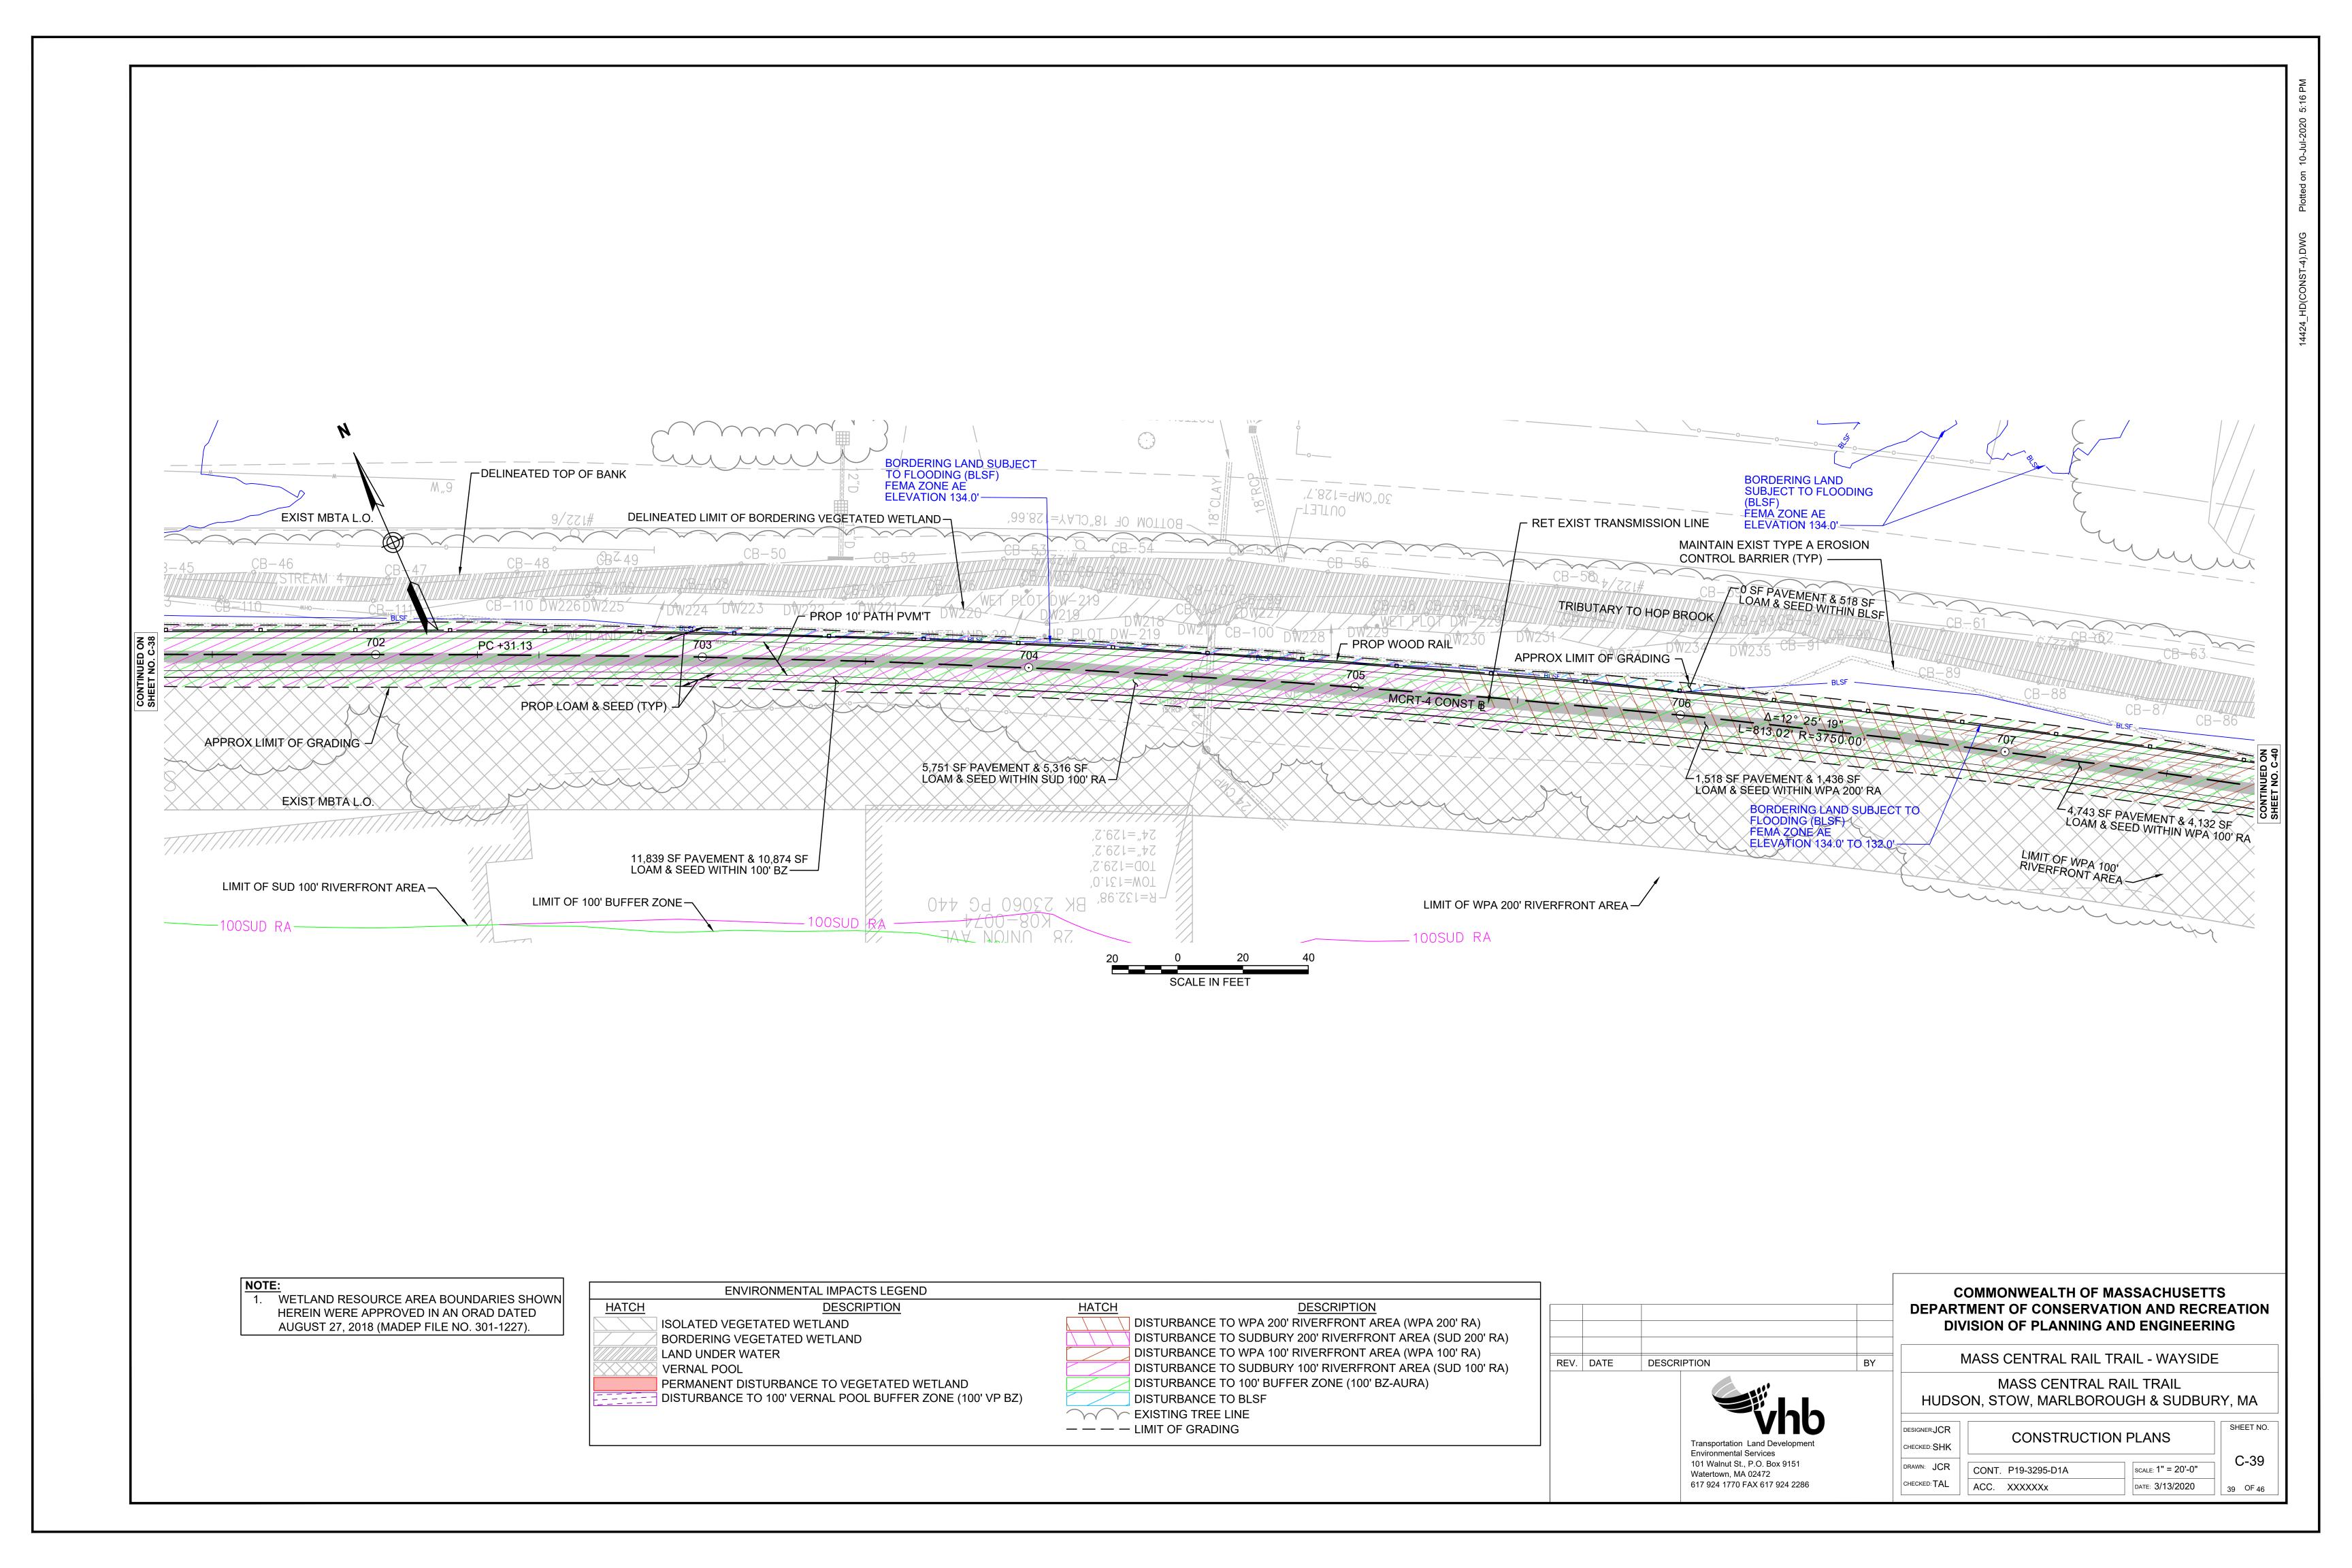


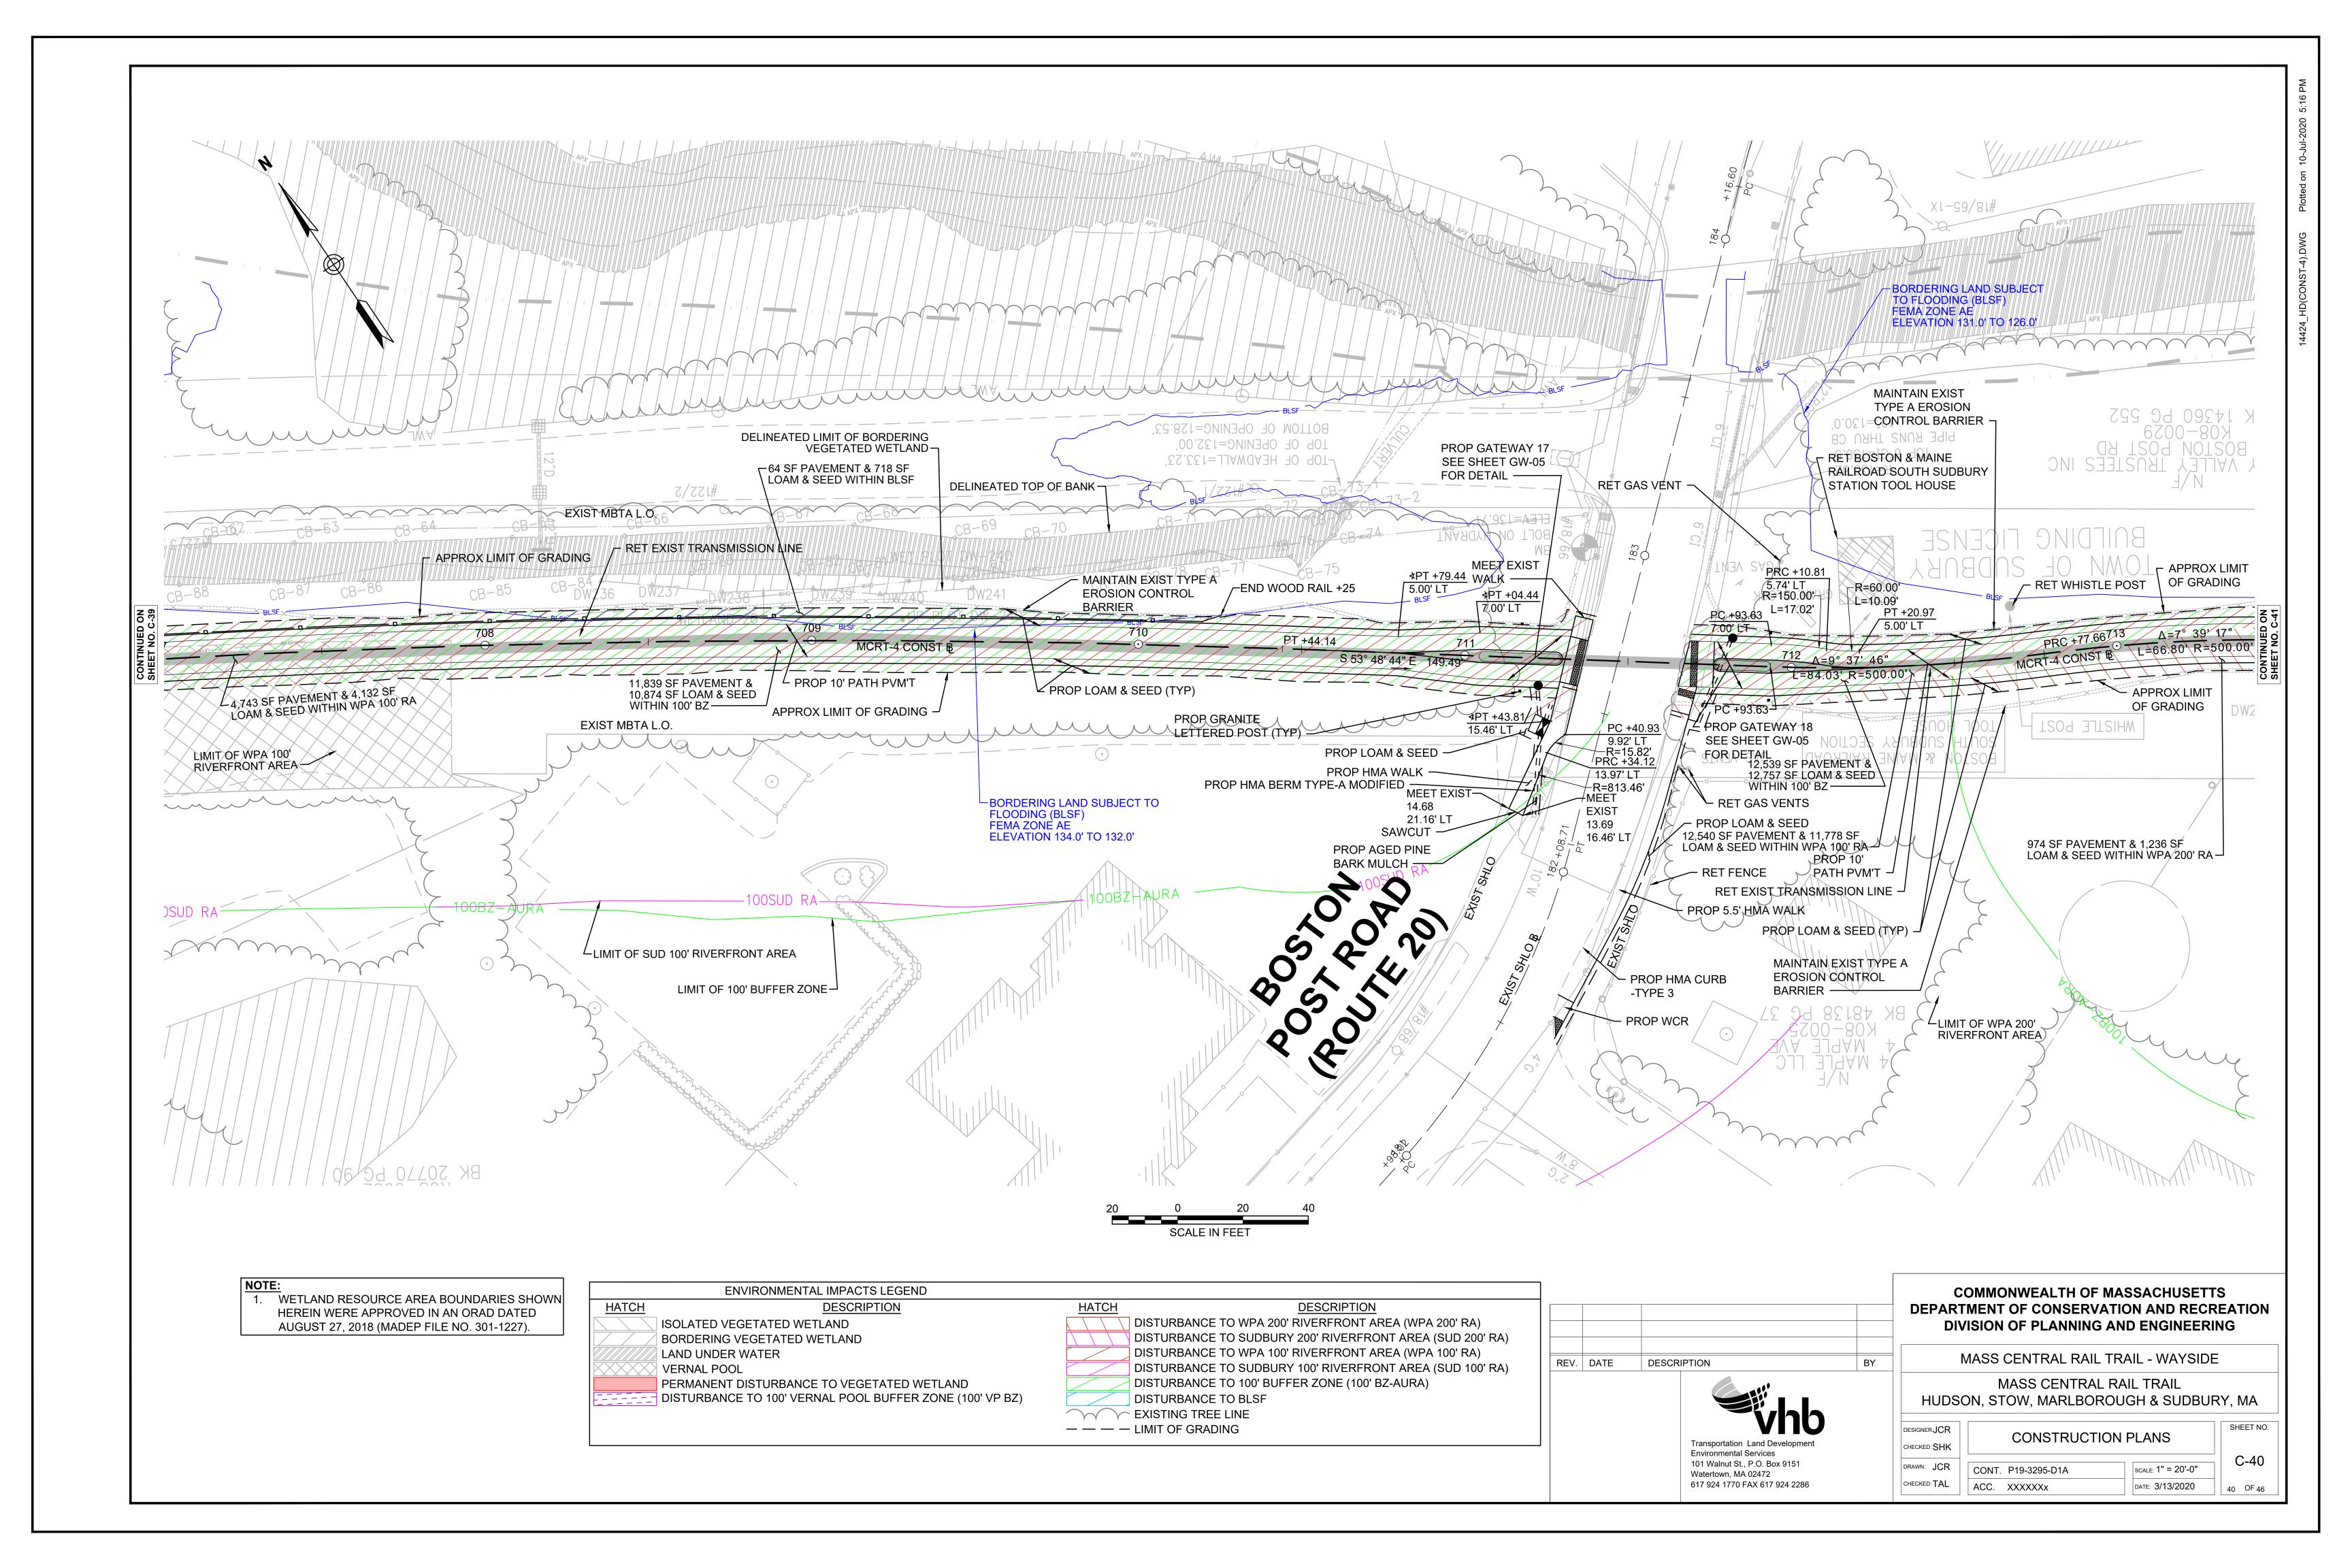


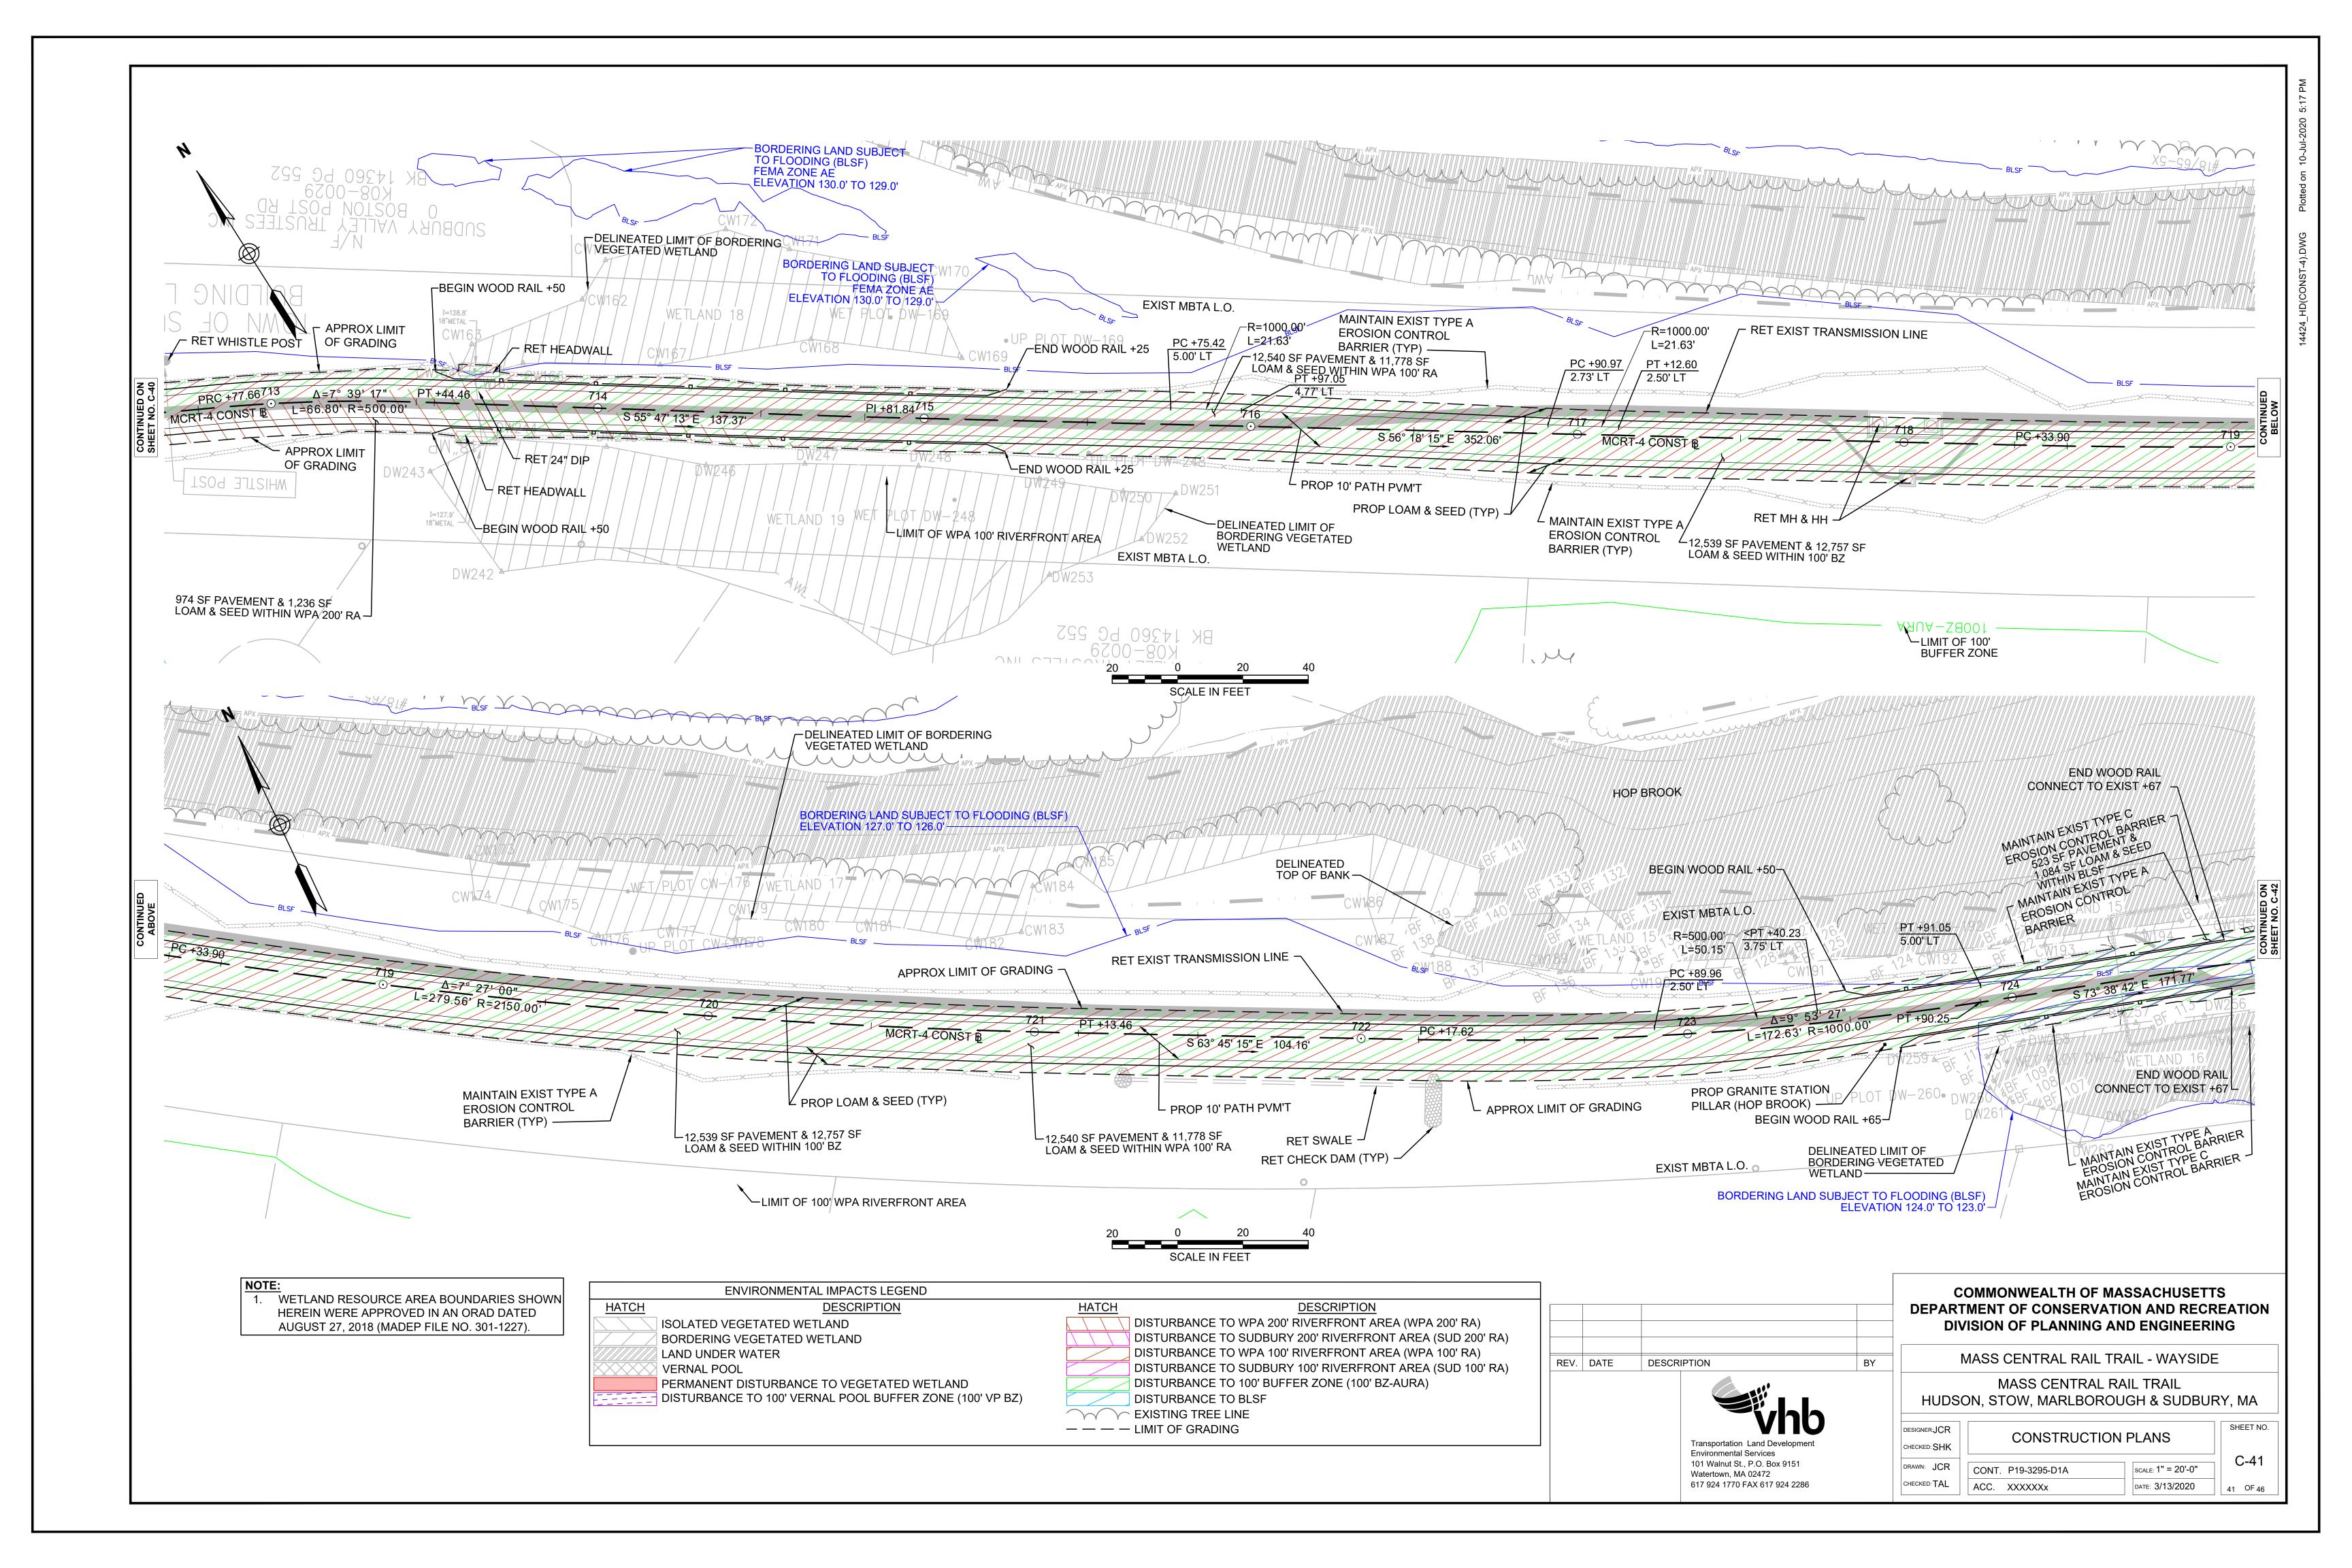


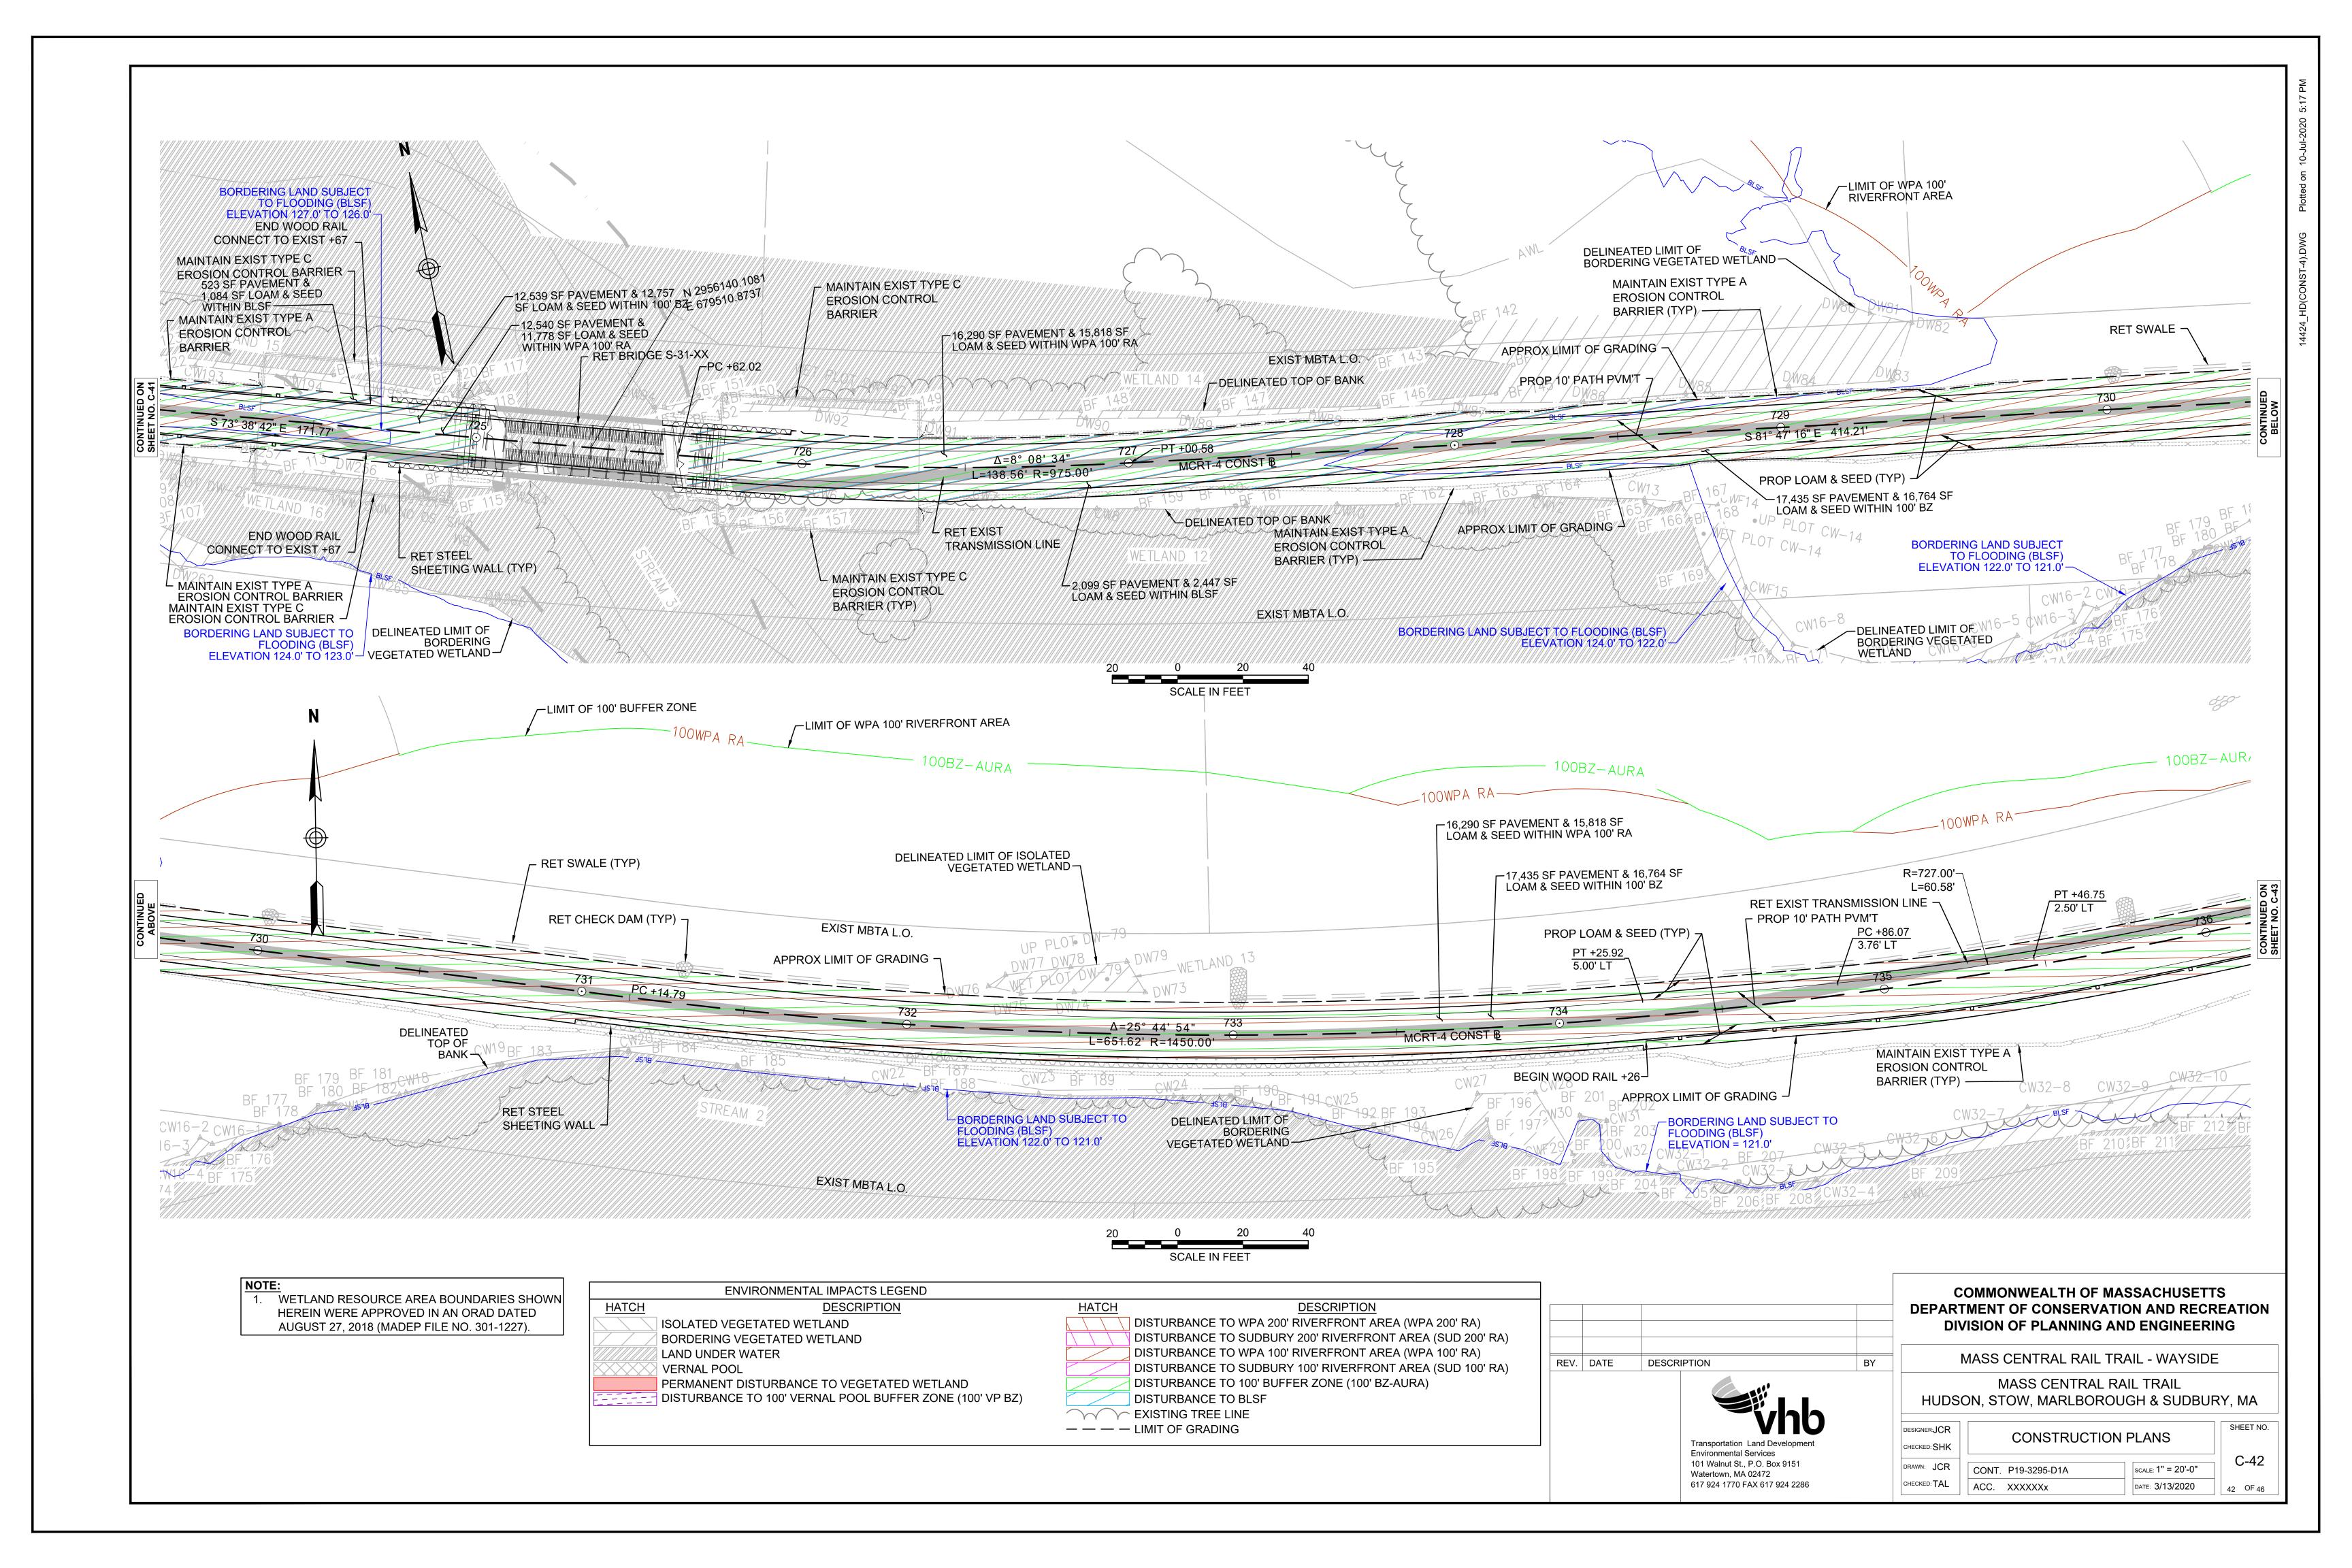


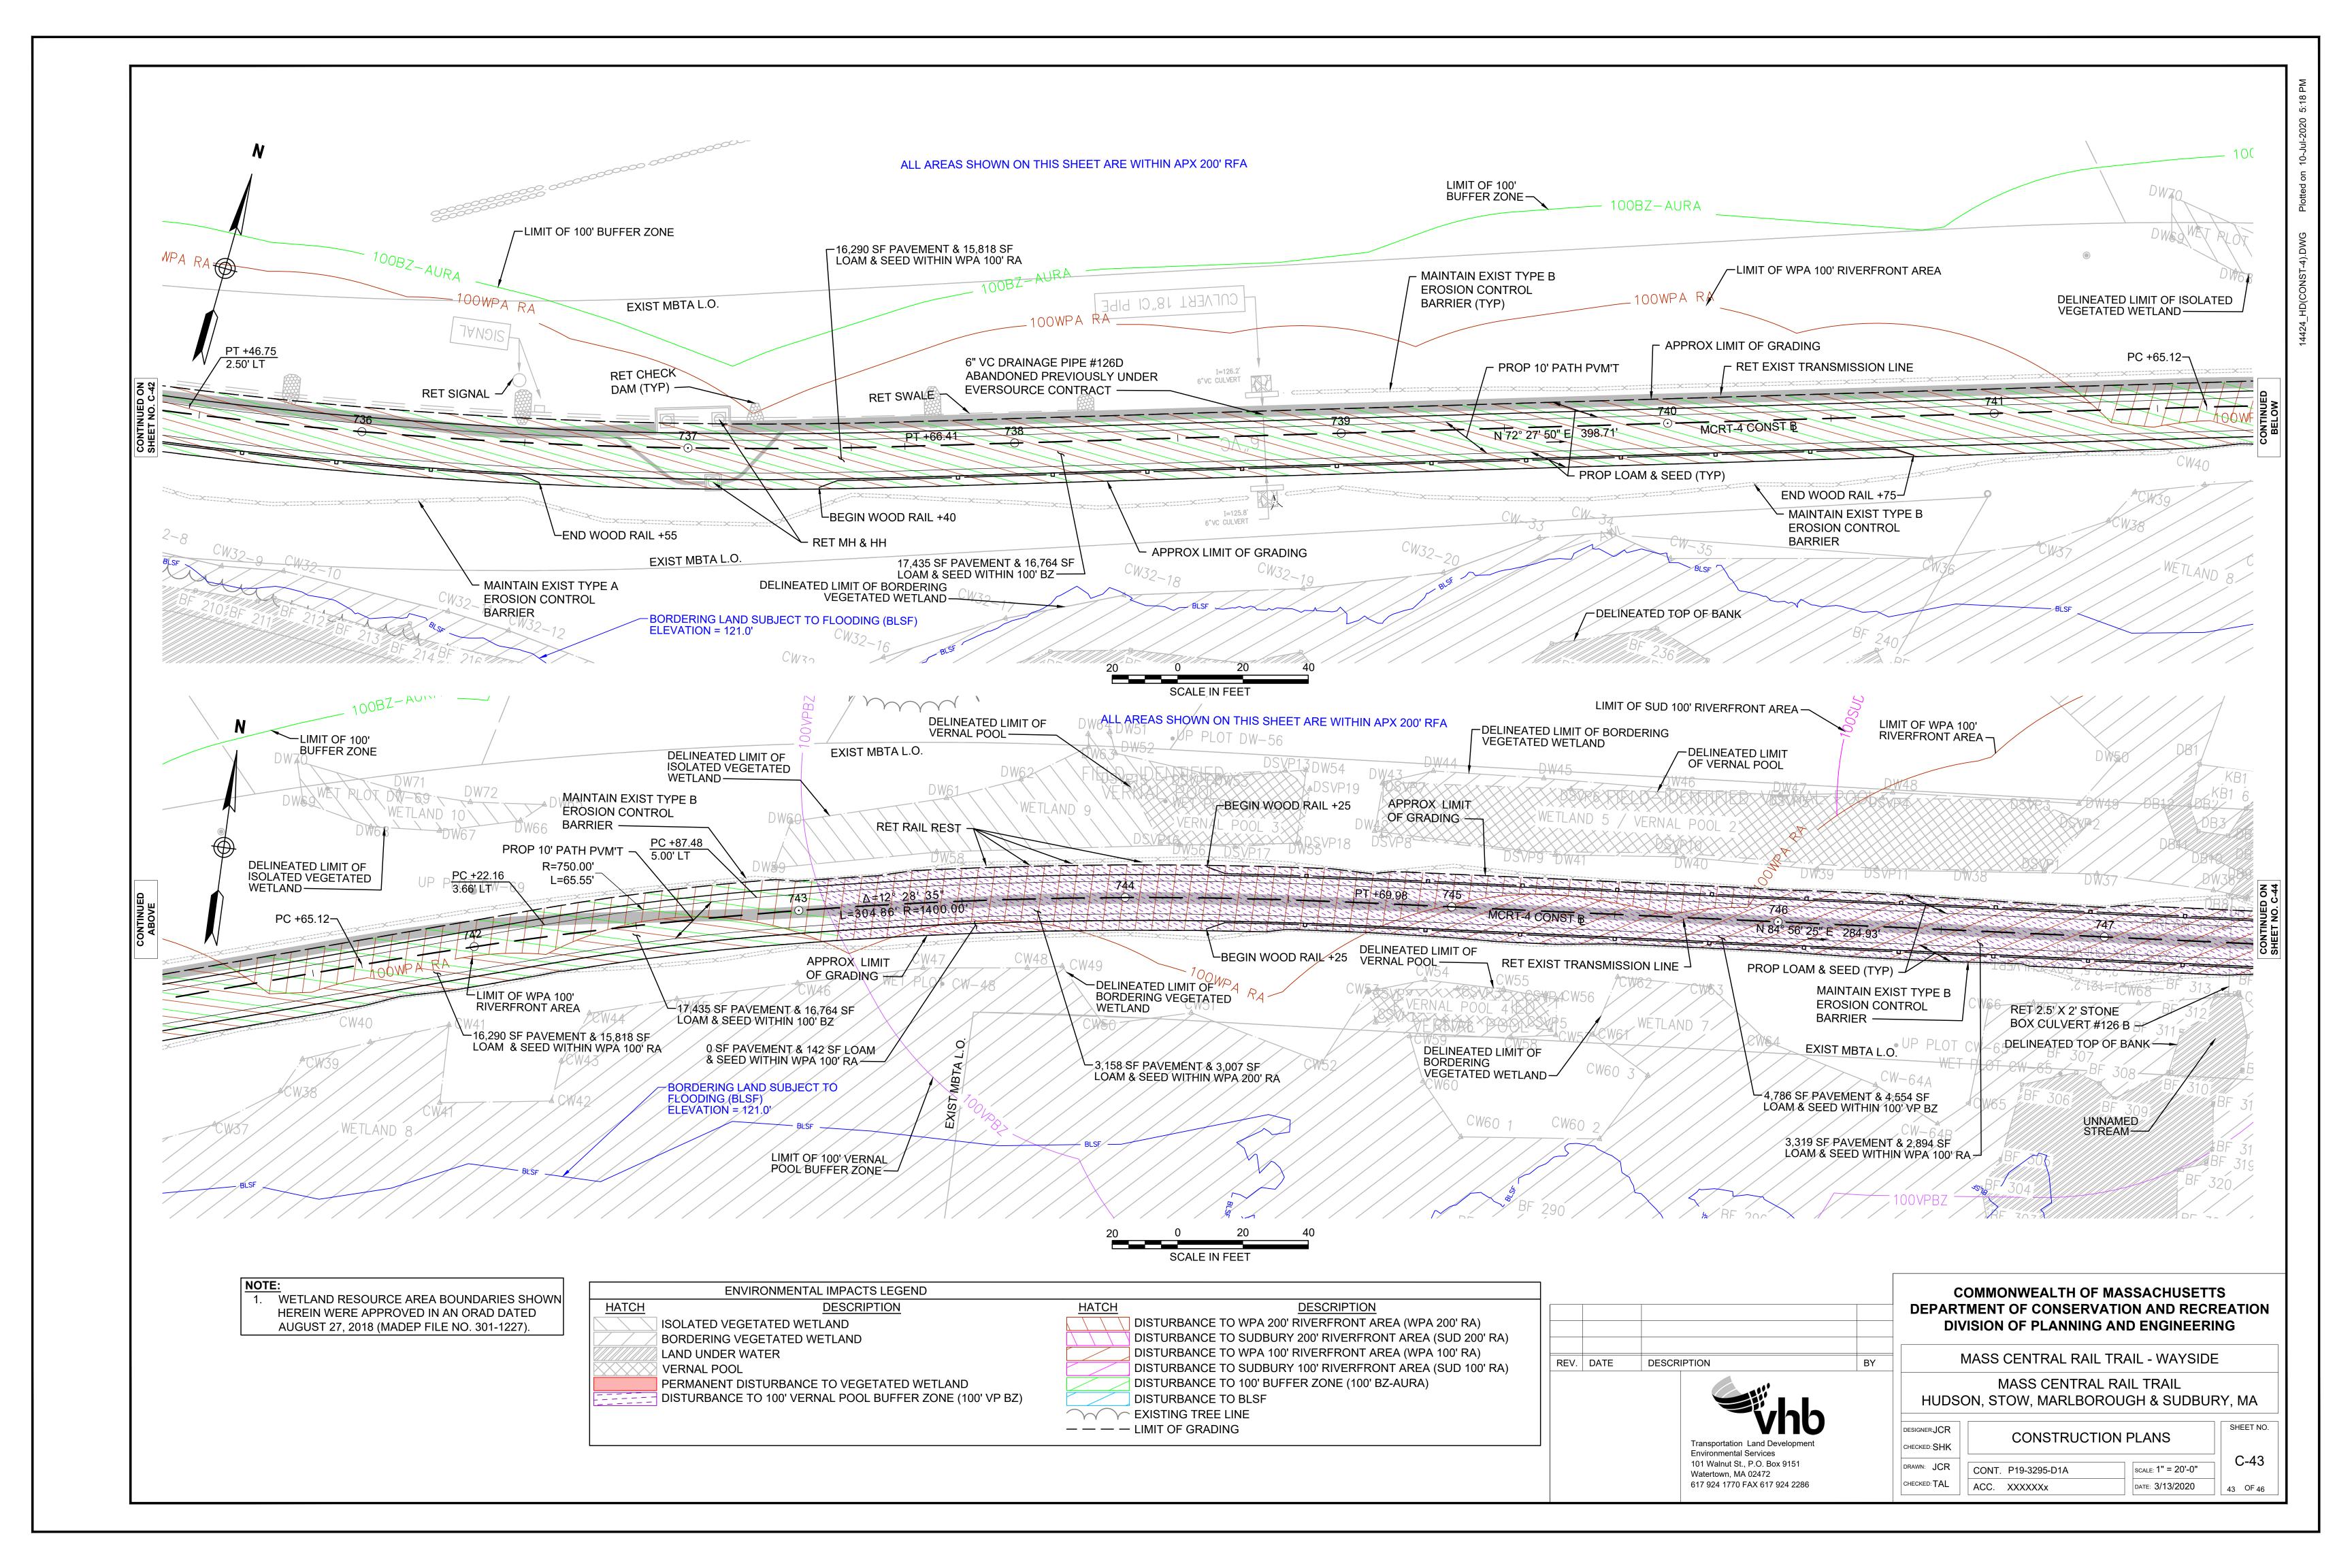


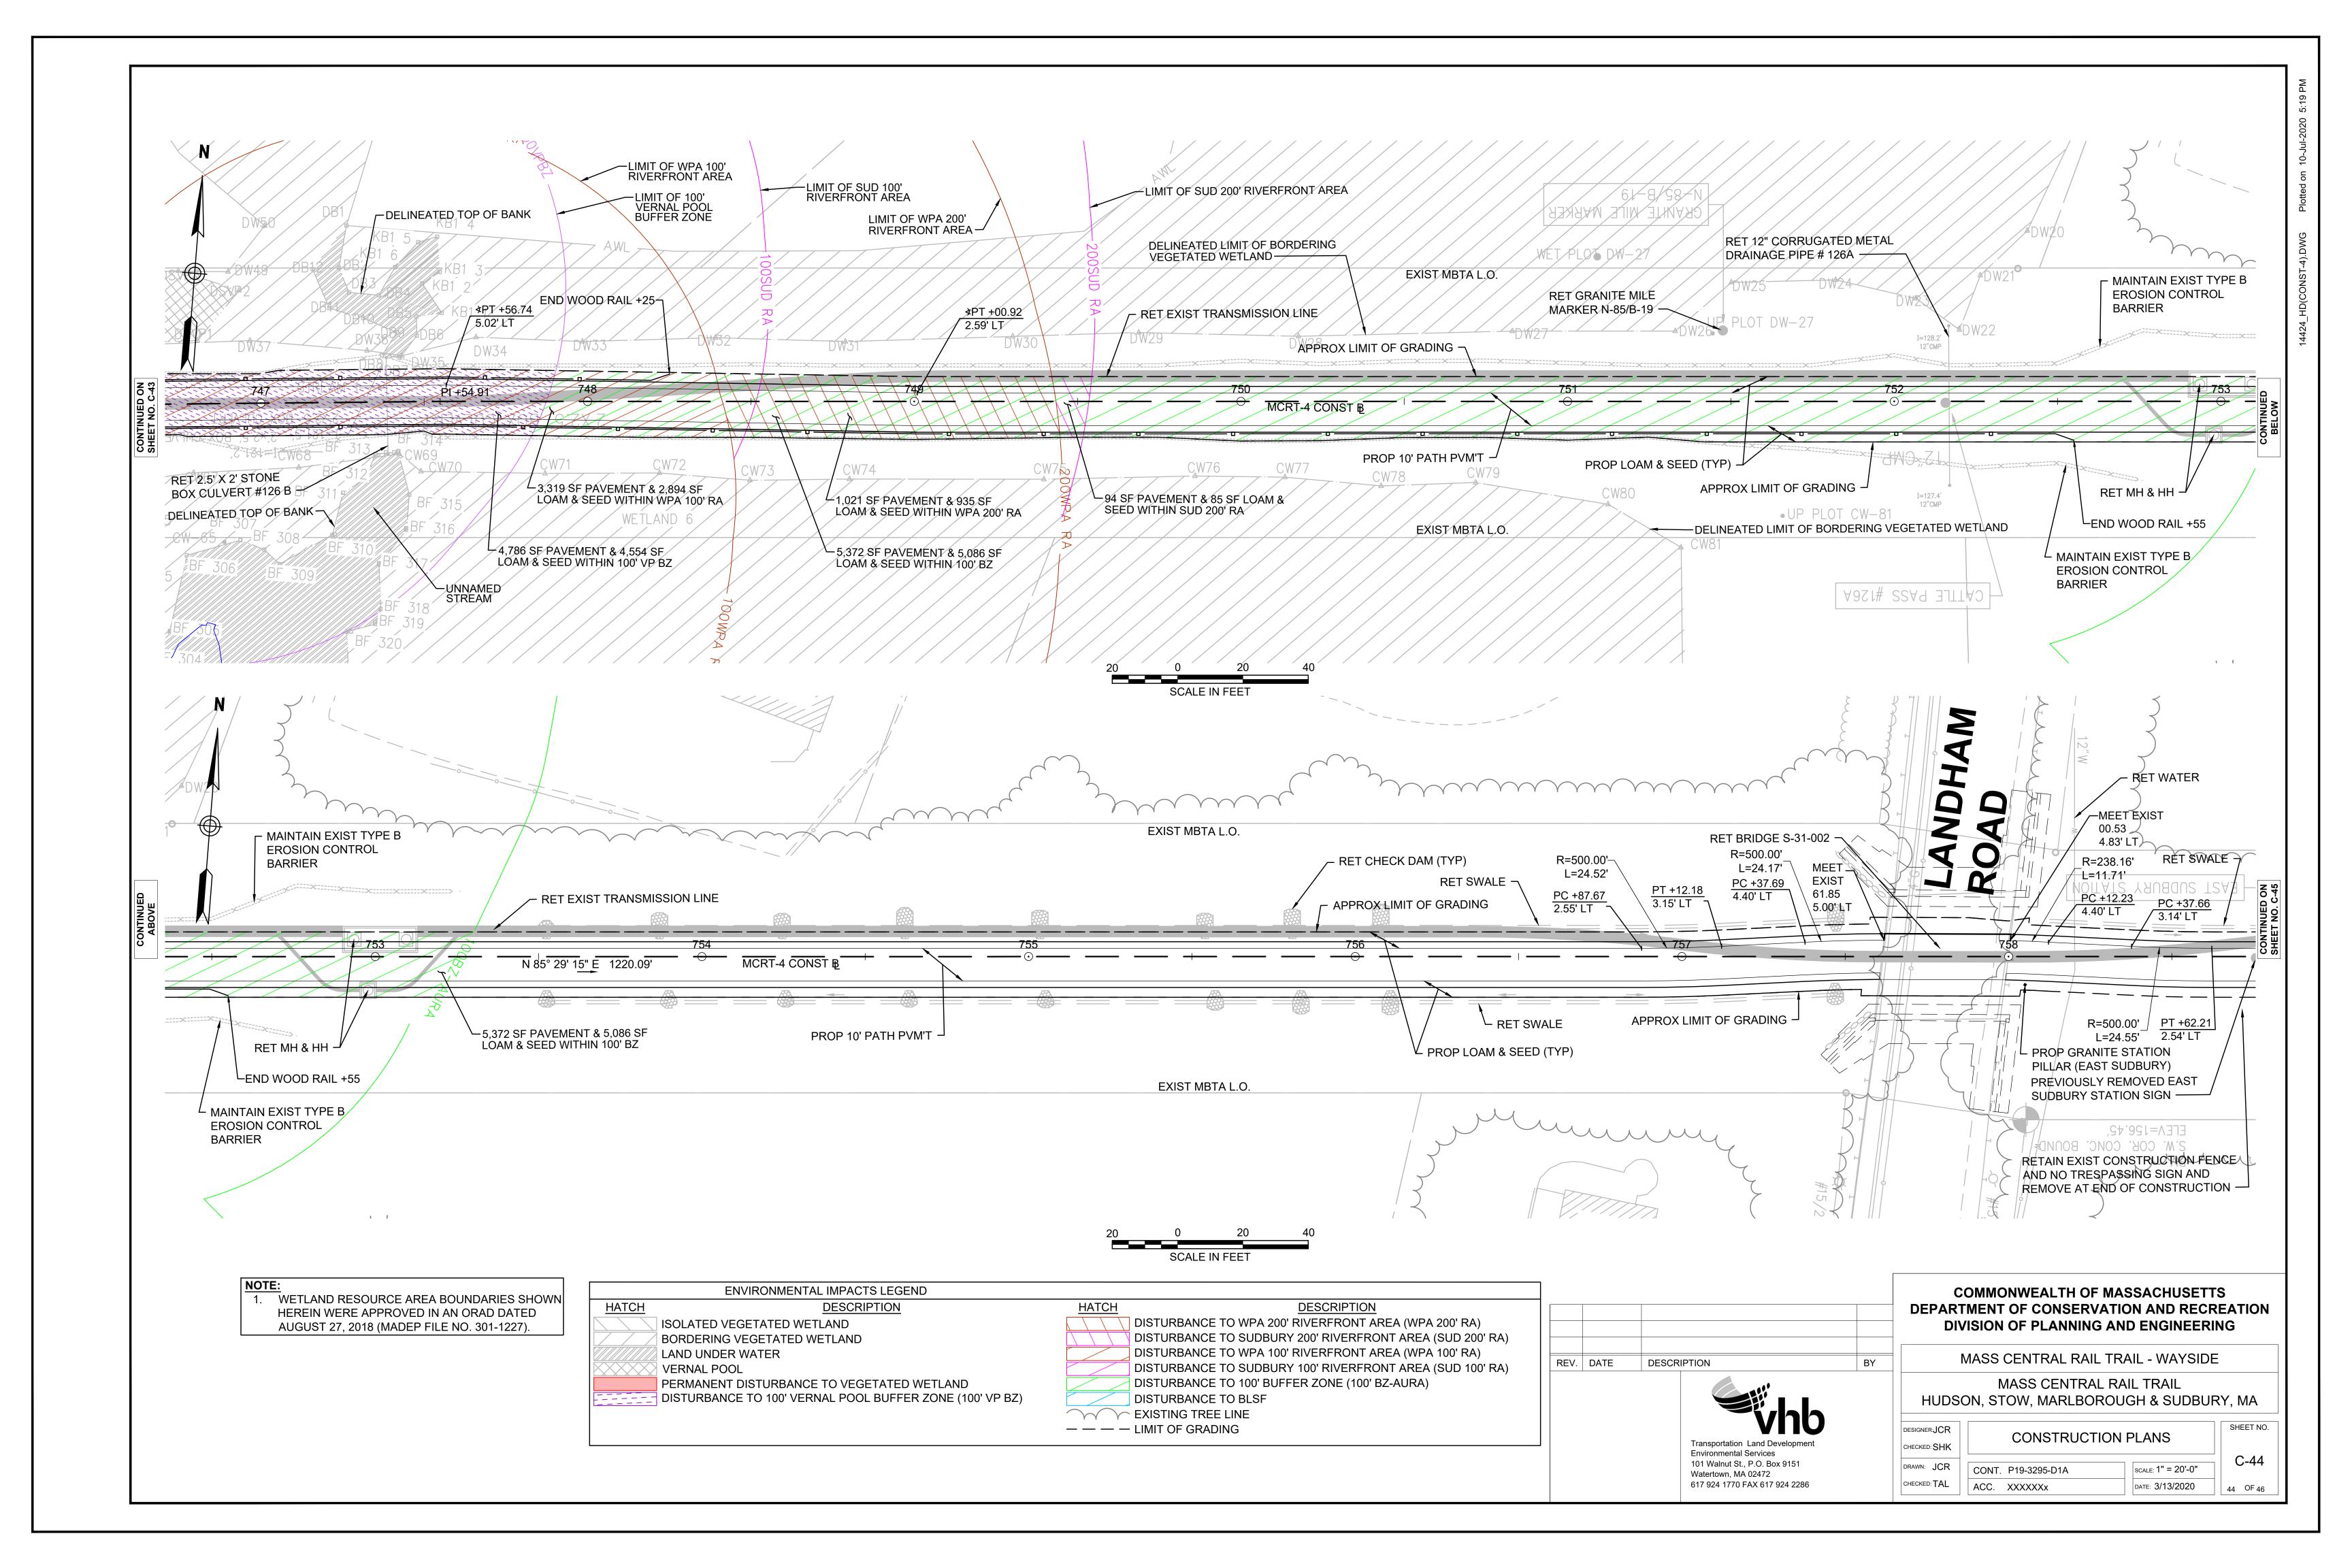


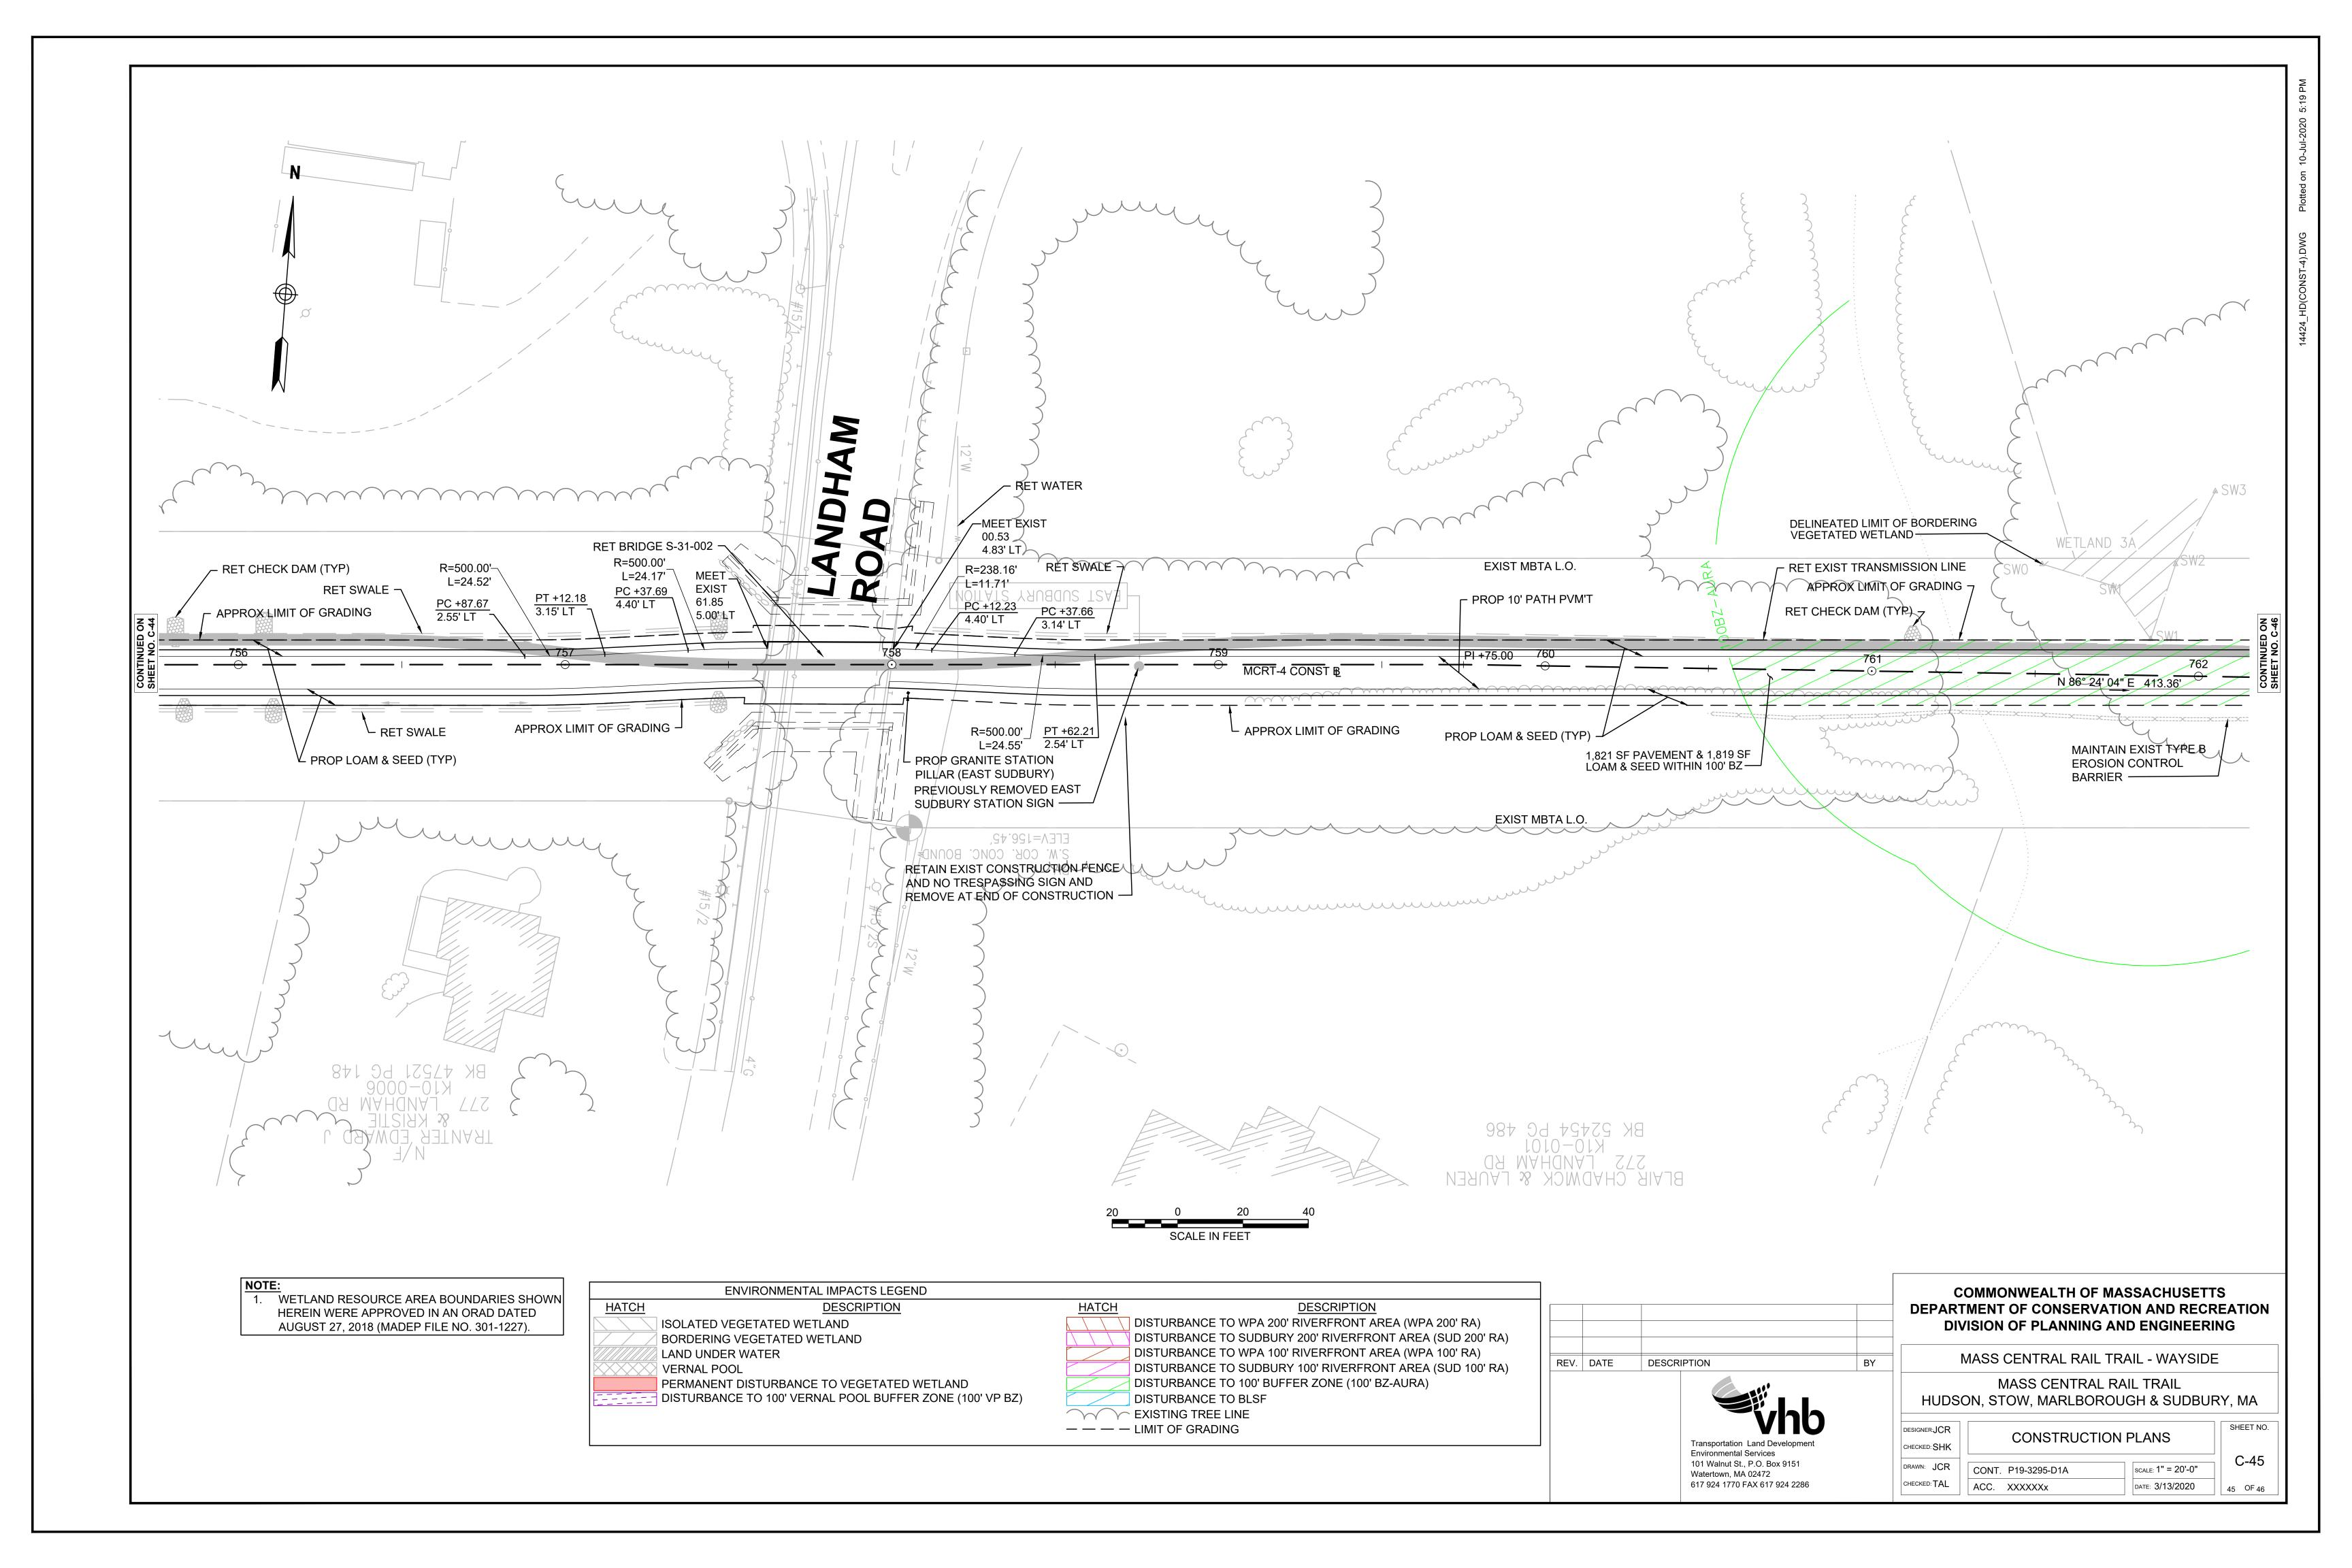


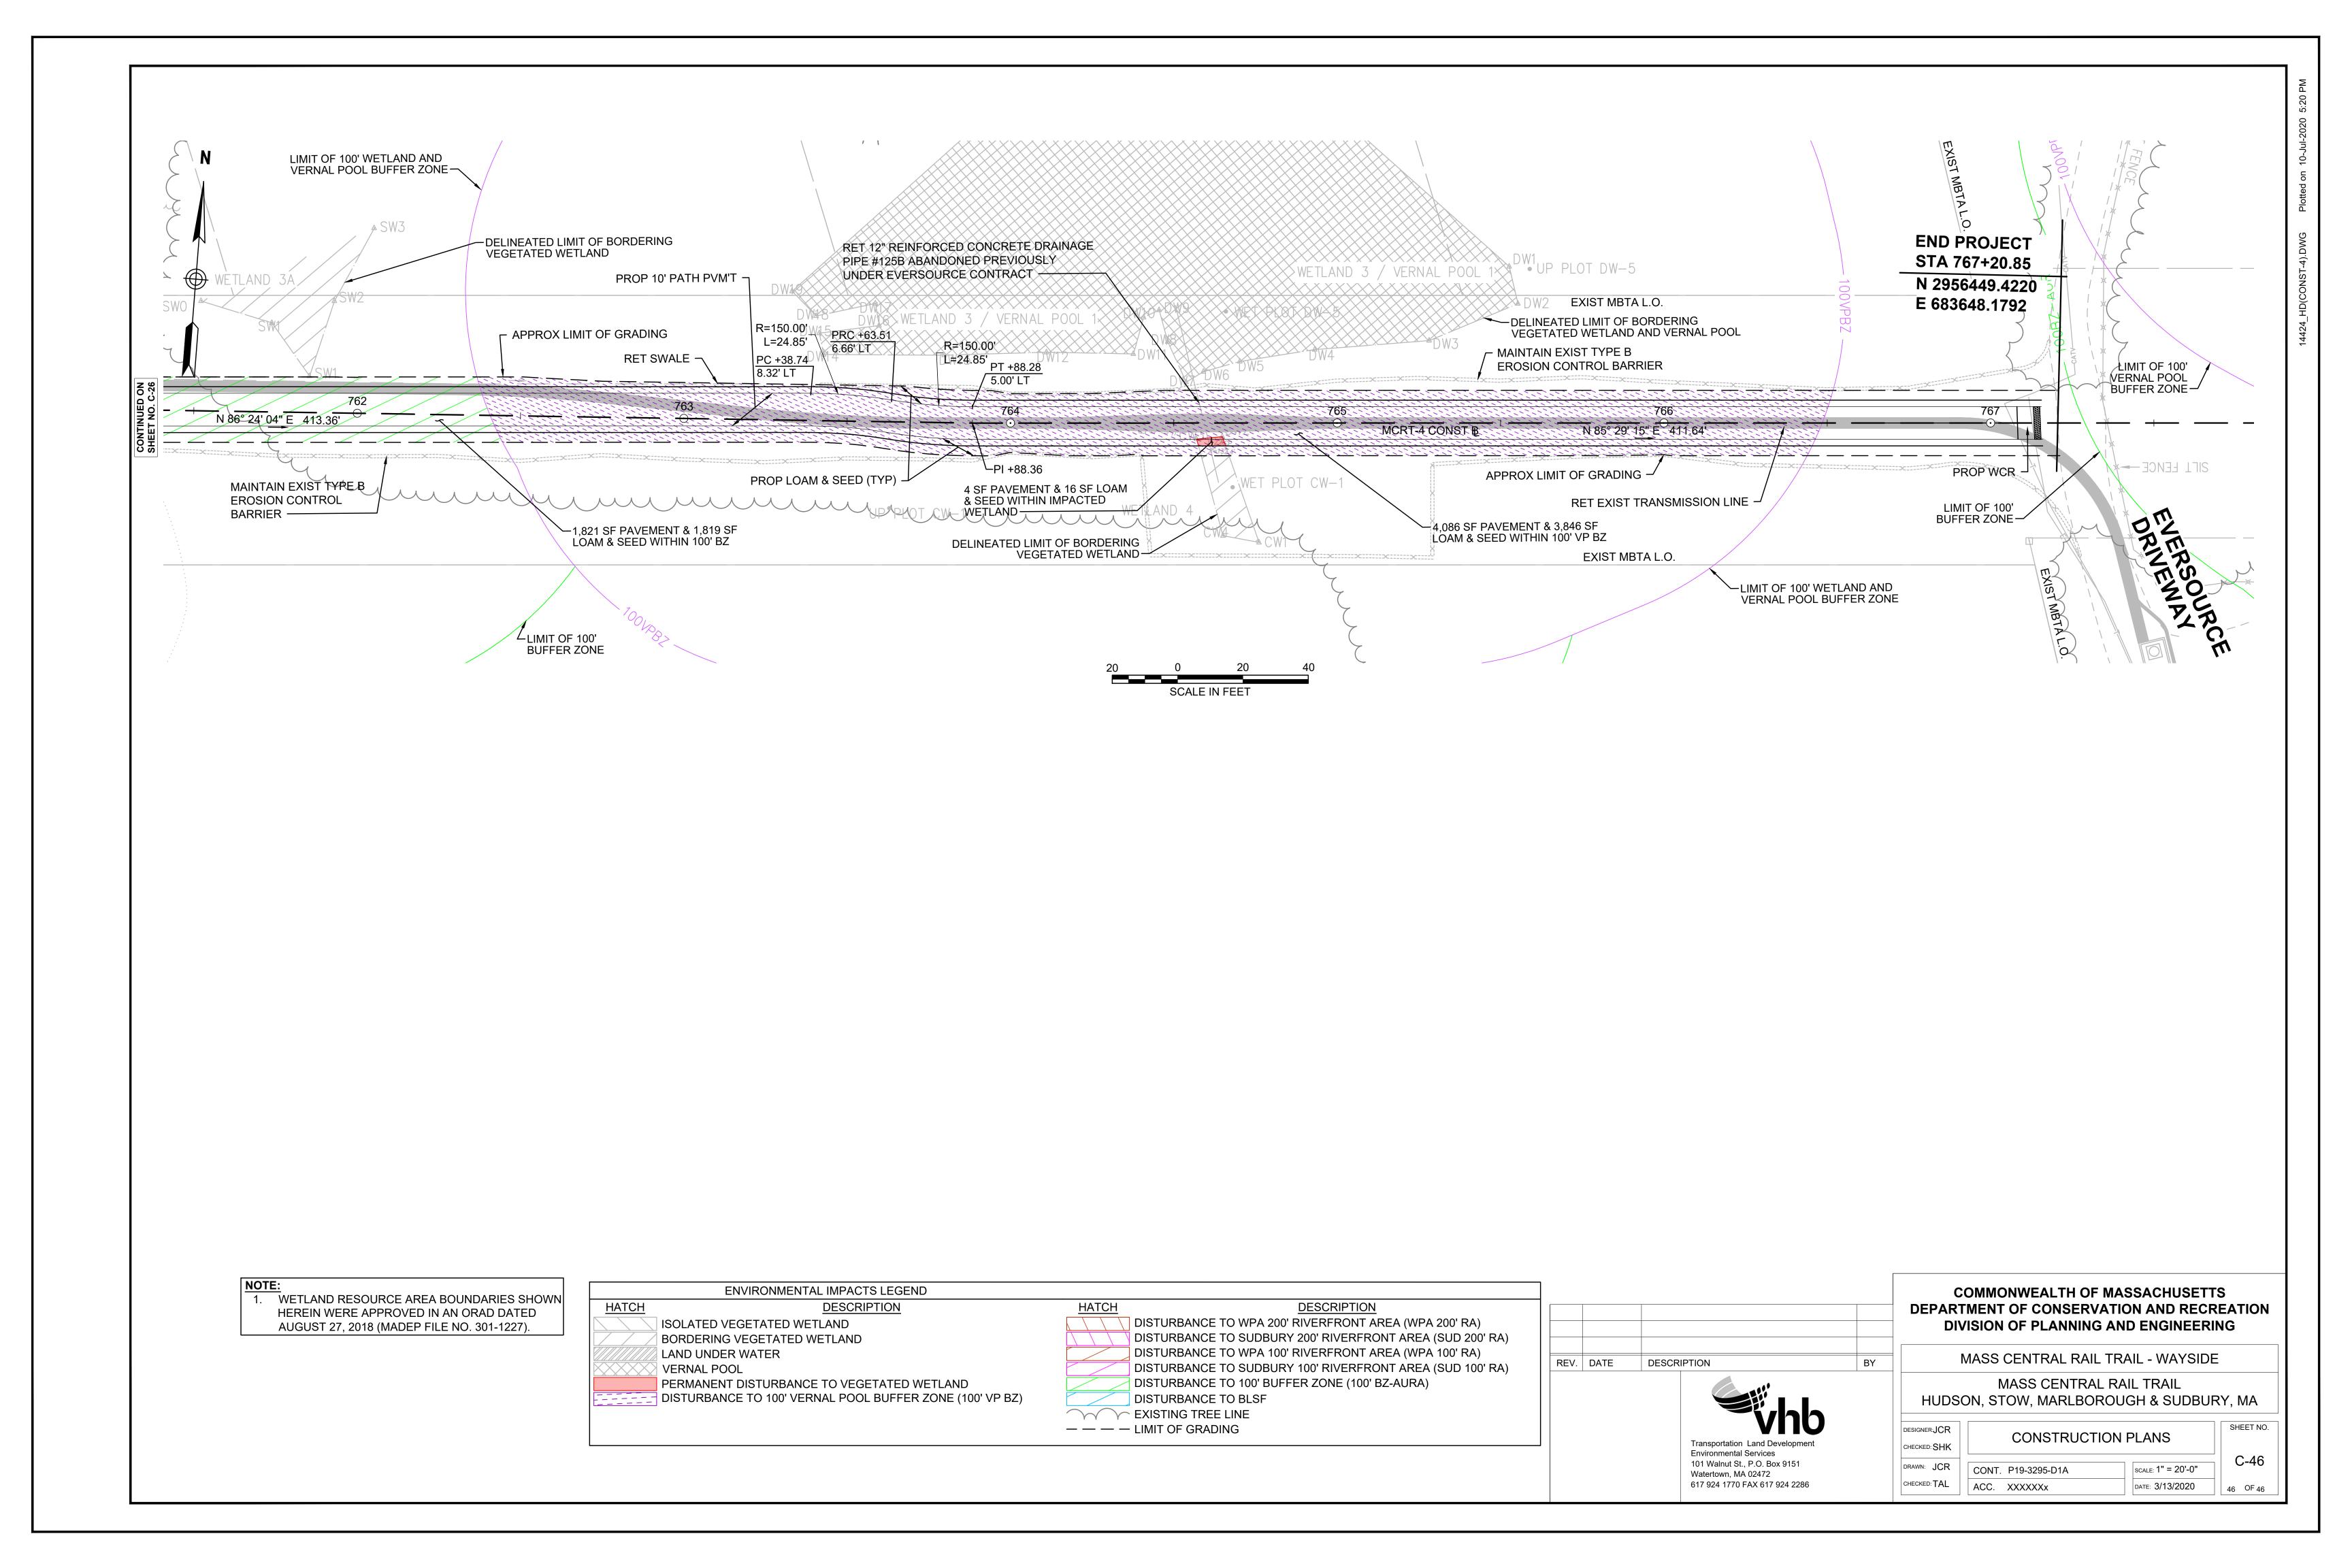


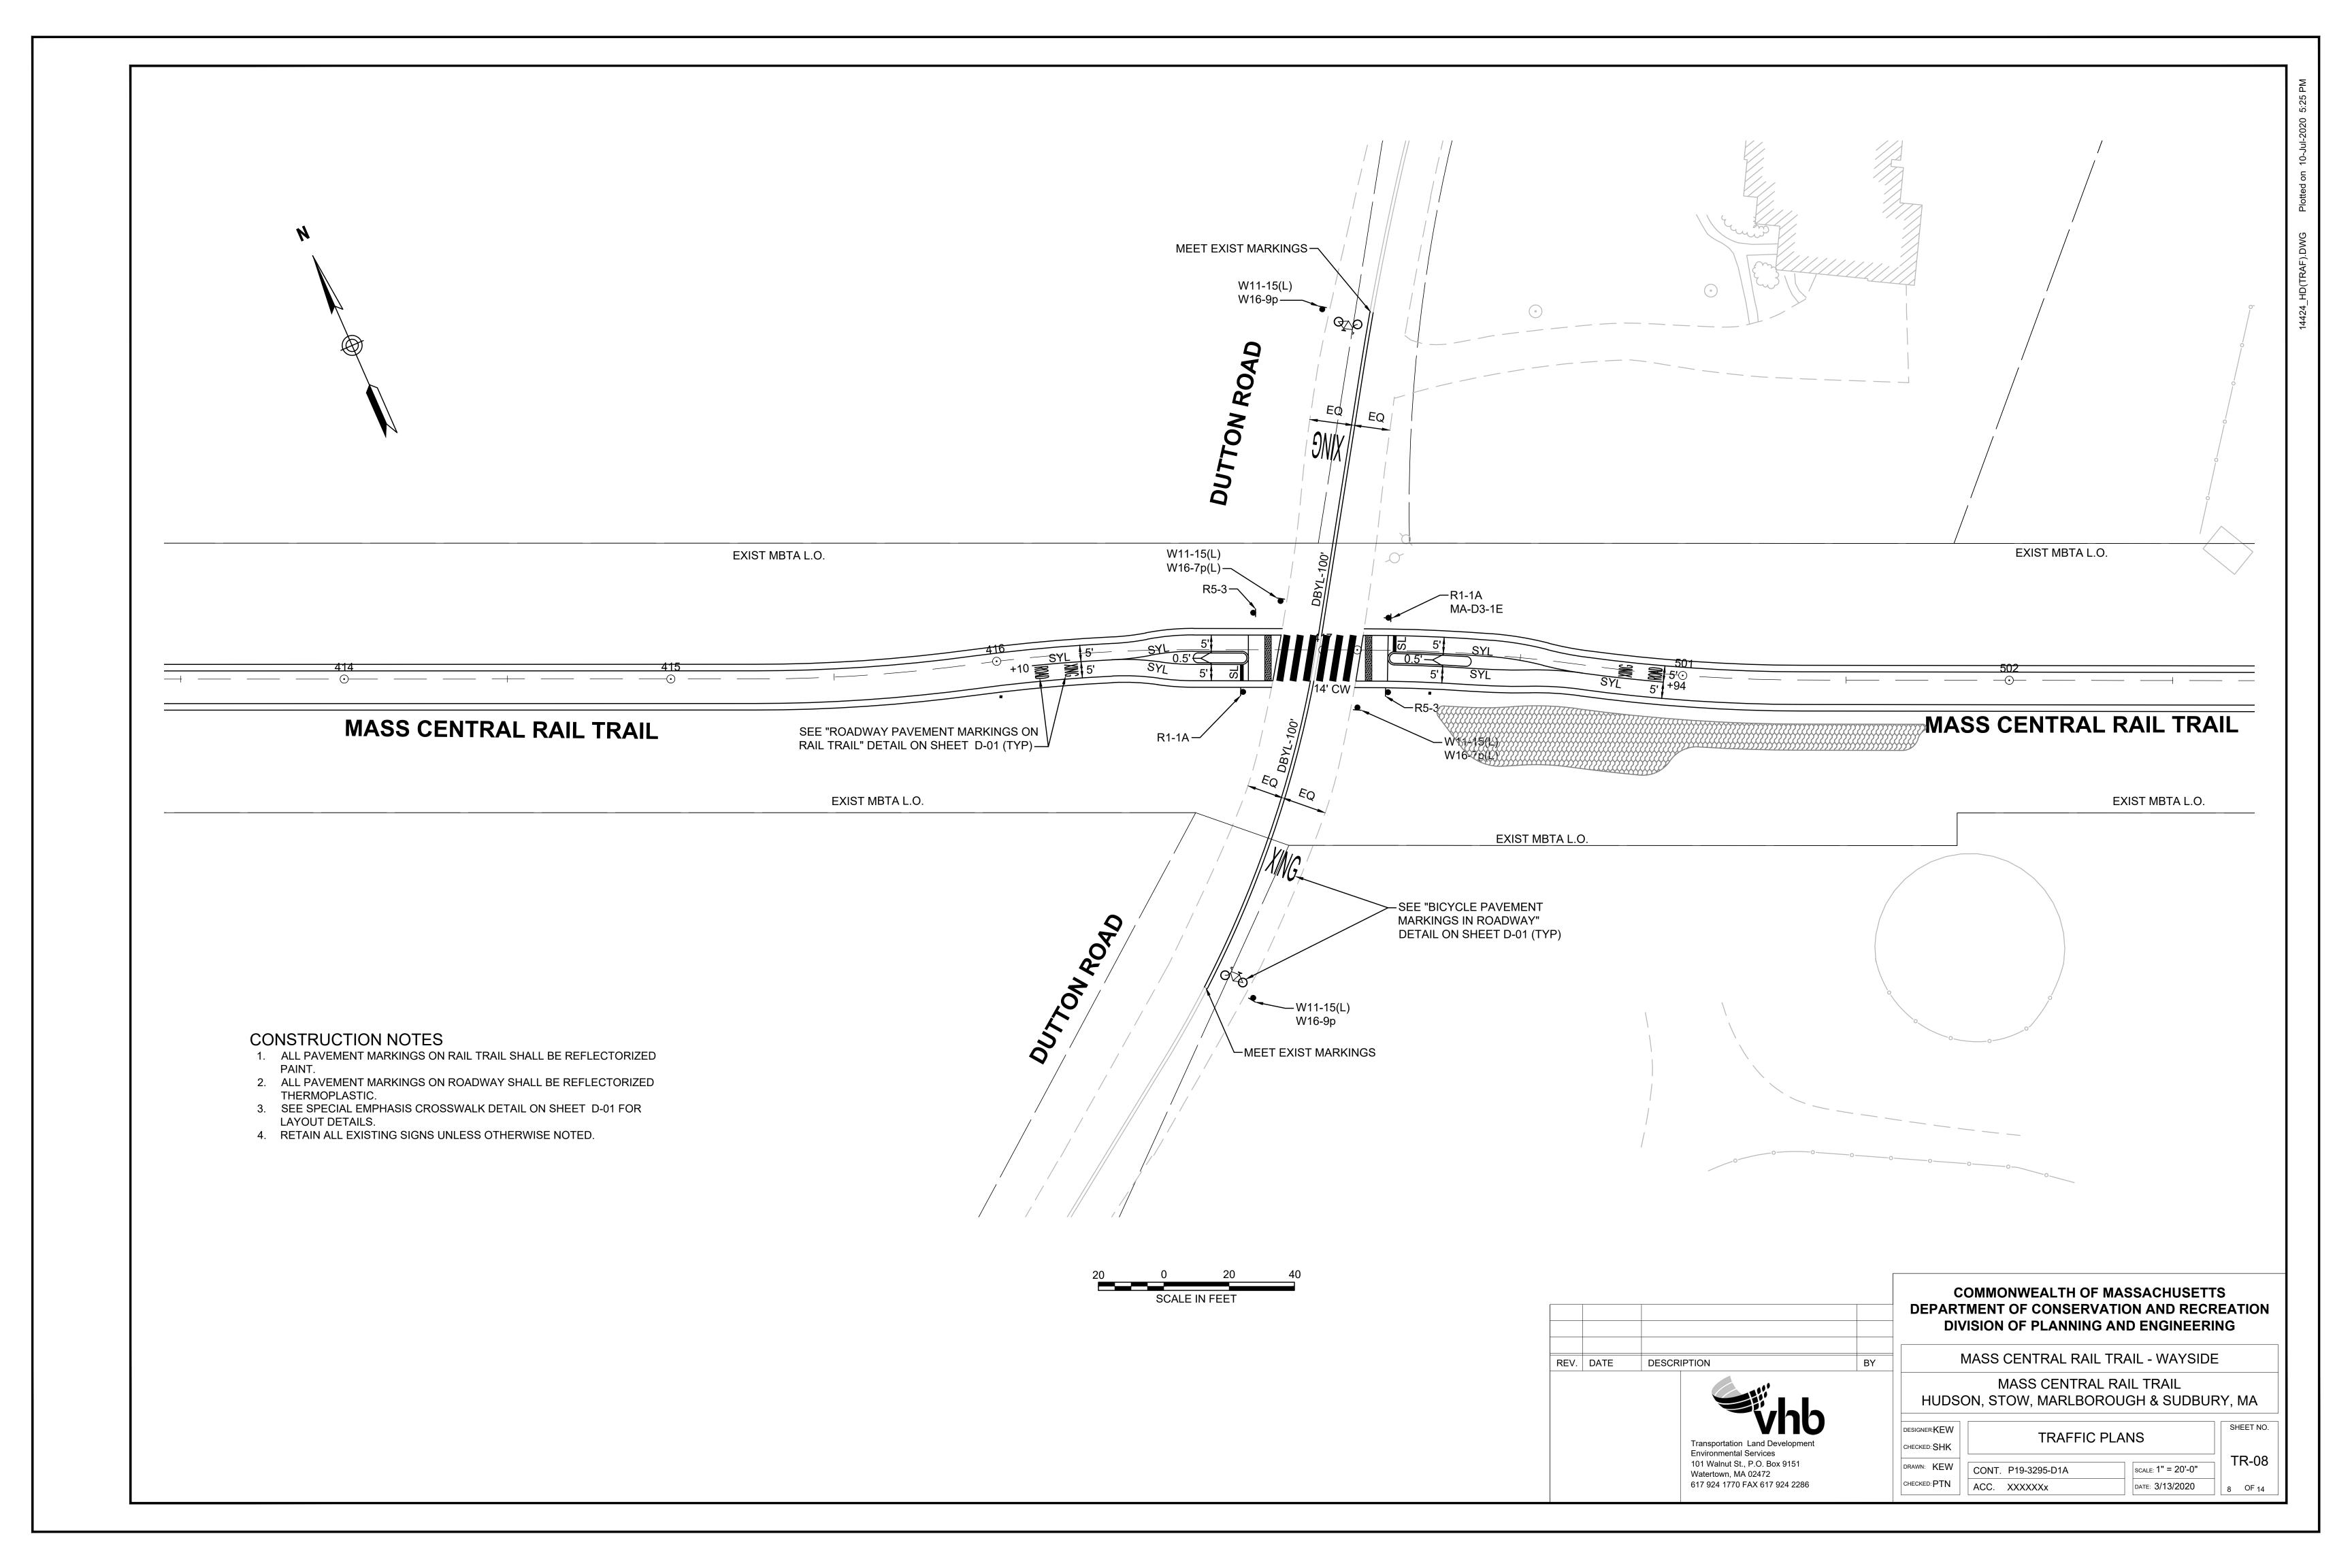

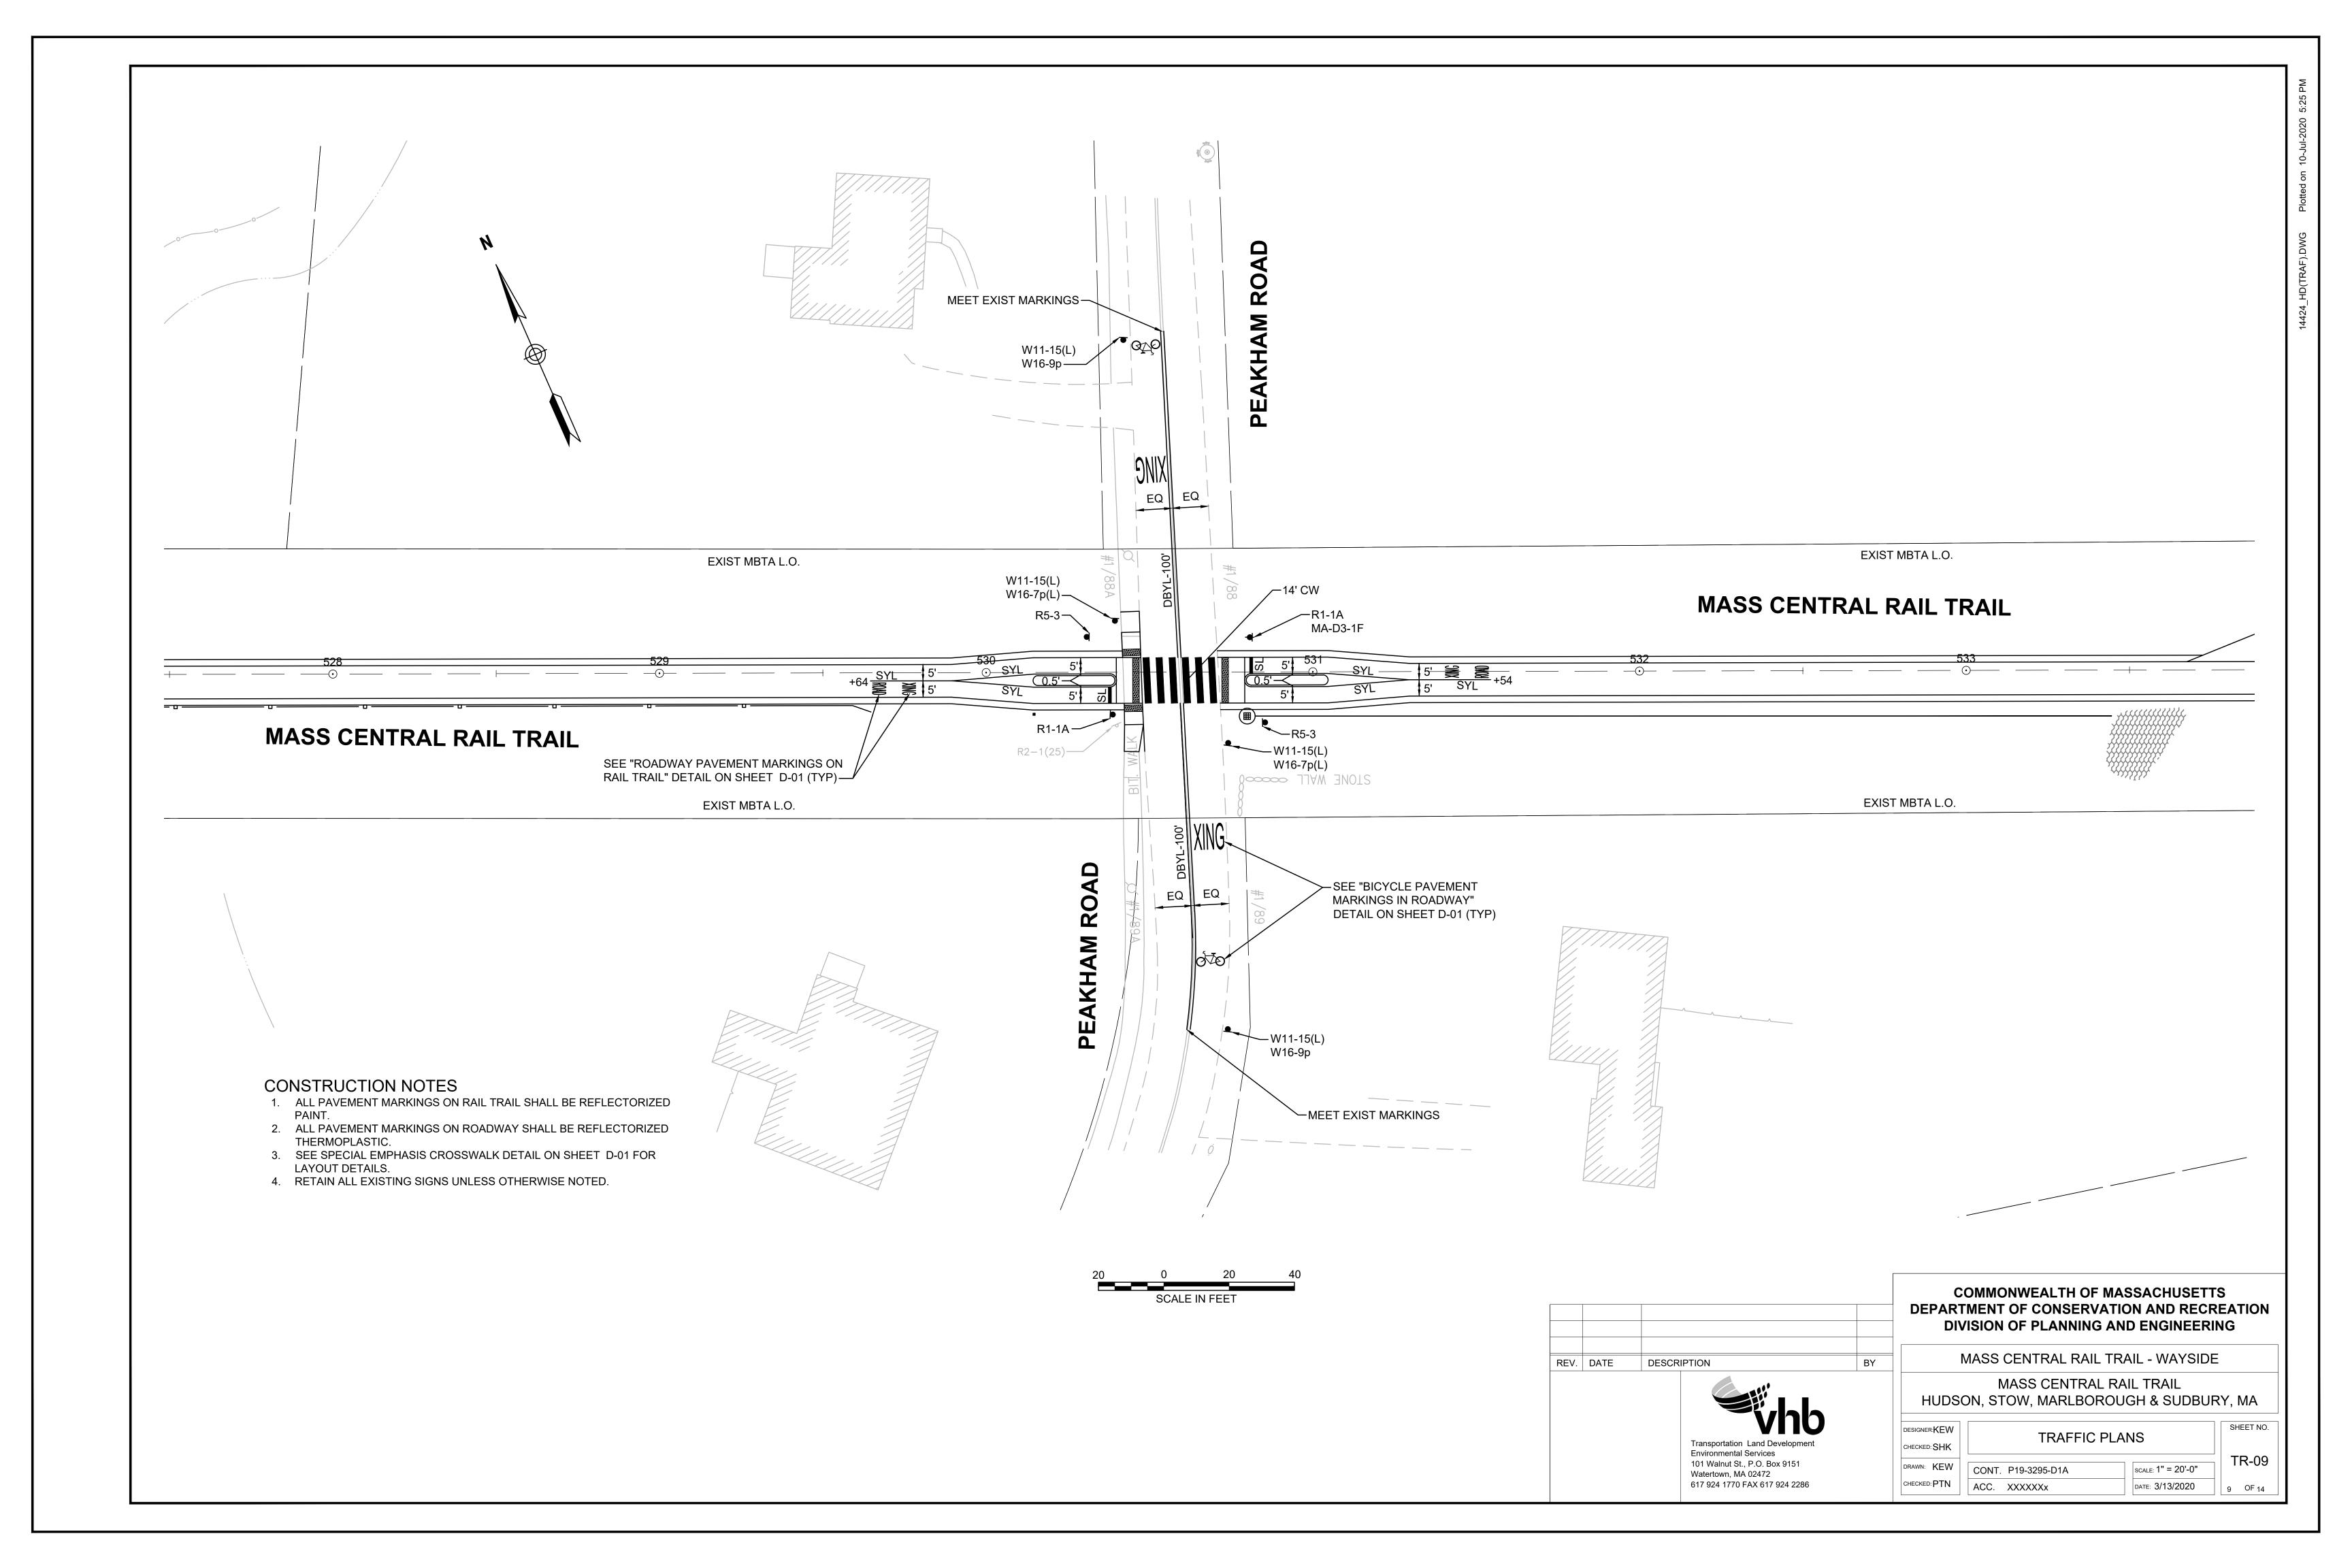

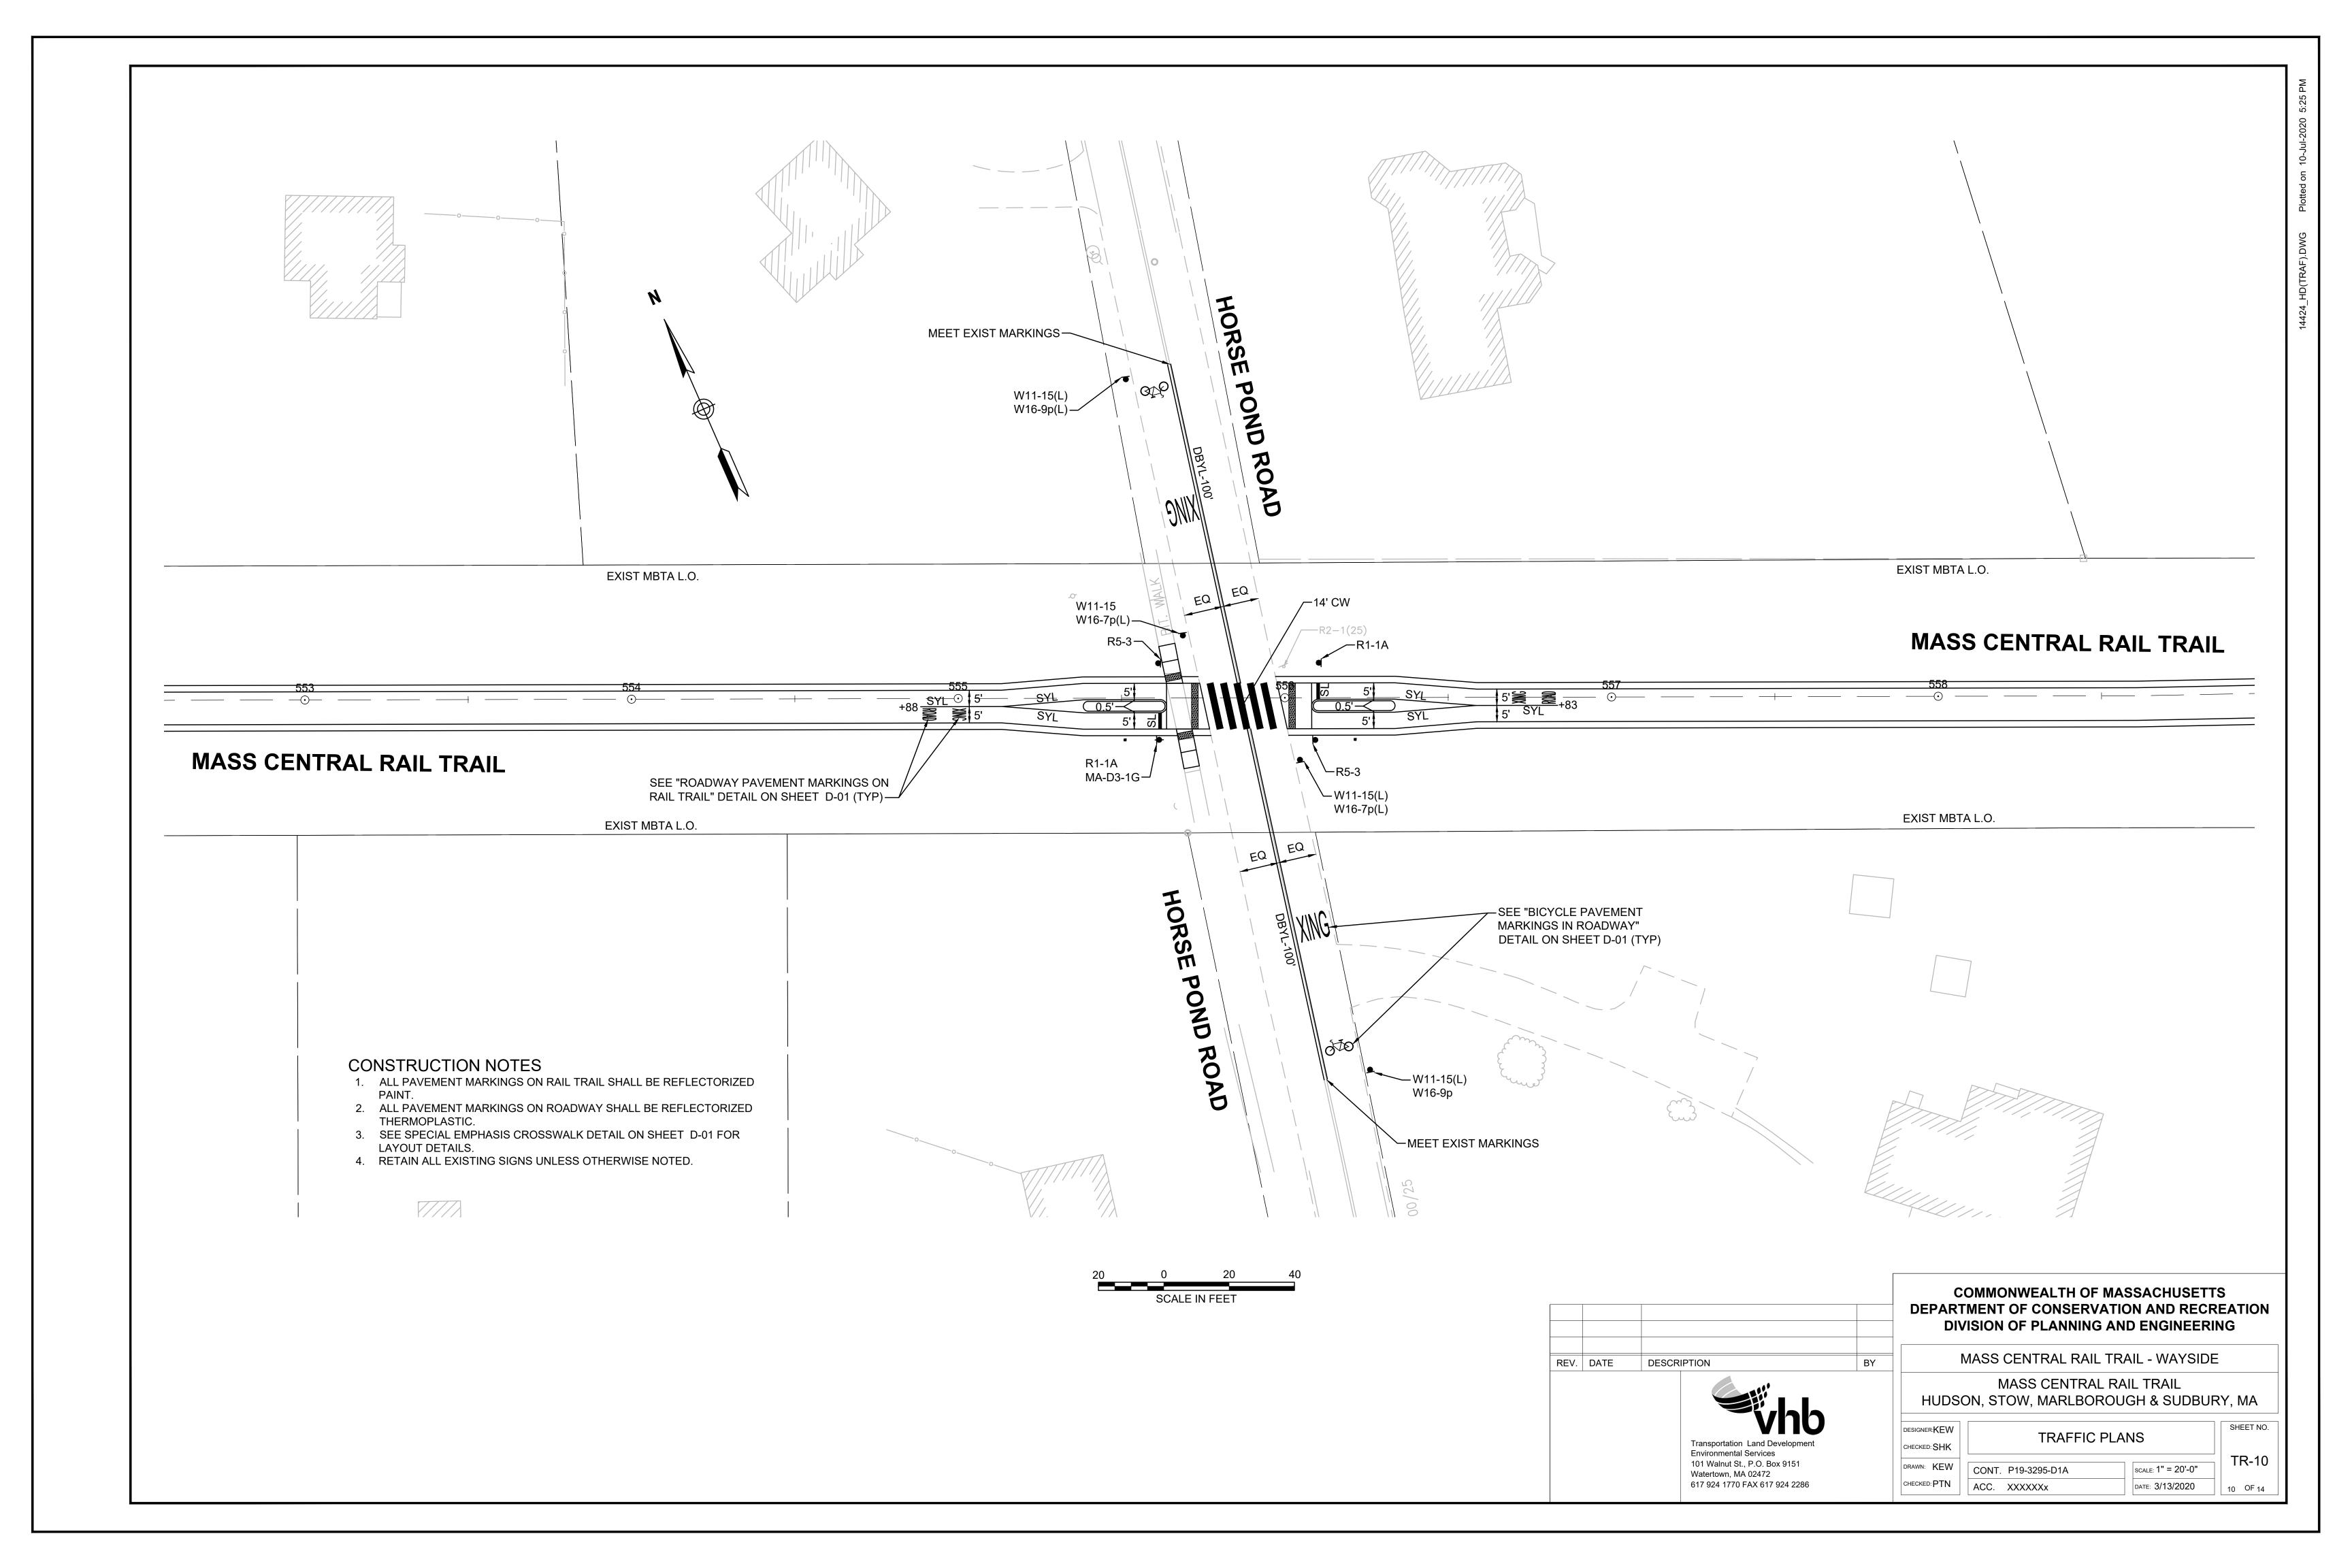

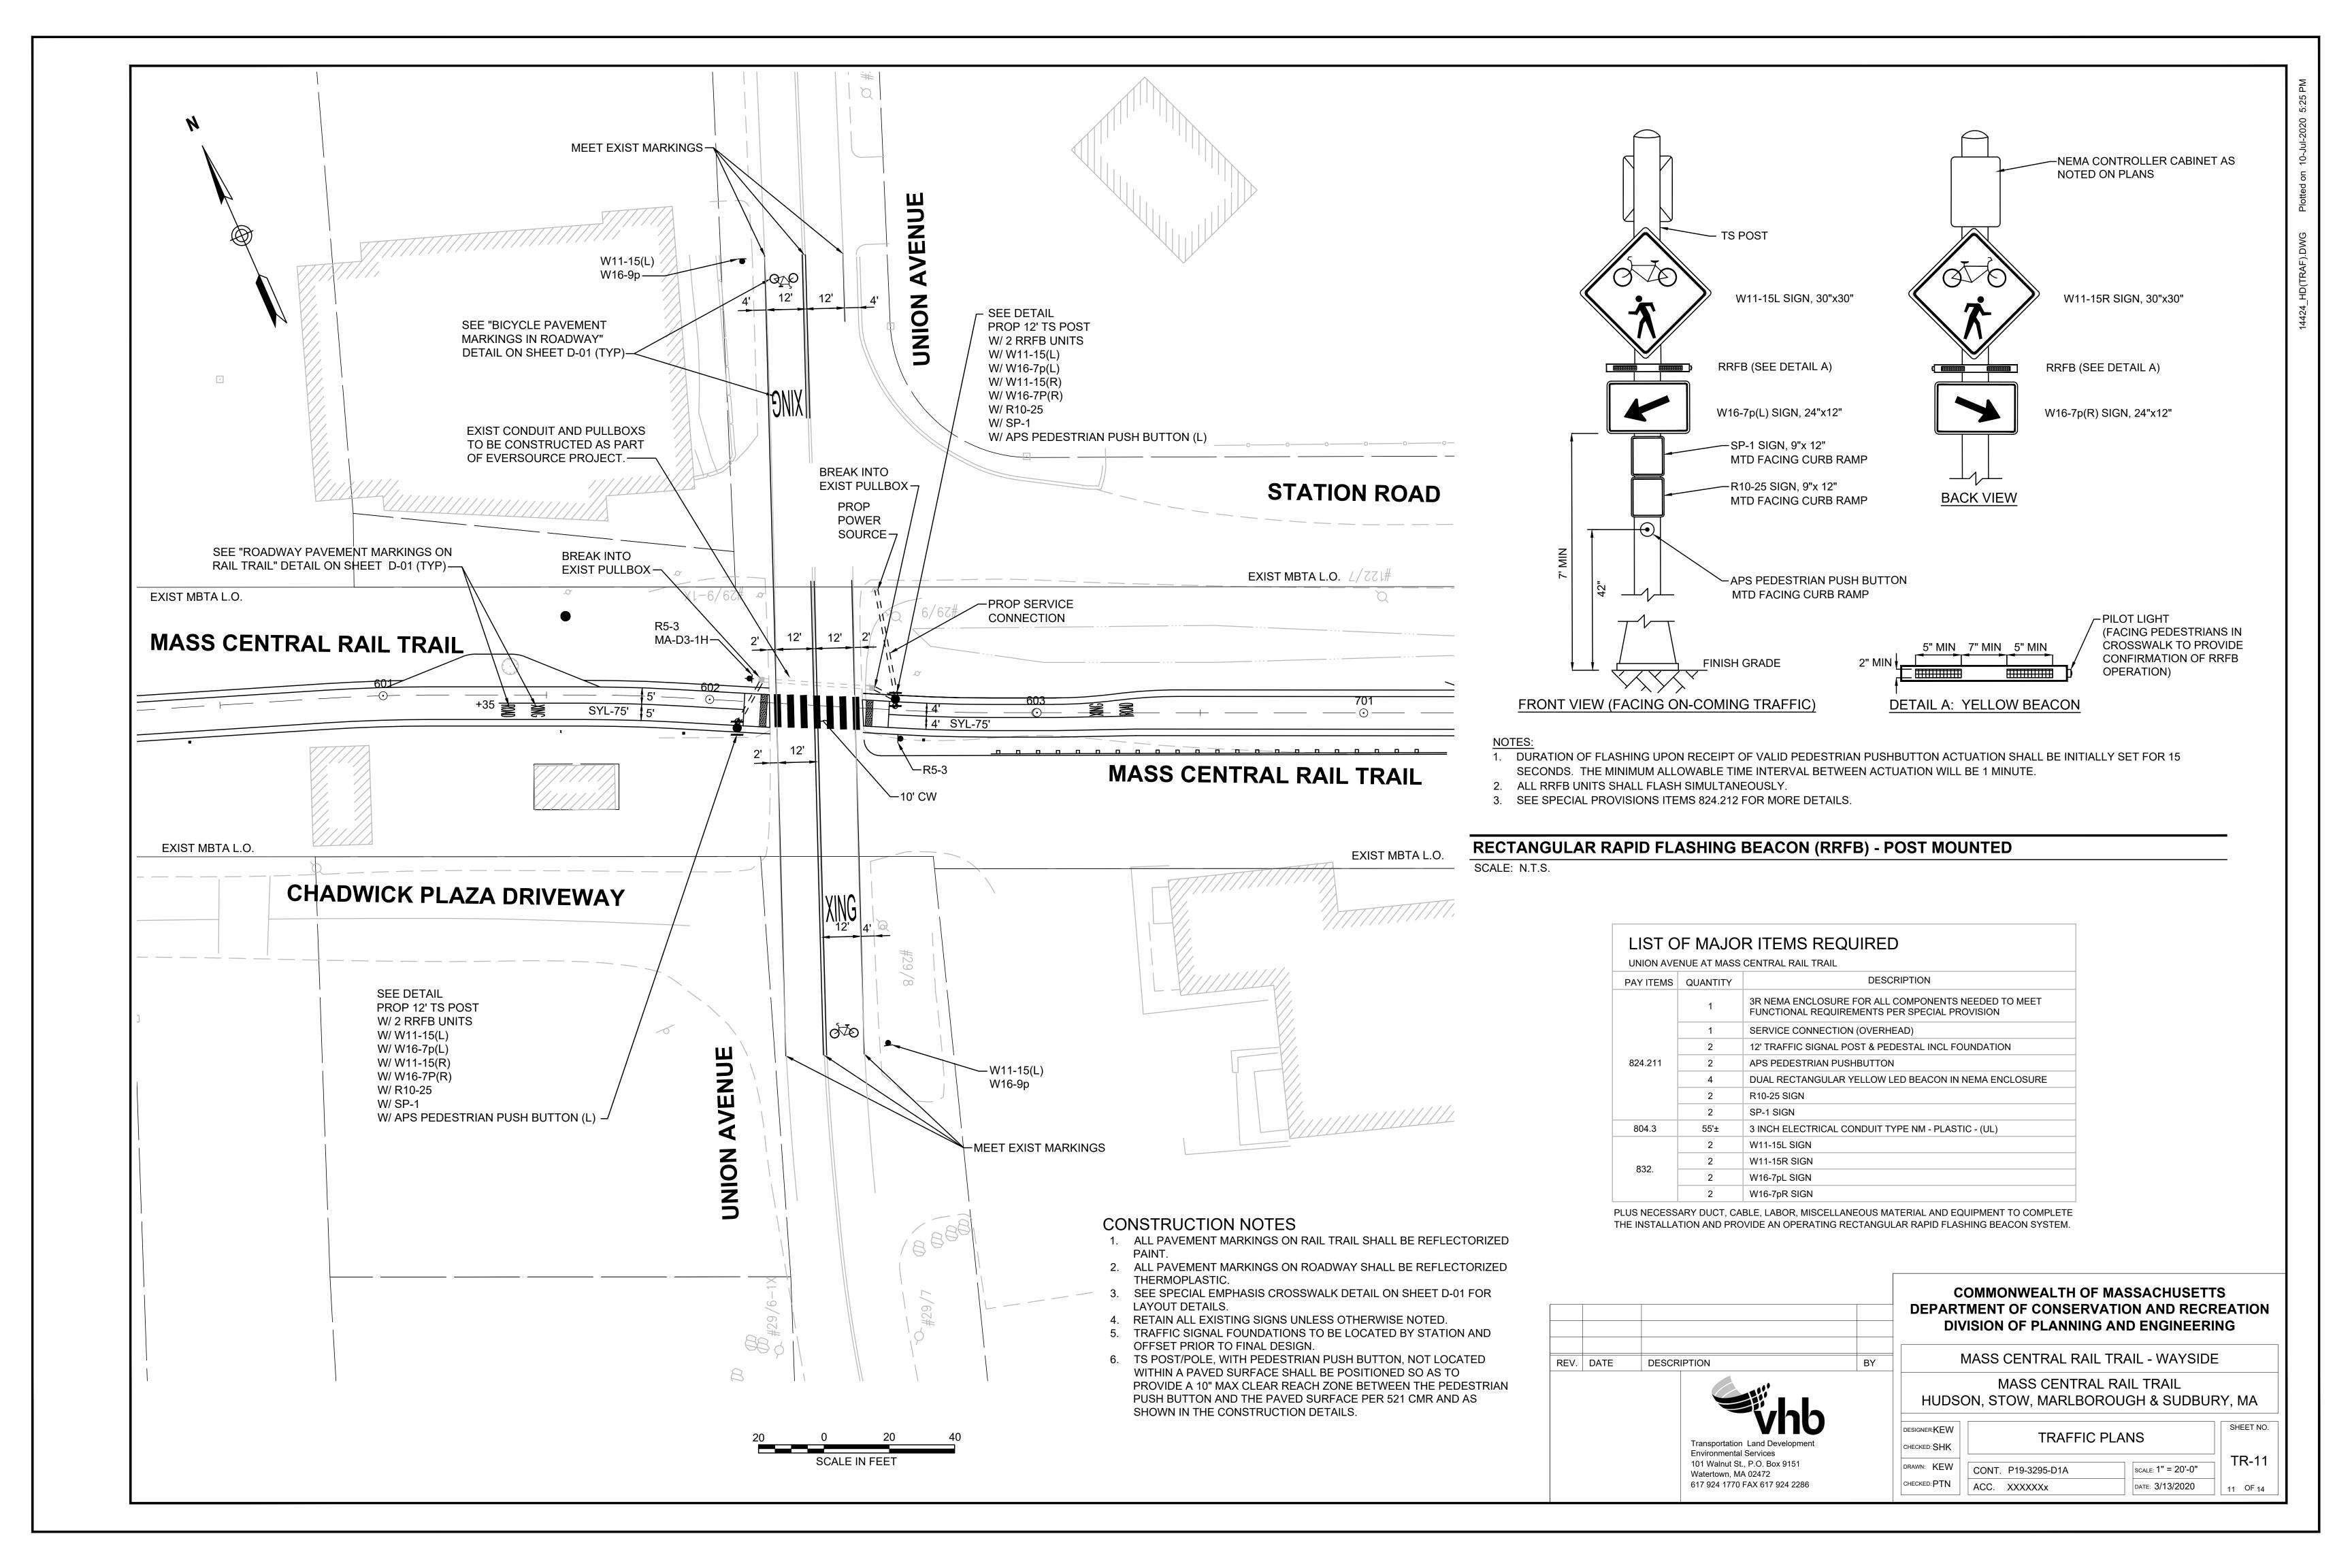

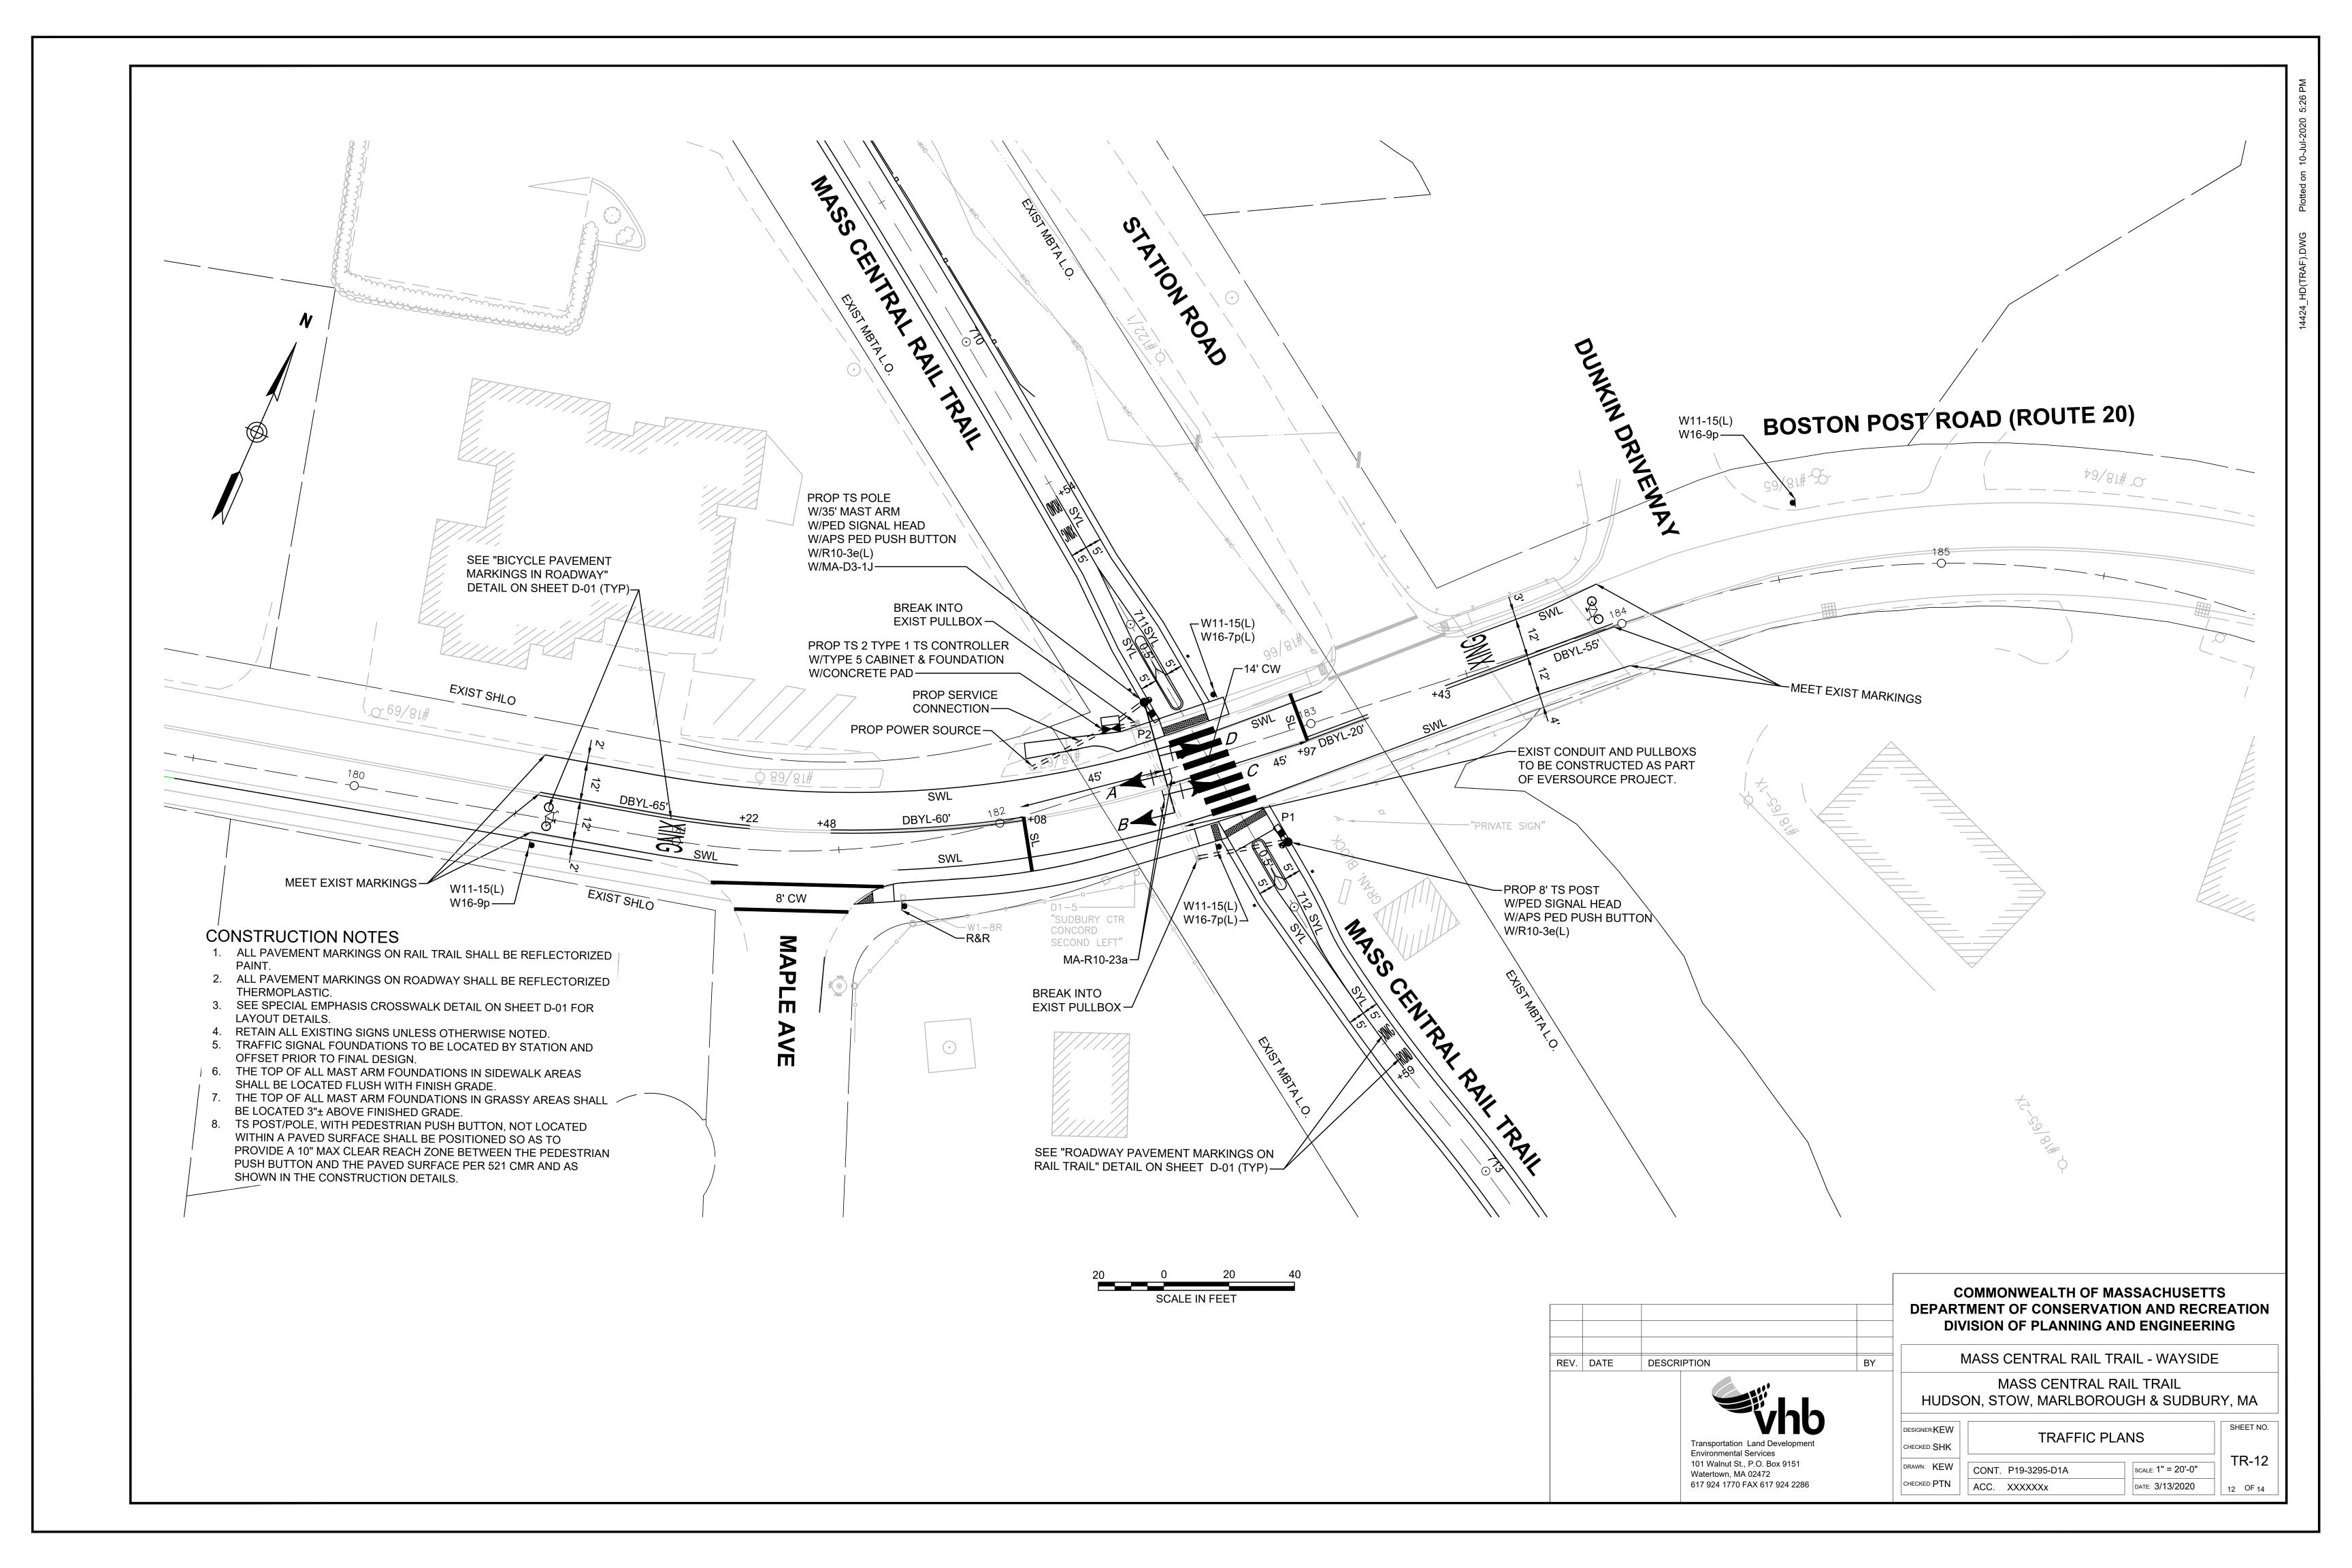

### SEQUENCE AND TIMING FOR PRE-TIMED CONTROL (ISOLATED)

						•		,
APPROACH	DIRECTION	HOUSING	1	2	3	4	5	FLASH
RTE 20 (BOSTON POST RD)	EB	A,B	DARK	FY	Y	R	FR	FY
RTE 20 (BOSTON POST RD)	WB	C,D	DARK	FY	Y	R	FR	FY
DEDECTRIAN V INC	ND	D4 D0	DW	DW	DW	14/	FDW	OUT
PEDESTRIAN X-ING	NB	P1-P2	DW	DW	DW	W	FDW	OUT
			TIM	ING IN S	SECOND	S		
MINIMUM GREEN (INITIAL)			40	5				
PASSAGE TIME (VEHICLE)			_	_				
MAXIMUM 1			40	5				CONFLICT FLASH OPERATION ONLY
MAXIMUM 2			40	5				J. 0
STEADY YELLOW INTERVAL					4			CONFLICT
STEADY RED INTERVAL						7		NFL :RA
PEDESTRIAN WALK INTERVAL	_					7		CO
PEDESTRIAN CLEARANCE INT	ΓERVAL						15	
DETECTOR MEMORY			_		-	_		
RECALL			OFF		-	_		

- 1. AUTOMATIC FLASHING OPERATION PER 2009 M.U.T.C.D., AS AMENDED.
- 2. * UPON PEDESTRIAN PUSH BUTTON ACTUATION
- 3. FR = ALTERNATING FLASHING RED
  4. MAXIMUM 1 = NORMAL OPERATION
- 5. MAXIMUM 2 = NOT USED
- 6. STOP AND GO OPERATION FOR 24 HOURS PER DAY. FLASHING OPERATION FOR
- EMERGENCY ONLY.
- 7. DURING PEDESTRIAN INTERVAL, FDW THROUGH YELLOW OPERATION SHALL NOT BE IN


#### **SEQUENCE & TIMING NOTES:**

- 1. IF THE ASSIGNED RIGHT OF WAY FOR ANY TRAFFIC MOVEMENT IS TO REMAIN IN EFFECT DURING THE NEXT CALLED PHASE, THE SIGNAL INDICATIONS FOR THAT TRAFFIC MOVEMENT WILL NOT CHANGE DURING THE CLEARANCE INTERVAL.
- 2. THE RIGHT OF WAY MAY BE ASSIGNED TO ANY PHASE OR ANY COMBINATION OF NON-CONFLICTING PHASES.
- 3. IF CALLS EXIST ON ALL PHASES, THE ASSIGNMENT OF RIGHT OF WAY SHALL BE IN ACCORDANCE WITH THE PREFERENTIAL PHASE SEQUENCE.
- 4. IF THE ASSIGNED RIGHT-OF-WAY FOR ANY TRAFFIC MOVEMENT IS TO CHANGE DURING THE NEXT CALLED PHASE, THE SIGNAL INDICATION FOR THAT MOVEMENT WILL DISPLAY THE APPROPRIATE CLEARANCE INTERVALS.
- 5. THE HYBRID BEACON SHALL OPERATE THROUGH NORMAL SEQUENCE WHEN ACTIVATED BY INFRARED CAMERA. DURATION OF HYBRID BEACON OPERATION UPON RECEIPT OF VALID INFRARED CAMERA ACTUATION SHALL BE AS SHOWN IN THE SEQUENCE & TIMING CHART.

# SIGNAL HEAD DATA A,B,C,DP1-P2 W/COUNTDOWN TIMER ALL 12" LENS

- 1. ALL SIGNAL HEADS SHALL BE RIGID MOUNTED.
- 2. ALL SIGNAL HEADS SHALL BE EQUIPPED WITH 5"± NON-LOUVERED BACKPLATES. ALL
- BACKPLATES SHALL CONTAIN A 3" WIDE YELLOW REFLECTIVE BORDER. 3. ALL SIGNAL HEADS SHALL BE EQUIPPED WITH TUNNEL VISORS.
- 4. ALL SIGNAL DISPLAYS SHALL BE EQUIPPED WITH L.E.D. MODULES.

#### HAWK (PEDESTRIAN) PHASE SEQUENCE

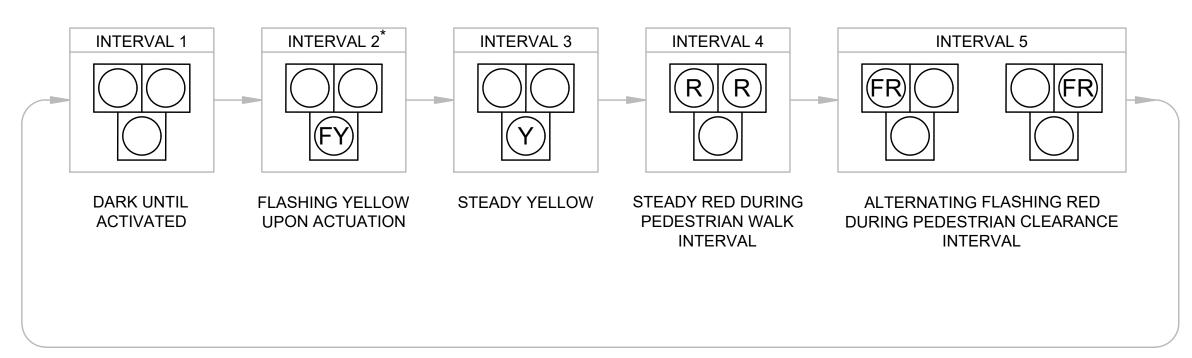

* UPON PEDESTRIAN PUSH BUTTON ACTUATION R = STEADY RED FR = FLASHING RED Y = STEADY YELLOW FY = FLASHING YELLOW

		R ITEMS REQUIRED
BOSTON P	OST ROAD (RO	OUTE 20) AT MASS CENTRAL RAIL TRAIL
PAY ITEM	QUANTITY	DESCRIPTION
	1	8Ø TS 2 TYPE 1 CONTROLLER IN A TYPE 5 BASE MOUNTED CABINET INCLUDING FOUNDATION AND CONCRETE PAD
	1	TS 35' MAST ARM TYPE 2, STEEL, INCL. FOUNDATION
824.02	1	TS POST 8' STANDARD INCL. FOUNDATION
824.02	4	SIGNAL HEAD, 3-SECTION, 12" LENSES (HAWK DISPLAY)
	2	PEDESTRIAN SIGNAL HEAD (L.E.D.)
	2	PEDESTRIAN PUSH BUTTON W/R10-3e(L) AND SIGN SADDLE
	1	SERVICE CONNECTION (OVERHEAD)
804.3	65'±	3 INCH ELECTRICAL CONDUIT TYPE NM - PLASTIC - (UL)

PLUS NECESSARY DUCT, CABLE, LABOR, MISCELLANEOUS MATERIAL AND EQUIPMENT TO COMPLETE THE INSTALLATION AND PROVIDE AN OPERATING PEDESTRIAN HYBRID BEACON.




Watertown, MA 02472

617 924 1770 FAX 617 924 2286

#### COMMONWEALTH OF MASSACHUSETTS DEPARTMENT OF CONSERVATION AND RECREATION **DIVISION OF PLANNING AND ENGINEERING**

l N	AASS CENTRAL RAIL TRAIL - WAYSIDE	
	MASS CENTRAL RAIL TRAIL	
HUDSC	ON, STOW, MARLBOROUGH & SUDBUF	RY, MA
DESIGNER:KEW	TRAFFIC PLANS	SHEET NO.
CHECKED: SHK	TIVALLIOTEANO	

SCALE: 1" = 20'-0" CONT. P19-3295-D1A CHECKED: PTN ACC. XXXXXXX DATE: 3/13/2020

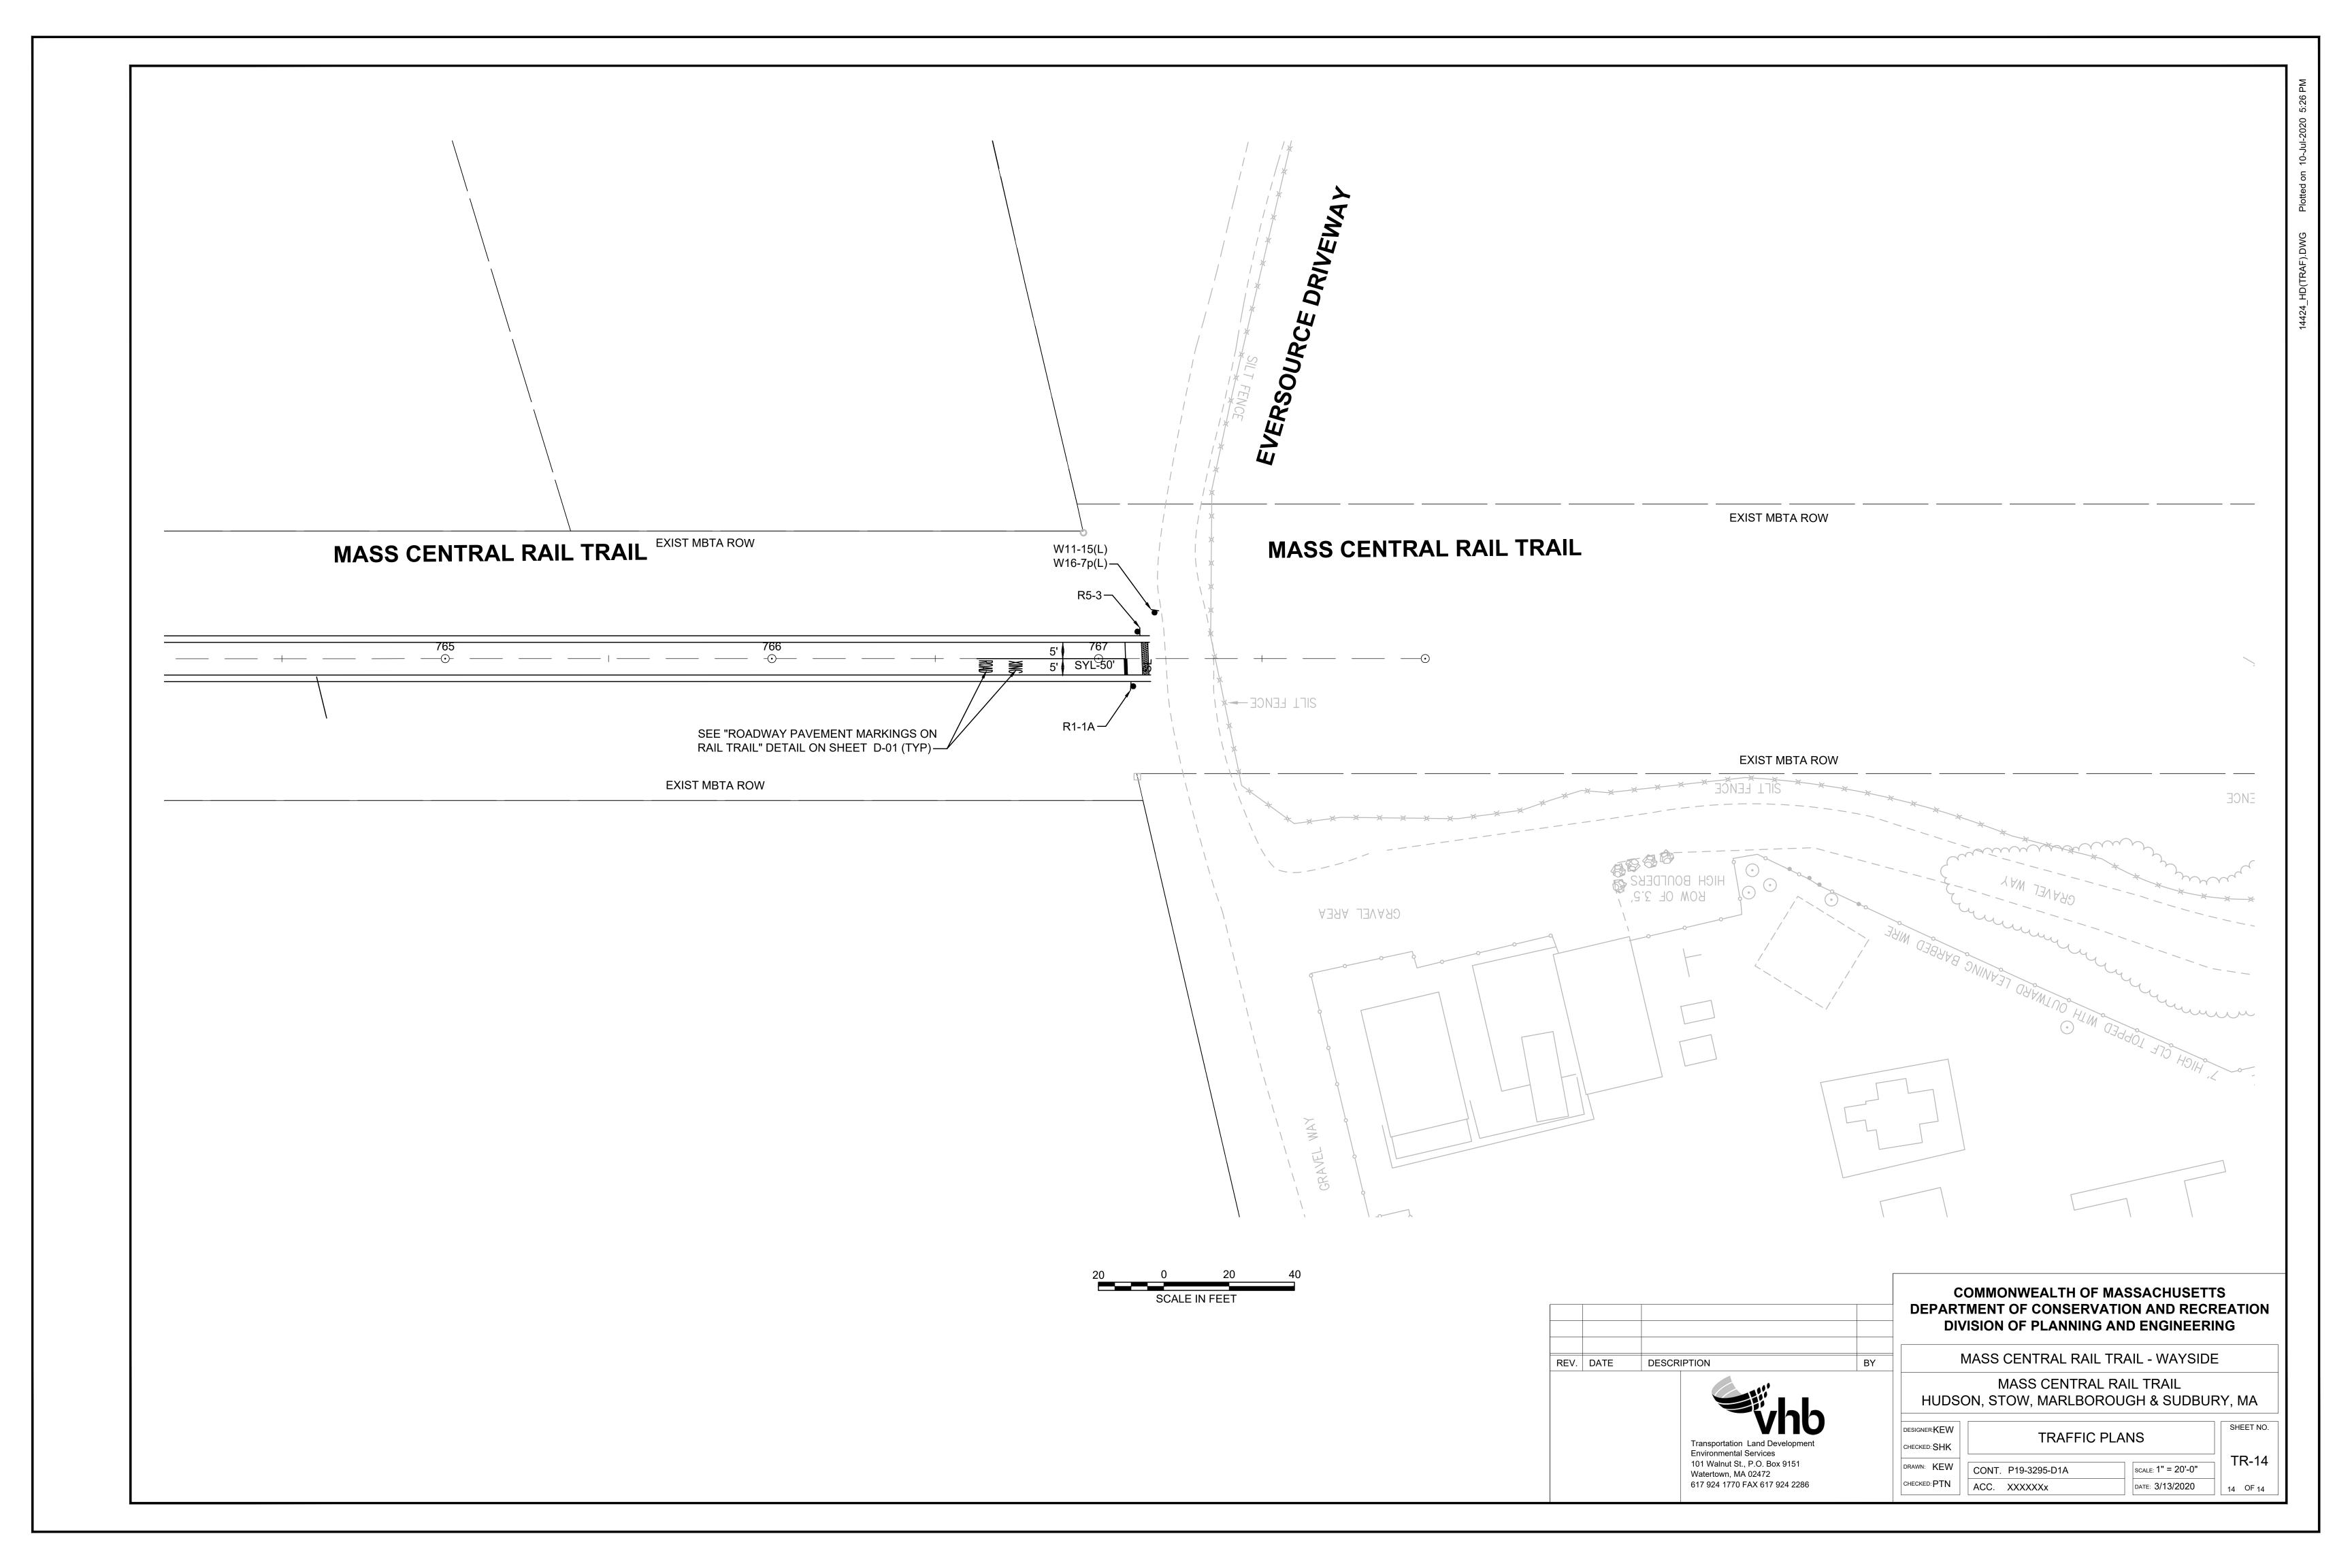

IDENTIFI—	SIZE C	F SIGN		TEXT DIM	IENSION	S (INCHES)	NUMBER OF		COLOR		POST SIZE AND	UNIT	AREA IN
CATION NUMBER	WIDTH	HEIGHT	TEXT	LETTER HEIGHT	VERTICA SPACIN		SIGNS REQUIRED	BACK- GROUND	LEGEND	BORDER	NUMBER REQUIRED	AREA (S.F.)	SQUARE FEET
R1-1A	18"	18"	STOP	HIGH	HWAY SI	ANDARD IGNS, AMENDED	15	RED	WHITE	WHITE	P5-15	1.86	27.90
R1-1	30"	30"	STOP				2	RED	WHITE	WHITE	P5-2	5.18	10.36
R5-3	24"	24"	NO MOTOR VEHICLES				23	WHITE	BLACK	BLACK	P5-23	4.00	92.00
R10-3e(L)	9"	15"	START CROSSING Worksh For Worksholes  DON'T START Finish Crossing  If. Startad  TIME REMAINING TO Finish Crossing  DON'T CROSS  PUSH BUTTON TO CROSS				4	WHITE	WHITE/ BLACK/ ORANGE	BLACK	4 MTD ON TS POST	UNI ITEMS	UDED DER 824.01 24.02
A-R10-23a	30"	36"	CROSSWALK STOP ON RED PROCEED ON FLASHING RED WHEN CLEAR		PER MAS		4	YELLOW/ WHITE	BLACK	BLACK	4 MTD ON MAST ARM	7.50	30.0
R10-25	12"	9"	PUSH BUTTON TO TURN ON WARNING LIGHTS	HIGH	HWAY SI	ANDARD IGNS, AMENDED	4	WHITE	BLACK	BLACK	4 MTD ON TS POLE	UNI ITEMS	UDED DER 824.111 4.112
W11-15(L)	30"	30"	To To				41	YELLOW	BLACK	BLACK	4 MTD ON TS POST P5-37	6.25	256.25
W11-15(R)	30"	30"	T T T T T T T T T T T T T T T T T T T				4	YELLOW	BLACK	BLACK	4 MTD ON TS POST	6.25	25.00
W16-7p(L)	24"	12"					21	YELLOW	BLACK	BLACK	4 MTD ON TS MOST 17 MTD WITH OTHERS	2.00	42.0
W16-7p(R)	24"	12"					4	YELLOW	BLACK	BLACK	4 MTD ON TS POST	2.00	8.00
W16-9p	24"	12"	AHEAD		V		18	YELLOW	BLACK	BLACK	18 MTD WITH OTHERS	2.00	36.00
SP-1	9"	12"	WAIT FOR VEHICLES TO STOP BEFORE CROSSING	1"C 1"C 1"C 1"C	1.5" 1" 1" 1" 1"	N/A	4	YELLOW	BLACK	BLACK	4 MTD ON TS POST	UNI ITEMS	UDED DER 824.111 4.112

IDENTIFI-	SIZE C	OF SIGN		TEXT DI	MENSIONS	(INCHES)	NUMBER		COLOR		POST SIZE	UNIT	AREA IN
CATION NUMBER	WIDTH	HEIGHT	TEXT	LETTER HEIGHT	VERTICAL SPACING	ARROW	OF SIGNS REQUIRED	BACK- GROUND	LEGEND	BORDER	AND NUMBER REQUIRED	AREA (S.F.)	SQUARE FEET
MA-D3-1A	VARIES	12"	Wilkins St  6" HUDSON TOWN SEAL	6"D/4.5"D	3" 3"	N/A	1	GREEN	WHITE	WHITE	1 MTD WITH OTHERS		D UNDER 1 874
MA-D3-1B	VARIES	12"	Main st  - 6" HUDSON TOWN SEAL	6"D/4.5"D	5" 5"	N/A	1	GREEN	WHITE	WHITE	1 MTD ON TS POLE		D UNDER 1874
MA-D3-1C	VARIES	12"	Parmenter Rd  - 6" HUDSON TOWN SEAL	6"D/4.5"D	3" 3"	N/A	1	GREEN	WHITE	WHITE	1 MTD WITH OTHERS		D UNDER 1874
MA-D3-1D	VARIES	12"	White Pond Rd  - 6" HUDSON TOWN SEAL	6"D/4.5"D	3" 3"	N/A	1	GREEN	WHITE	WHITE	1 MTD WITH OTHERS		D UNDER 1874
MA-D3-1E	VARIES	12"	Dutton Rd - 6" SUDBURY TOWN SEAL	6"D/4.5"D	3" 3"	N/A	1	GREEN	WHITE	WHITE	1 MTD WITH OTHERS		D UNDER 1874
MA-D3-1F	VARIES	12"	Peakham Rd  6" SUDBURY TOWN SEAL	6"D/4.5"D	3" 3"	N/A	1	GREEN	WHITE	WHITE	1 MTD WITH OTHERS		D UNDER 1874
MA-D3-1G	VARIES	12"	Horse Pond Rd  - 6" SUDBURY TOWN SEAL	6"D/4.5"D	3" 3"	N/A	1	GREEN	WHITE	WHITE	1 MTD WITH OTHERS		D UNDER 1874
MA-D3-1H	VARIES	12"	Union Ave  6" SUDBURY  TOWN SEAL	6"D/4.5"D	3" 3"	N/A	1	GREEN	WHITE	WHITE	1 MTD WITH OTHERS		D UNDER 1874
MA-D3-1J	VARIES	12"	Boston Post Rd	6"D/4.5"D	5"	N/A	1	GREEN	WHITE	WHITE	1 MTD ON	INCLUDE	D UNDER

NOTES:

1. HIGH INTENSITY REFLECTIVE SHEETING SHALL BE USED FOR ALL SIGNS. SEE FHWA "STANDARD HIGHWAY SIGNS, 2004 EDITION" FOR TEXT DIMENSIONS, AS AMENDED; THE 1977 MASSHIGHWAY DEPARTMENT CONSTRUCTION AND TRAFFIC STANDARD DETAILS, AS AMENDED, FOR SIGNS AND SUPPORTS; AND THE MASSHIGHWAY DEPARTMENT SIGN LISTINGS 1993 EDITION, AS AMENDED.

TOWN SEAL

REV. DATE DESCRIPTION

BY

Transportation Land Development
Environmental Services
101 Walnut St., P.O. Box 9151

Watertown, MA 02472 617 924 1770 FAX 617 924 2286

### COMMONWEALTH OF MASSACHUSETTS DEPARTMENT OF CONSERVATION AND RECREATION DIVISION OF PLANNING AND ENGINEERING


ITEM 874


MASS CENTRAL RAIL TRAIL - WAYSIDE


MASS CENTRAL RAIL TRAIL
HUDSON, STOW, MARLBOROUGH & SUDBURY, MA

DESIGNER: ICR SHEET NO

DESIGNER:JCR	TRAFFIC SIGN S	SLIMMARV	SHEET NO.
CHECKED: SHK	TIVALLIC SIGNA	SOMMAN	
DRAWN: JCR	CONT. P19-3295-D1A	SCALE: NTS	SS-01
CHECKED: TAL	ACC. XXXXXXX	DATE: 3/13/202	20 1 OF 1

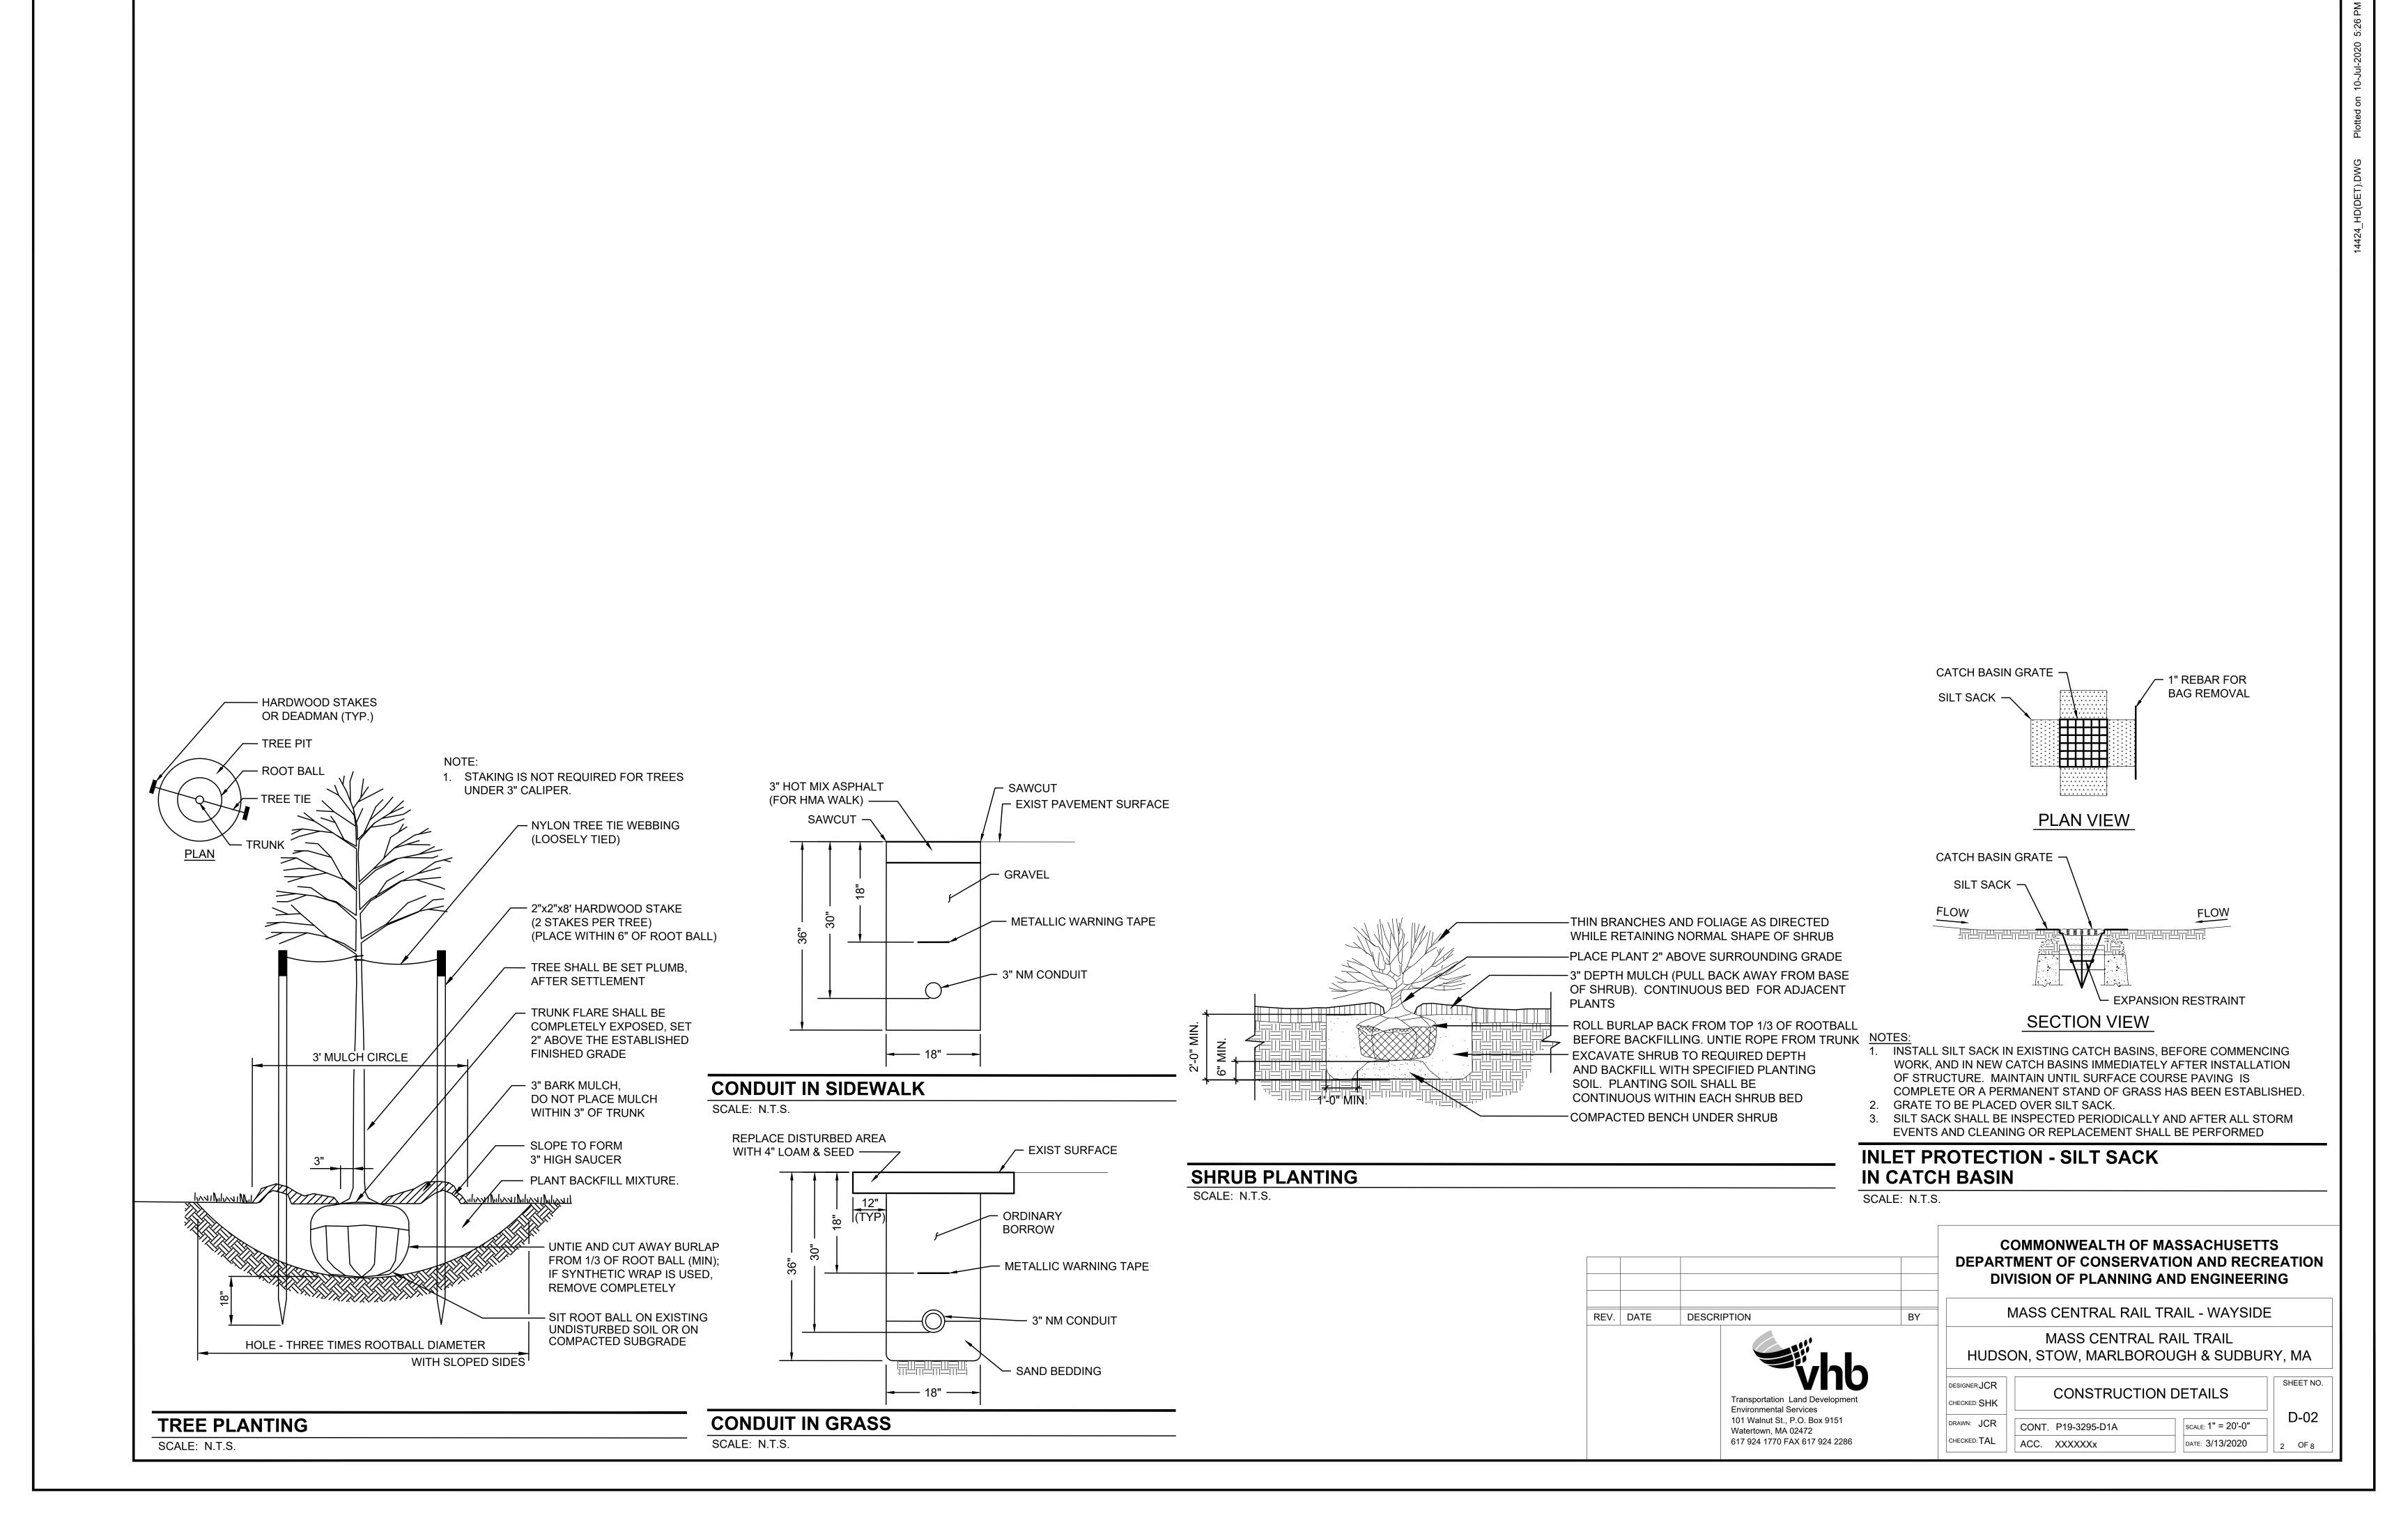


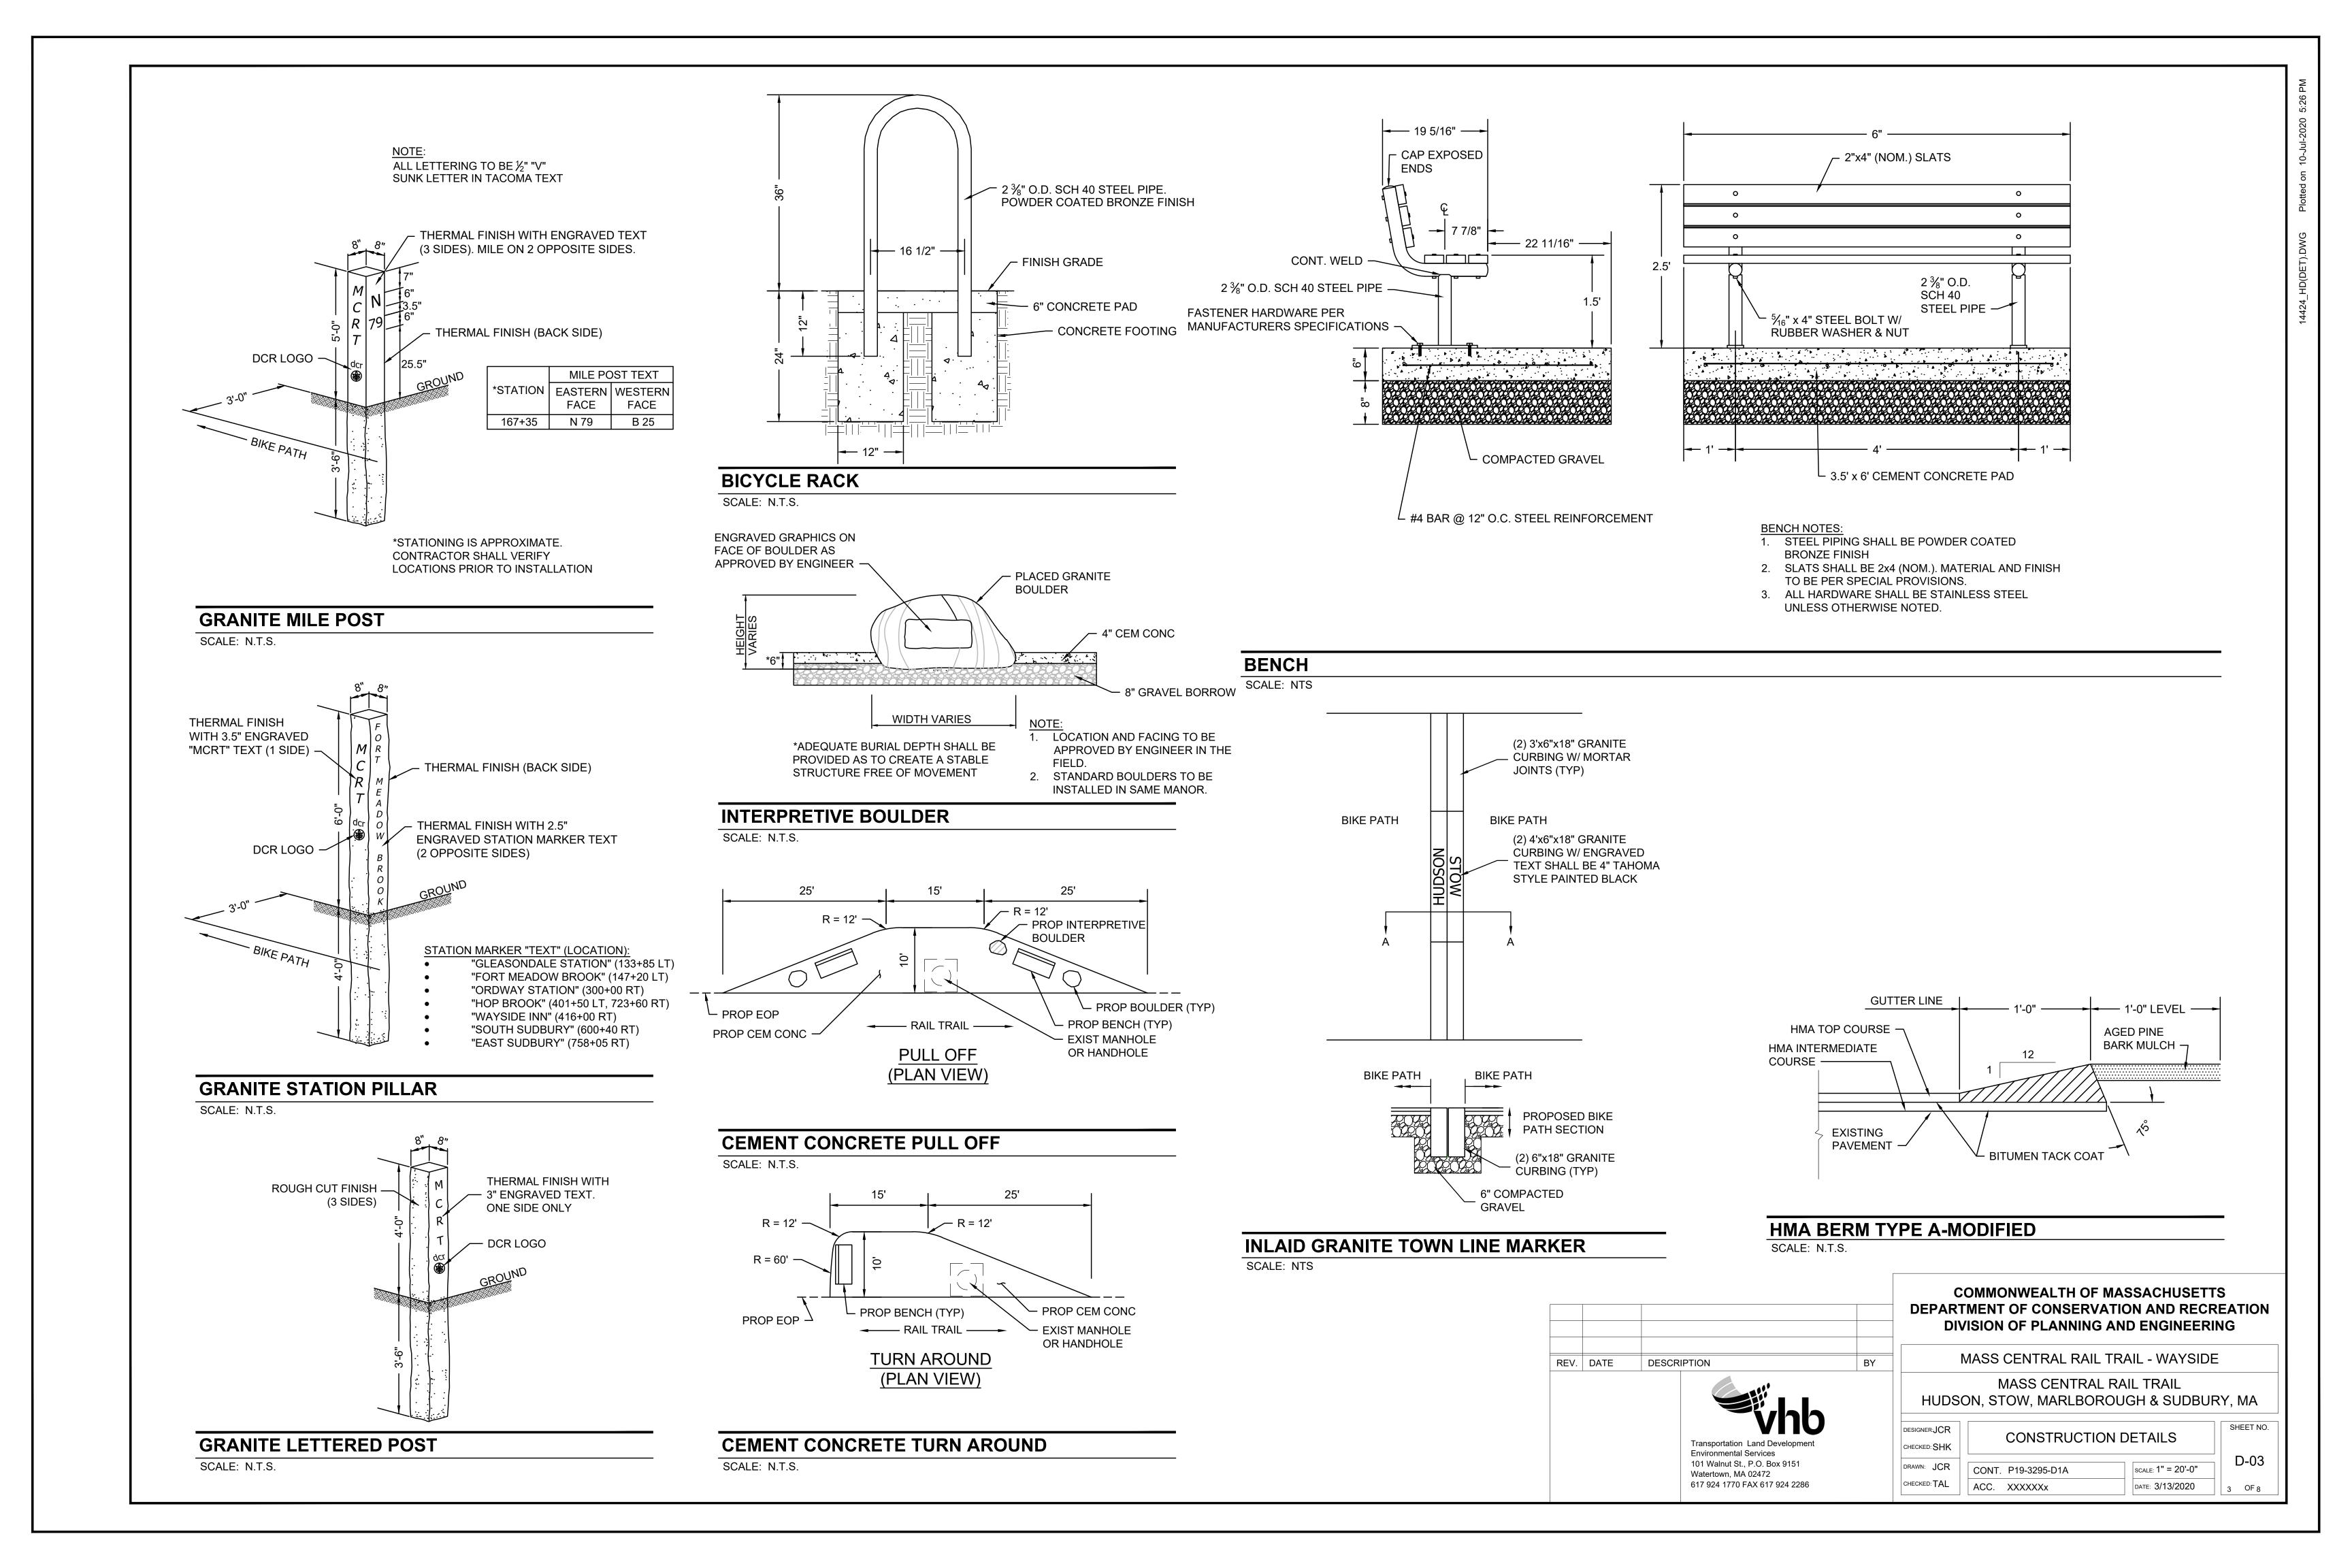

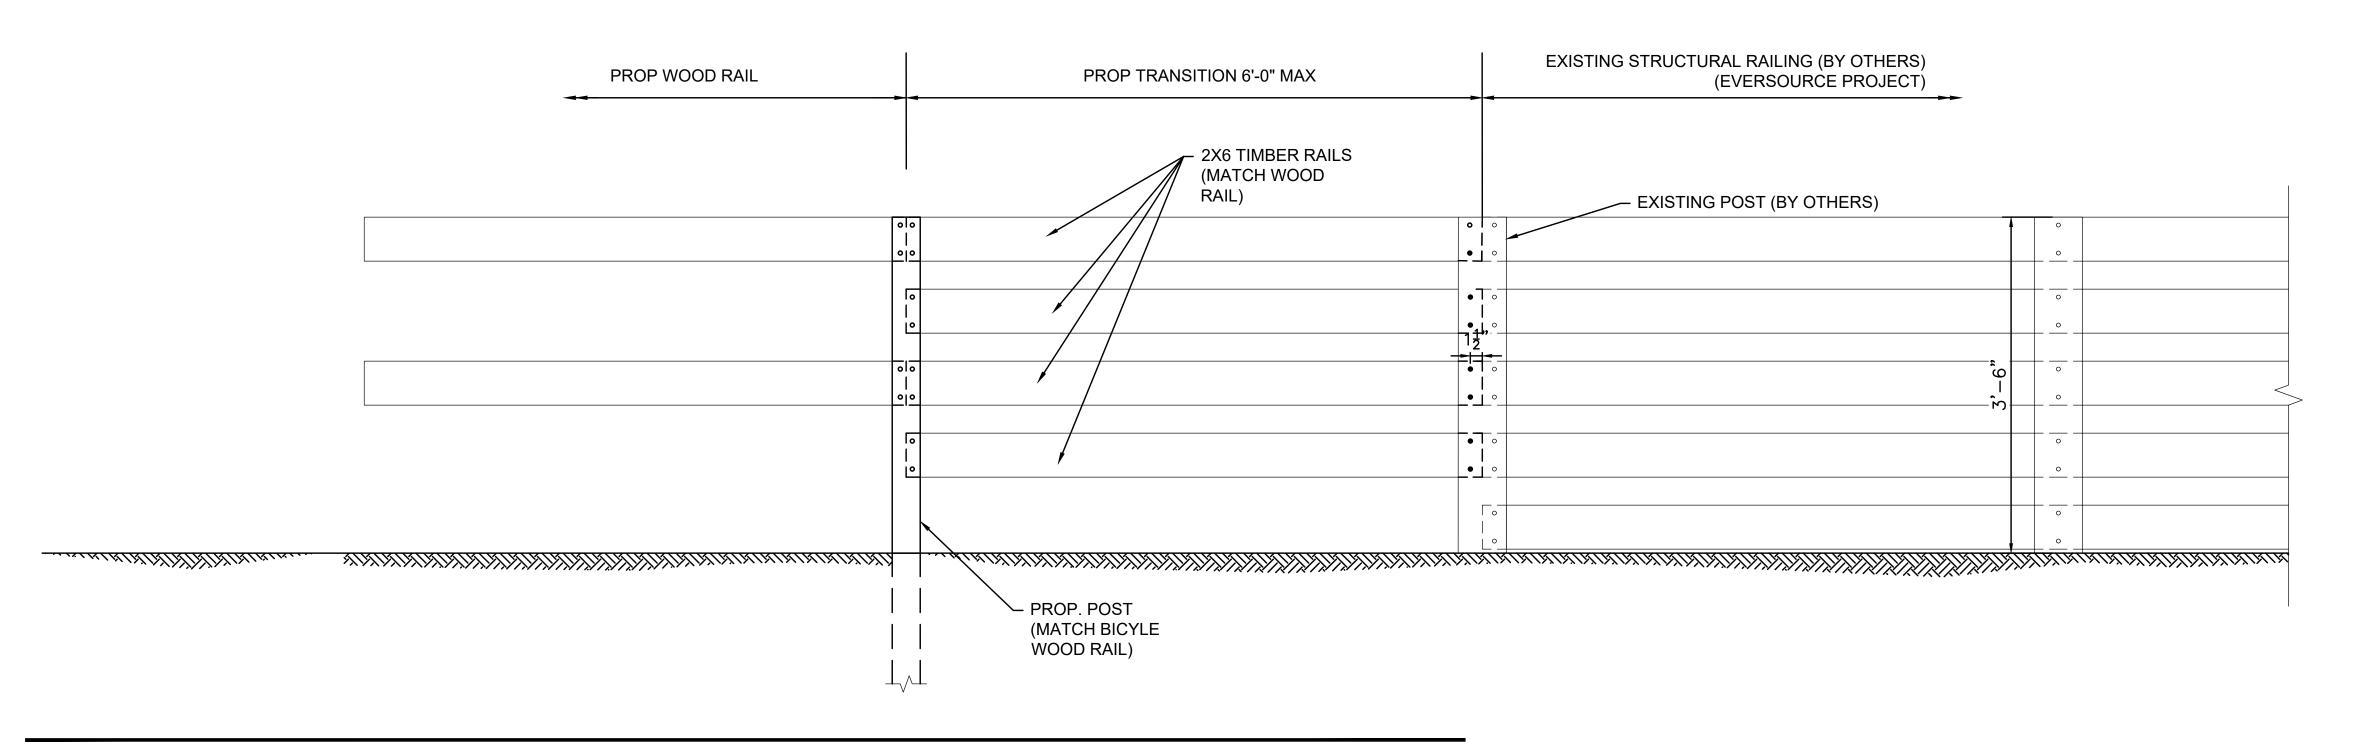

#### WOOD RAIL TRANSITION DETAIL AT EXISTING STRUCTURAL RAILING


SCALE: NTS

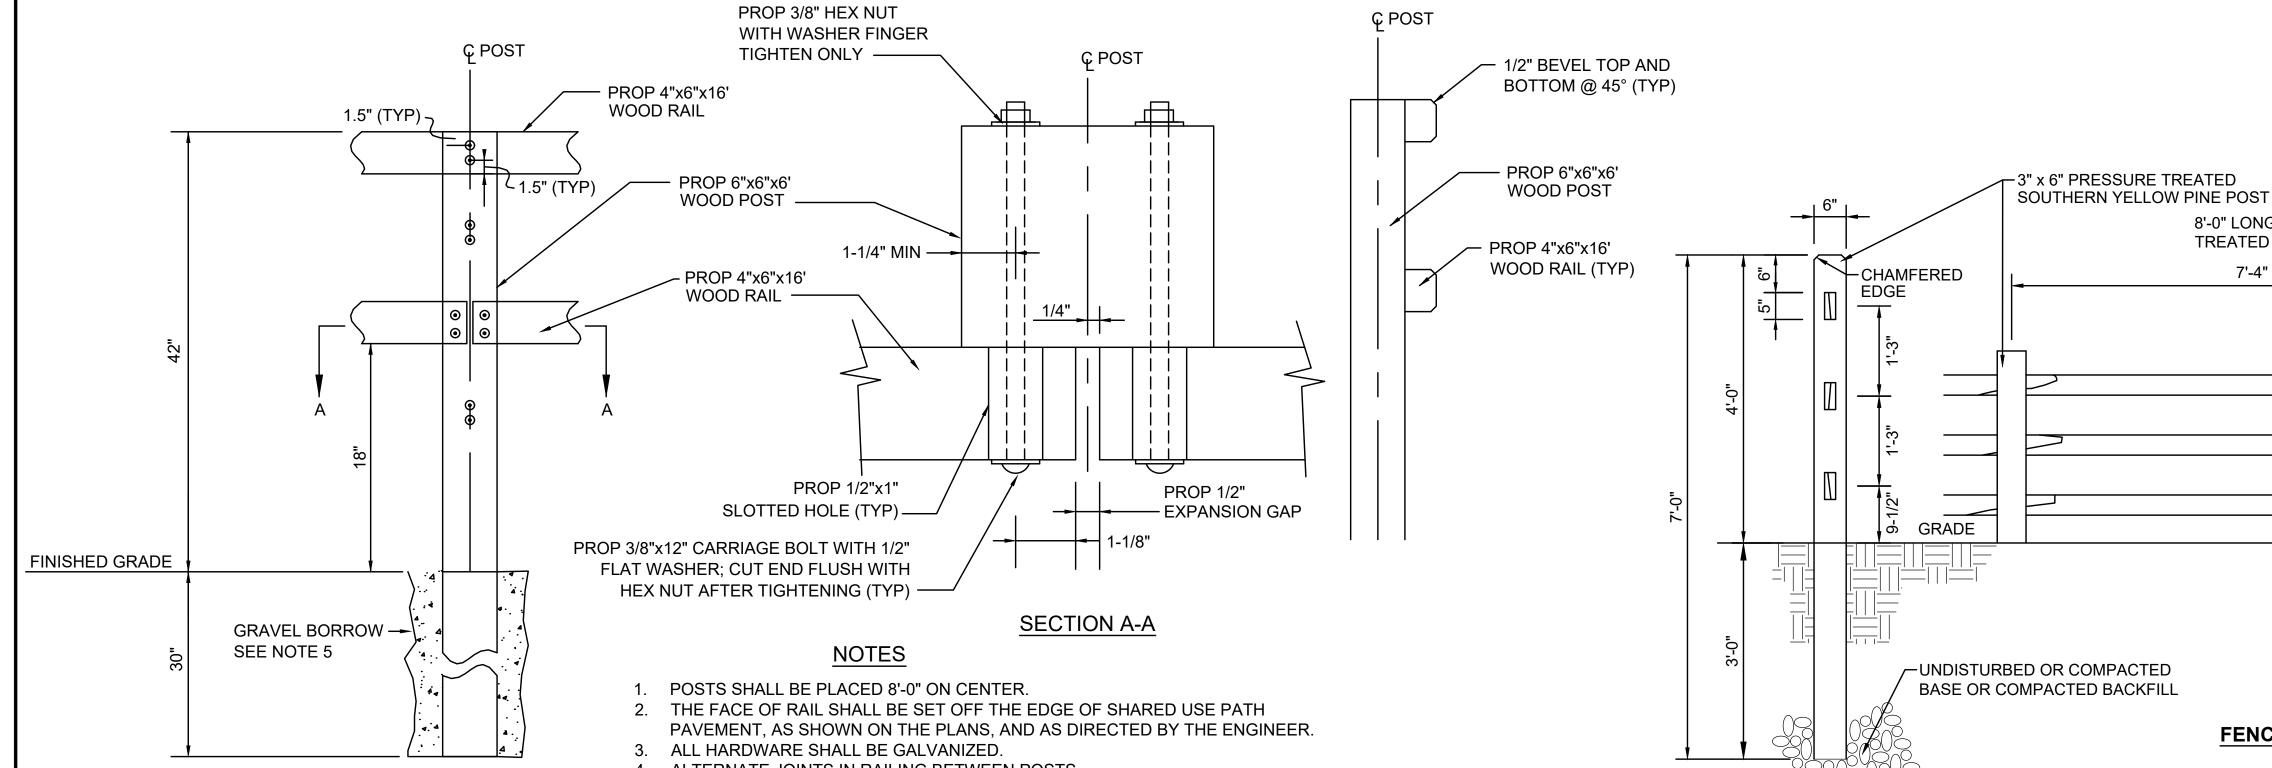

- 4. ALTERNATE JOINTS IN RAILING BETWEEN POSTS
- 5. CONTRACTOR SHALL SET POST IN 4,000 PSI, 1-1/2IN, 565 CEMENT CONCRETE
- FOR ALL POSTS UNABLE TO BE SET AT REQUIRED DEPTH.
  BOLTS SHALL BE SIZED AND INSTALLED SO THAT THEY EXTEND NO MORE
- THAN ONE ADDITIONAL NUT LENGTH BEYOND THE SECURED SURFACE.

#### **WOOD RAIL - ELEVATION AND SECTION VIEWS**

SCALE: NTS

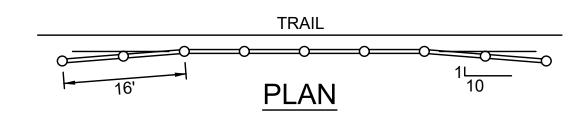

#### **WOOD RAIL TERMINAL END - PLAN VIEW**

SCALE: NTS



**FENCE POST** 

**SPLIT RAIL WOOD FENCE** 

SCALE: NTS

8'-0" LONG SPLIT RAIL, PRESSURE TREATED SOUTHERN YELLOW PINE—

## COMMONWEALTH OF MASSACHUSETTS DEPARTMENT OF CONSERVATION AND RECREATION DIVISION OF PLANNING AND ENGINEERING

FIRST AND LAST SECTION OF A LINE OF SPLIT RAIL FENCE SHALL BEGIN/END WITH

A 2' OFFSET TAPER, EXCEPT WHERE FENCE CONNECTS TO OTHER FENCING.


PATH ——

**PLAN** 

MASS CENTRAL RAIL TRAIL - WAYSIDE

MASS CENTRAL RAIL TRAIL
HUDSON, STOW, MARLBOROUGH & SUDBURY, MA

SIGNER:JCR	CONSTRUCTION [	DETAILS	SHEET NO.
RAWN: JCR			D-04
OAWIN. JCK	CONT. P19-3295-D1A	SCALE: 1" = 20'-0"	
HECKED: TAL	ACC. XXXXXXX	DATE: 3/13/2020	4 OF 8

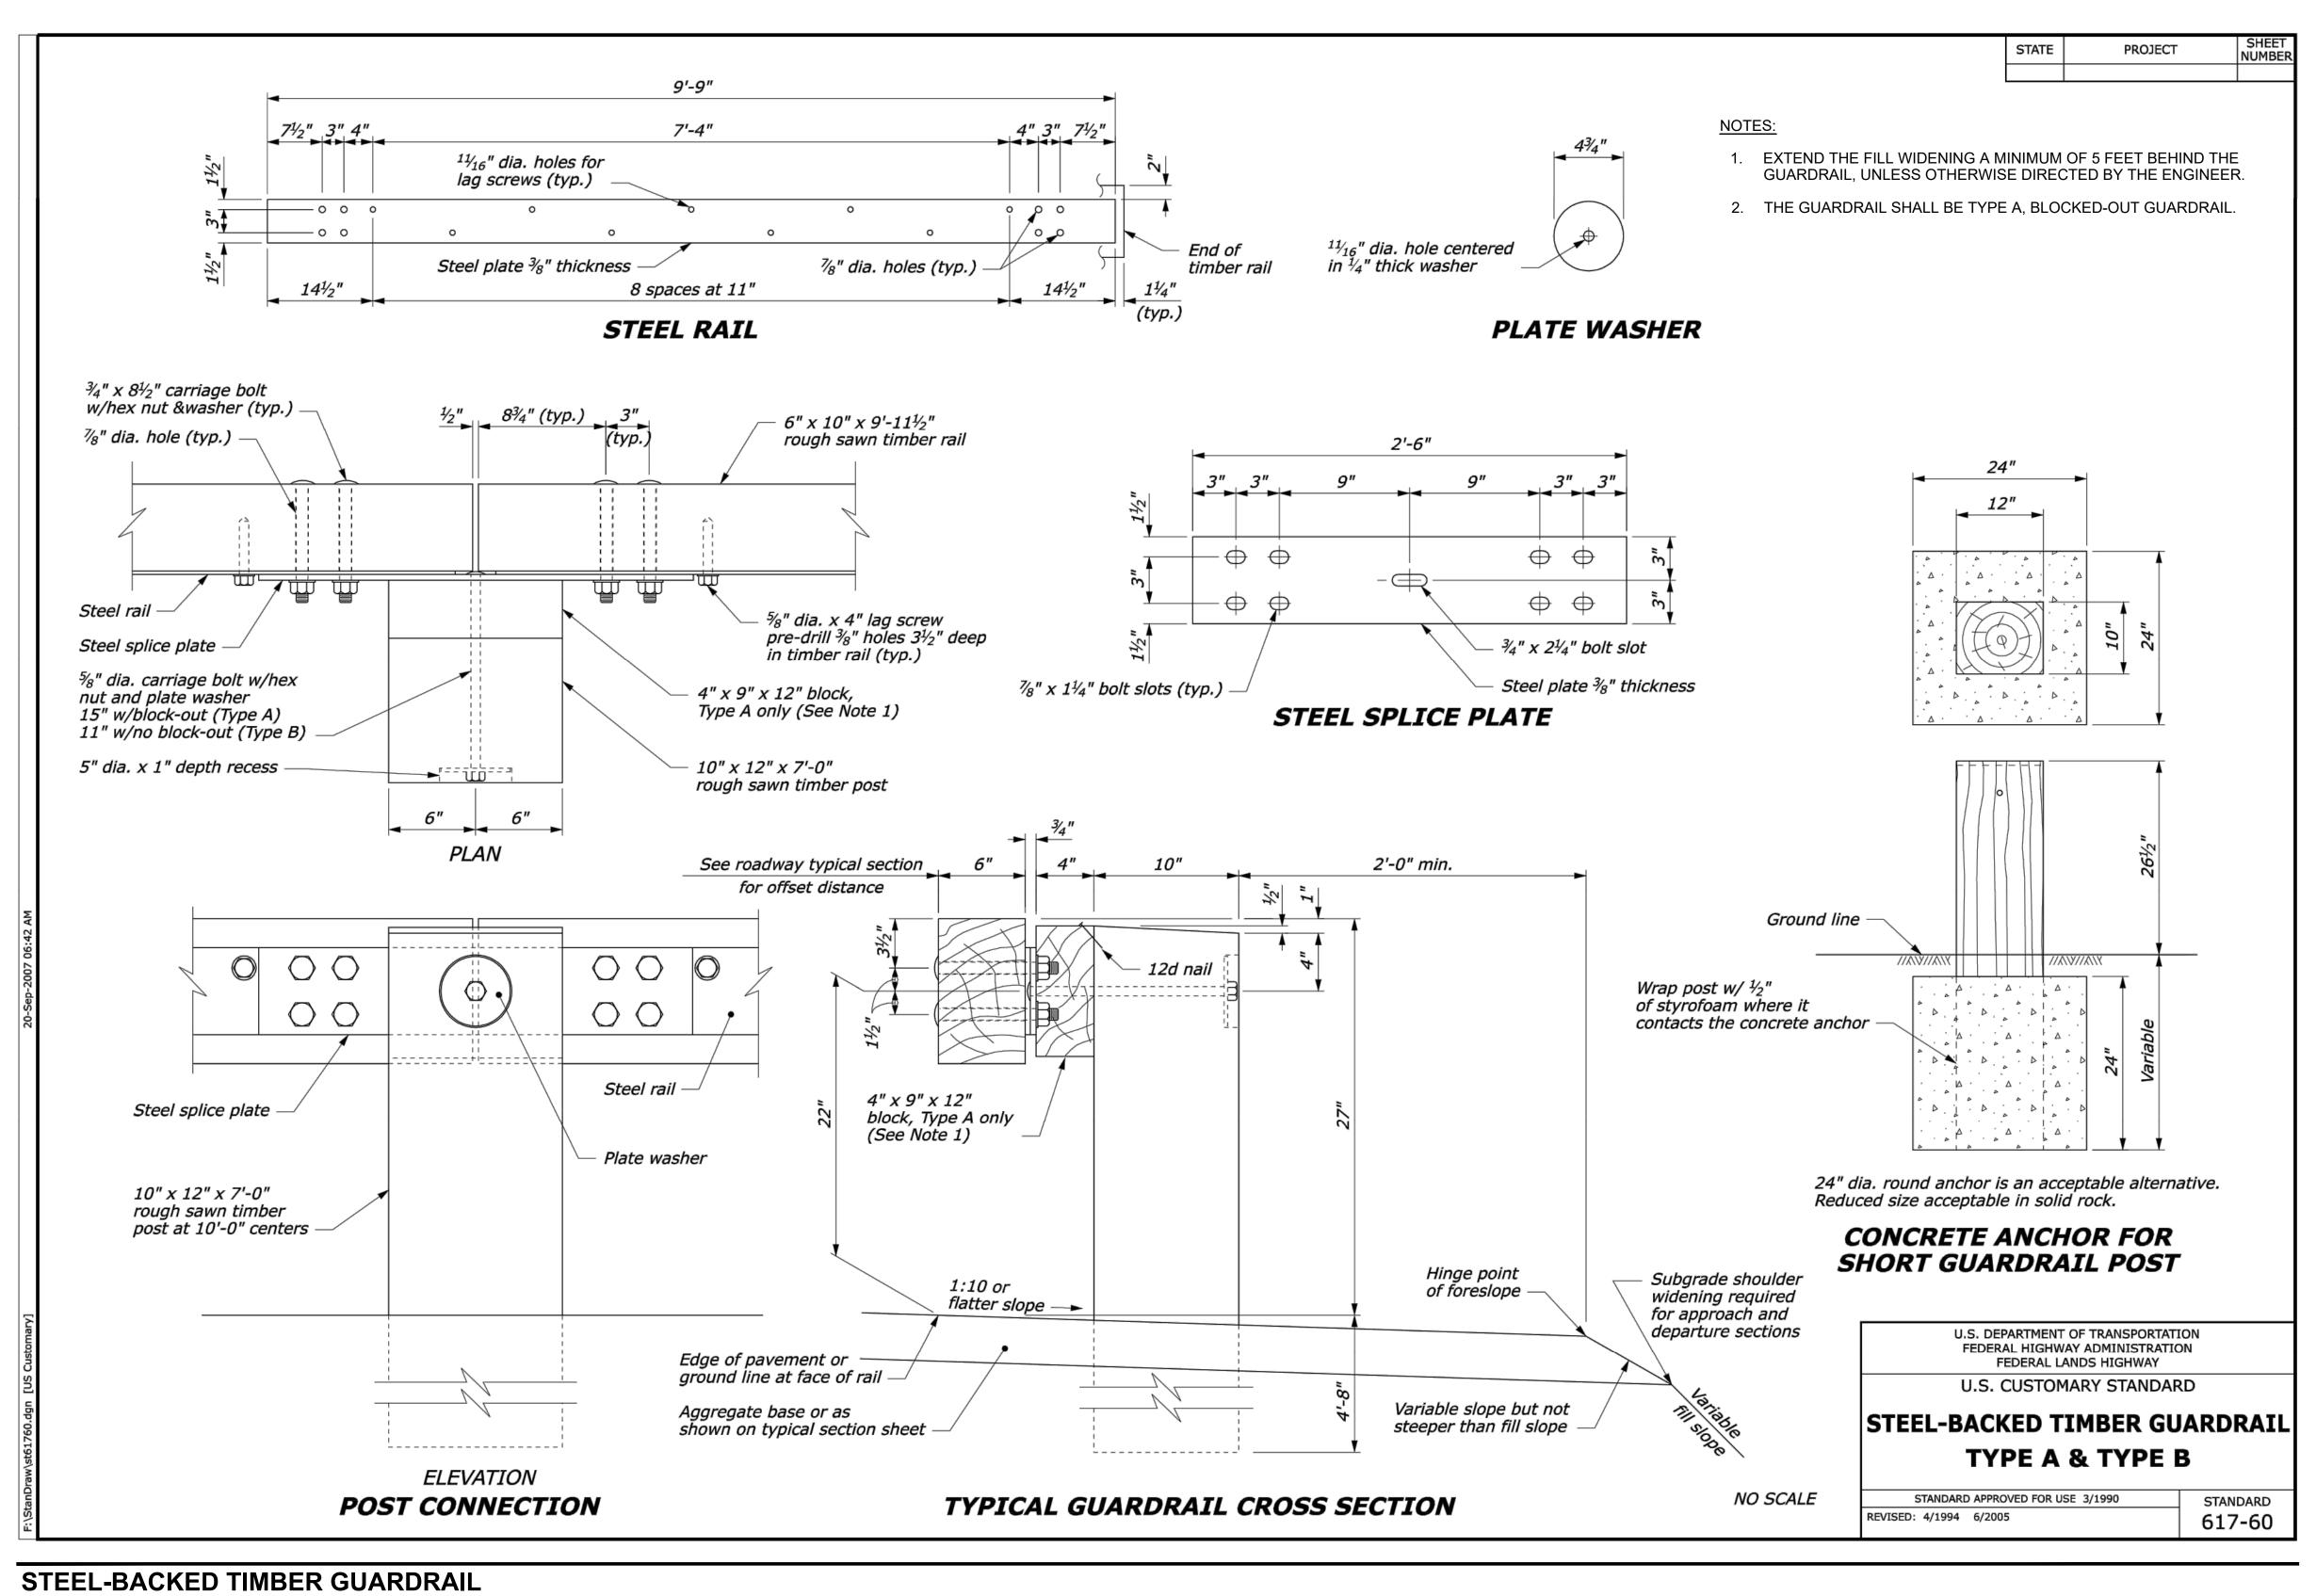

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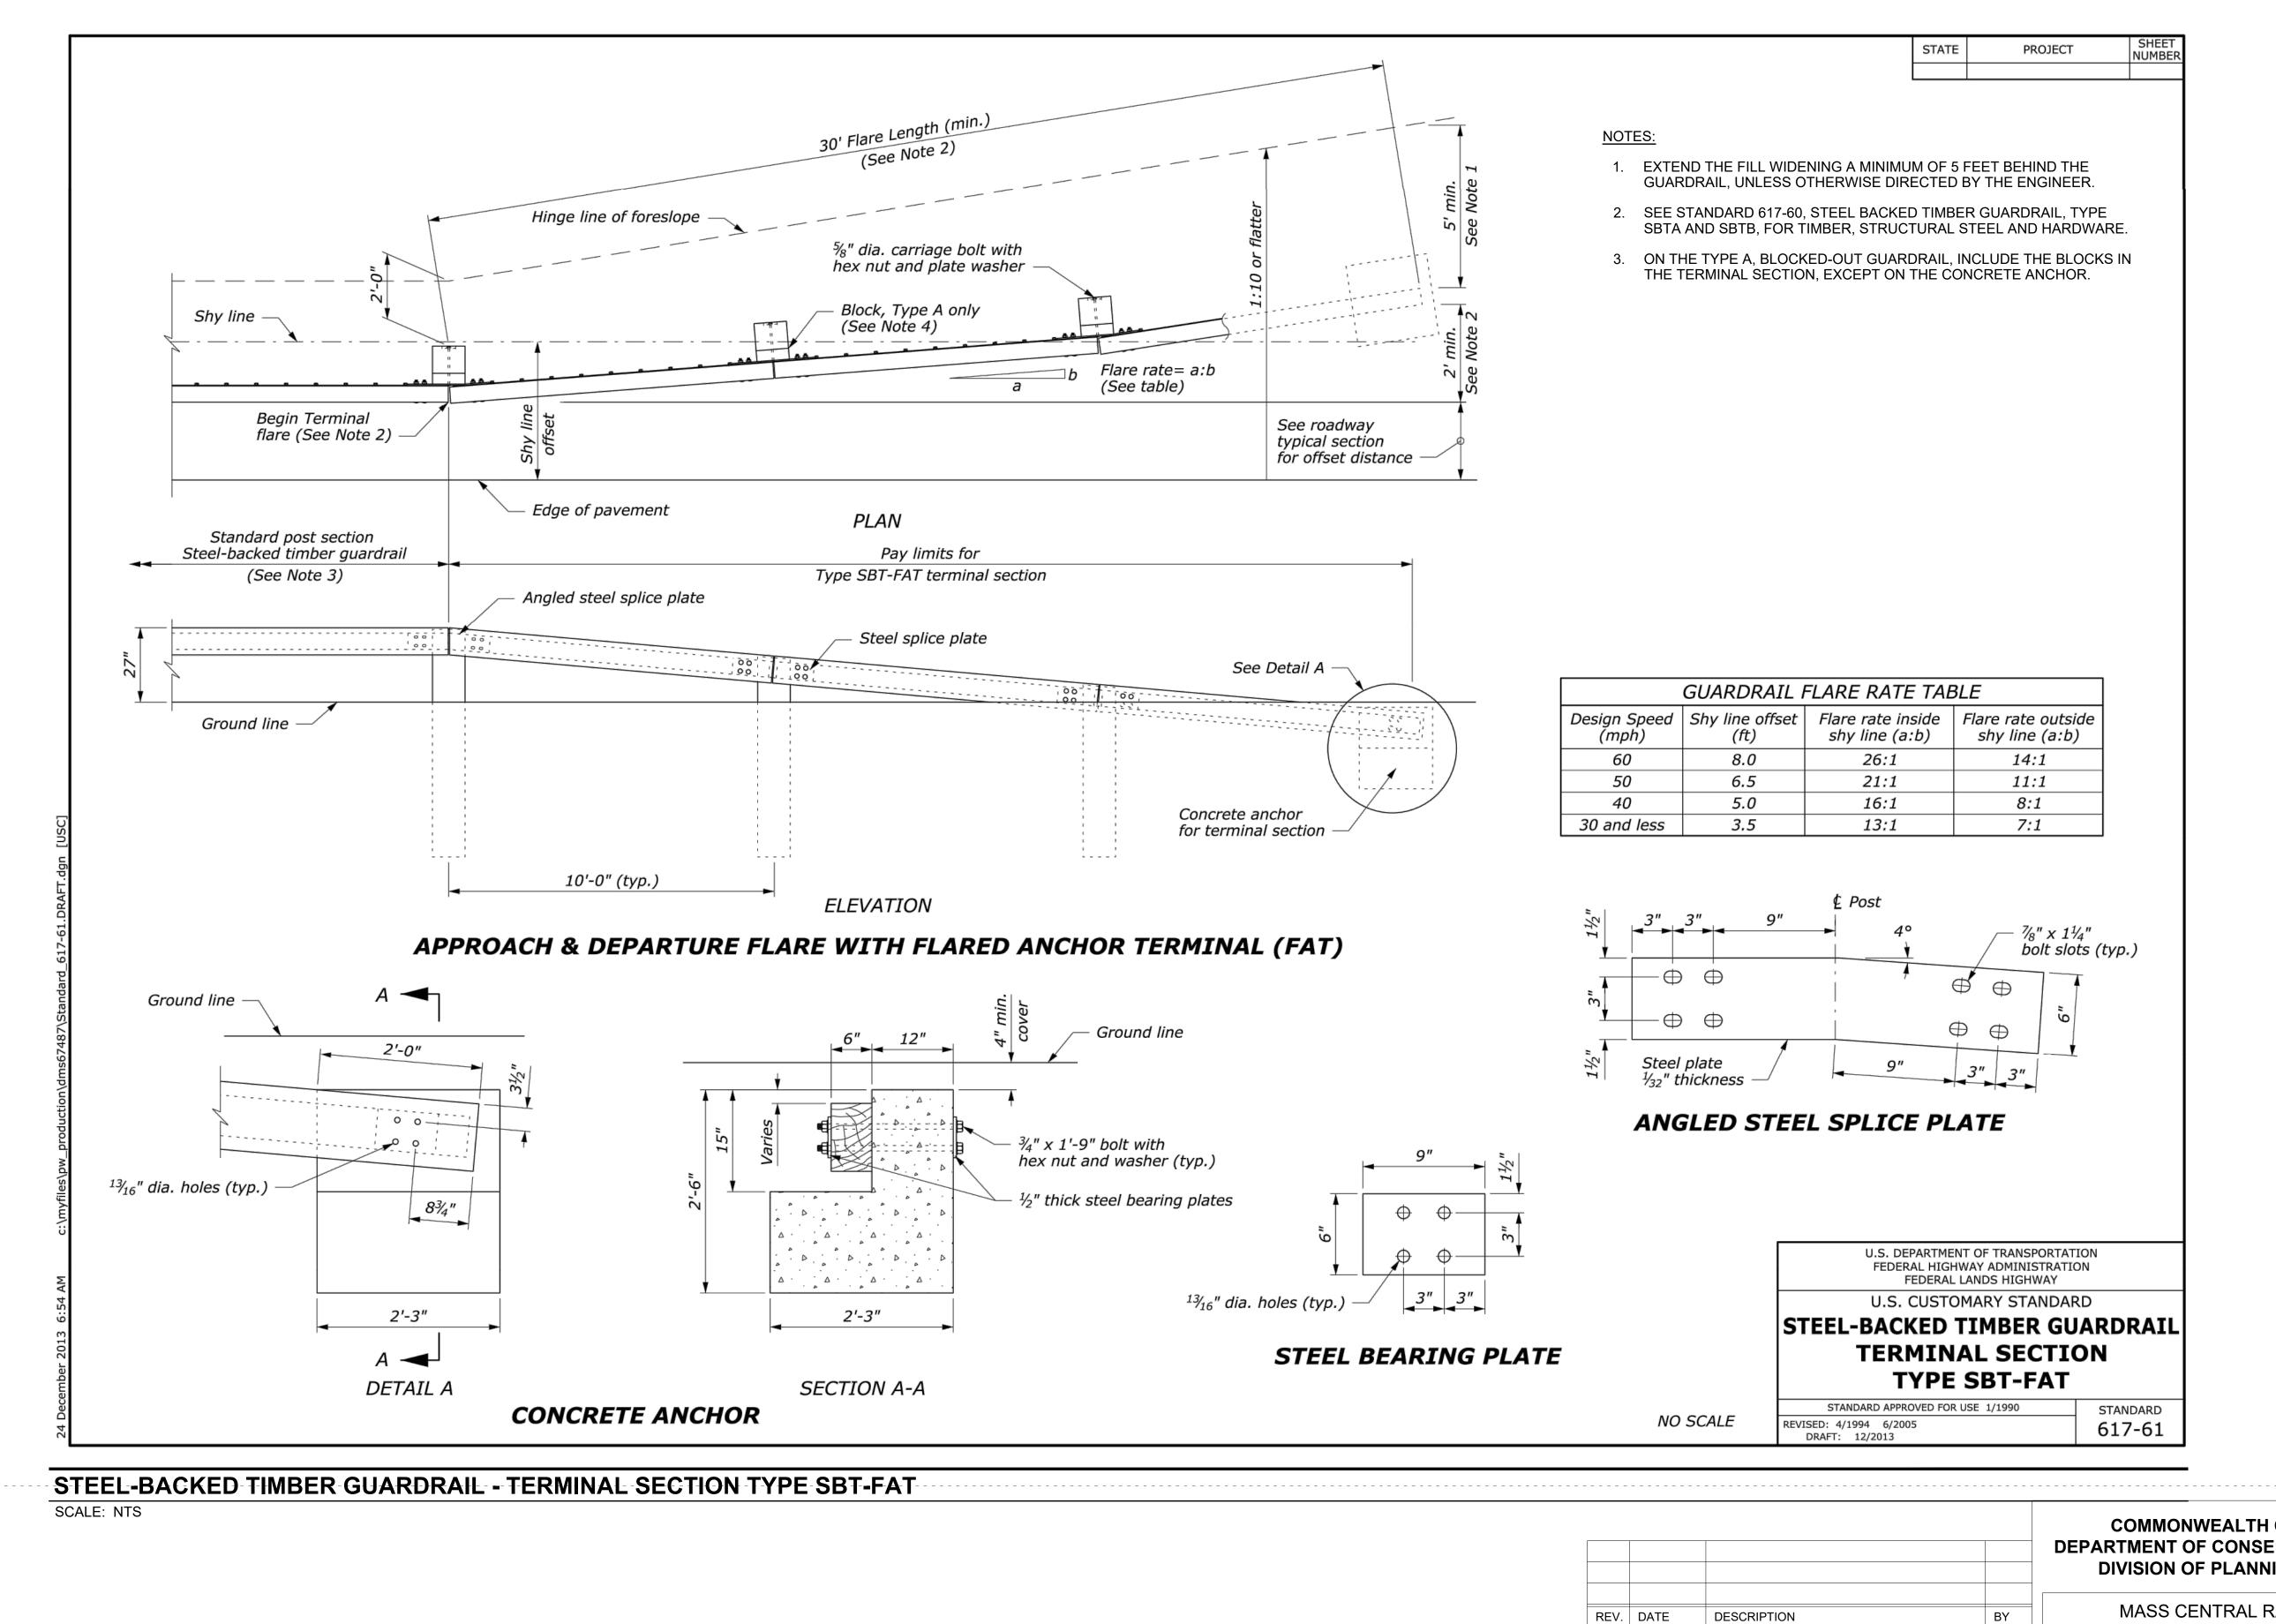


COMMONWEALTH OF MASSACHUSETTS
DEPARTMENT OF CONSERVATION AND RECREATION
DIVISION OF PLANNING AND ENGINEERING

MASS CENTRAL RAIL TRAIL - WAYSIDE

MASS CENTRAL RAIL TRAIL
HUDSON, STOW, MARLBOROUGH & SUDBURY, MA

DESIGNER:JCR	CONSTRUCTION	NI DETAILS	SHEET NO
CHECKED: SHK	CONSTRUCTION	DIN DETAILS	
			D-05
DRAWN: JCR	CONT. P19-3295-D1A	SCALE: 1" = 20'-0"	
CHECKED: <b>TAL</b>	ACC. XXXXXXX	DATE: 3/13/2020	5 OF 8



COMMONWEALTH OF MASSACHUSETTS
DEPARTMENT OF CONSERVATION AND RECREATION
DIVISION OF PLANNING AND ENGINEERING

MASS CENTRAL RAIL TRAIL - WAYSIDE

MASS CENTRAL RAIL TRAIL
HUDSON, STOW, MARLBOROUGH & SUDBURY, MA

DESIGNER: JCR
CHECKED: SHK

DRAWN: JCR
CHECKED: TAL

CONT. P19-3295-D1A
ACC. XXXXXXXX

DATE: 3/13/2020

SHEET NO.

SHEET NO.


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6 OF 8

Transportation Land Development


617 924 1770 FAX 617 924 2286

Environmental Services 101 Walnut St., P.O. Box 9151

Watertown, MA 02472

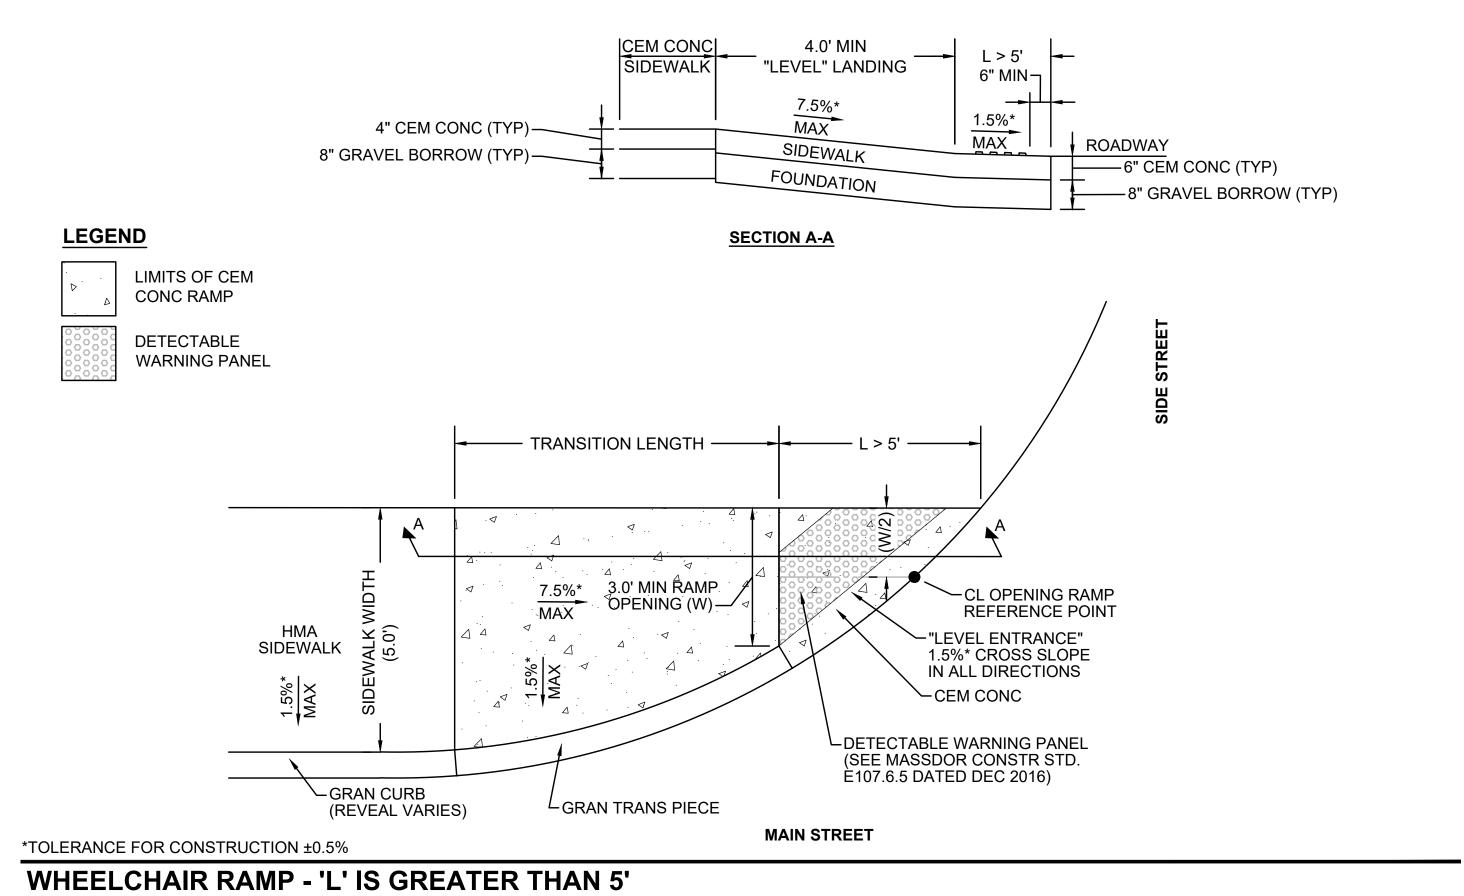

SCALE: NTS

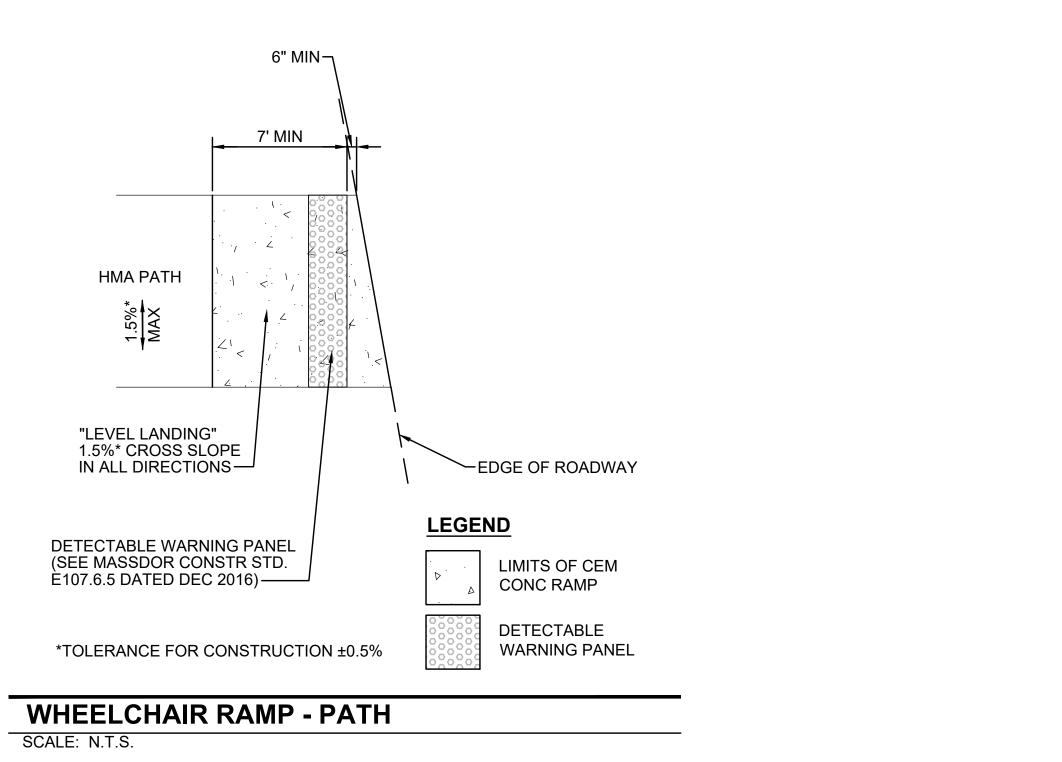



COMMONWEALTH OF MASSACHUSETTS
DEPARTMENT OF CONSERVATION AND RECREATION
DIVISION OF PLANNING AND ENGINEERING


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	HUDSO	MASS CENTRAL RAIL TRAIL ON, STOW, MARLBOROUGH & SUDBUR	RY, MA
	DESIGNER:JCR	CONSTRUCTION DETAILS	SHEET NO.

SCALE: 1" = 20'-0"

DATE: 3/13/2020


7 OF 8

CONT. P19-3295-D1A

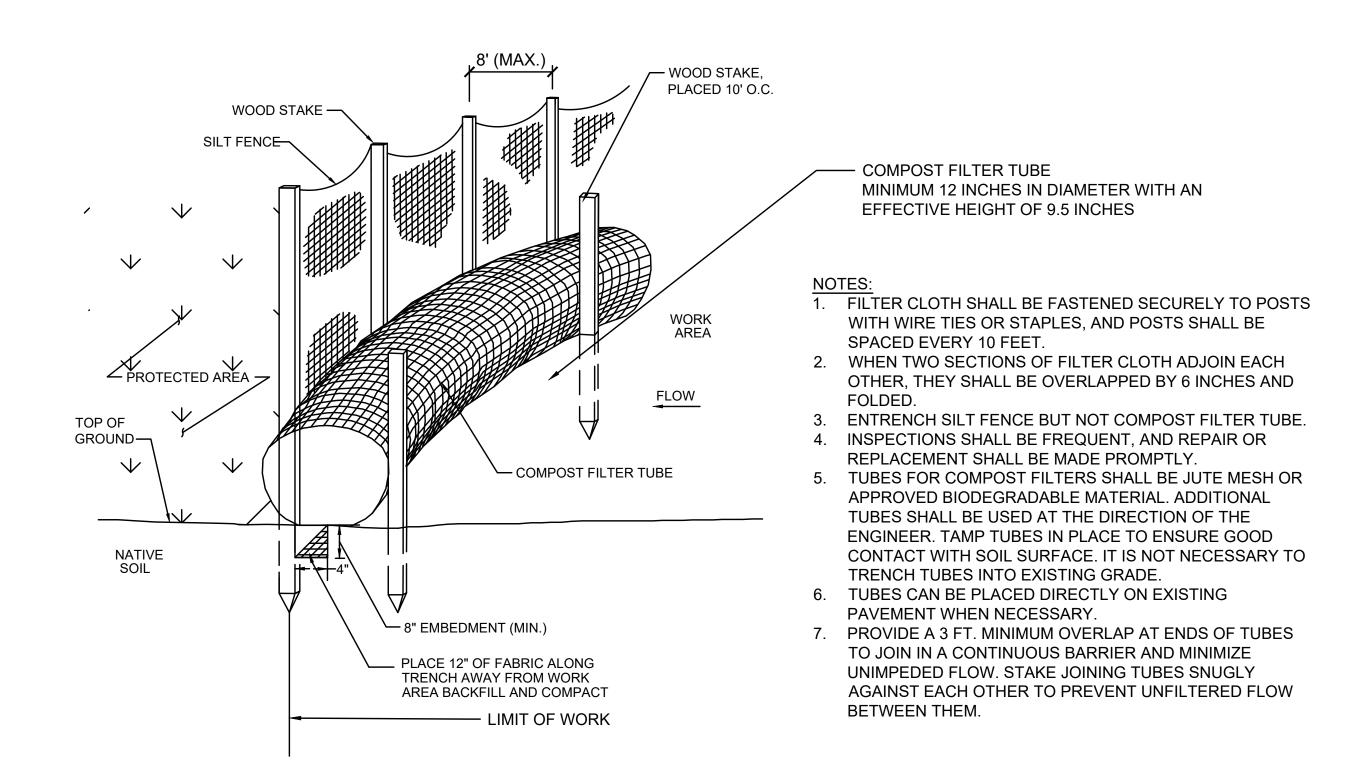

### COMPOST FILTER TUBE AND SILT FENCE DETAIL - TYPE A EROSION CONTROL BARRIER

SCALE: NTS

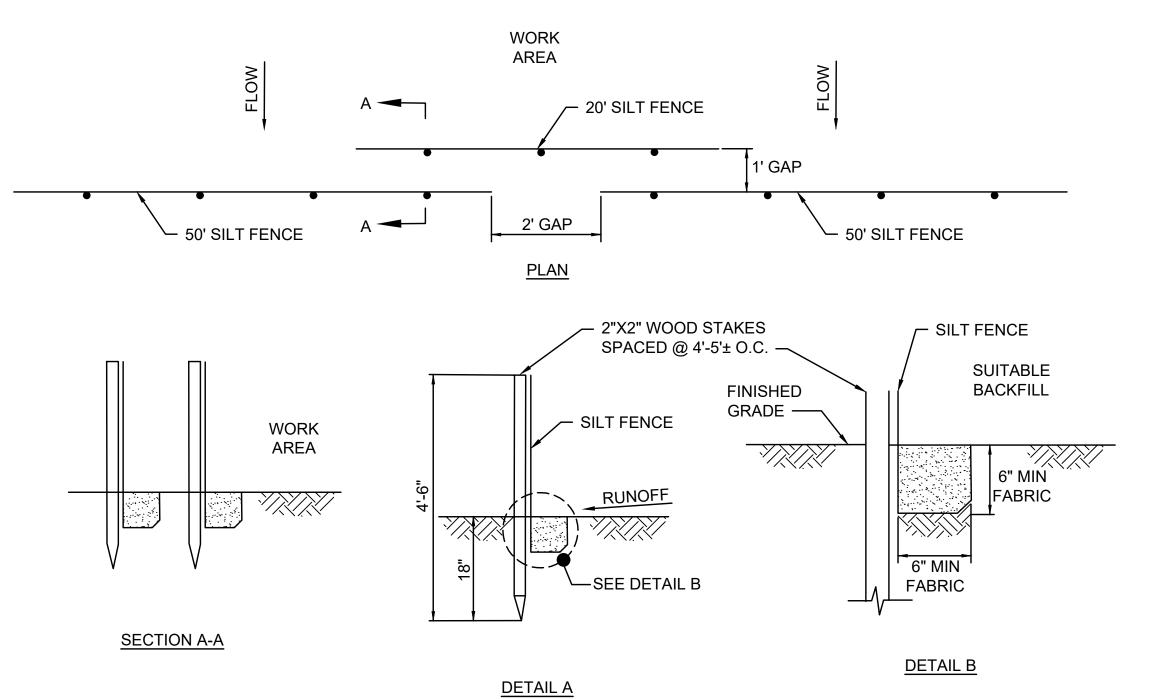


#### NOTES:

1. SYNCOPATED SILT FENCE SHALL BE USED WITHIN ALL PRIORITY HABITAT AREAS AND WITHIN 450' OF VERNAL POOLS.


2. INSTALL GAP AFTER EVERY 50' OF EROSION CONTROL BARRIER.

#### SYNCOPATED SILT FENCE DETAIL - TYPE B EROSION CONTROL BARRIER

SCALE: N.T.S.

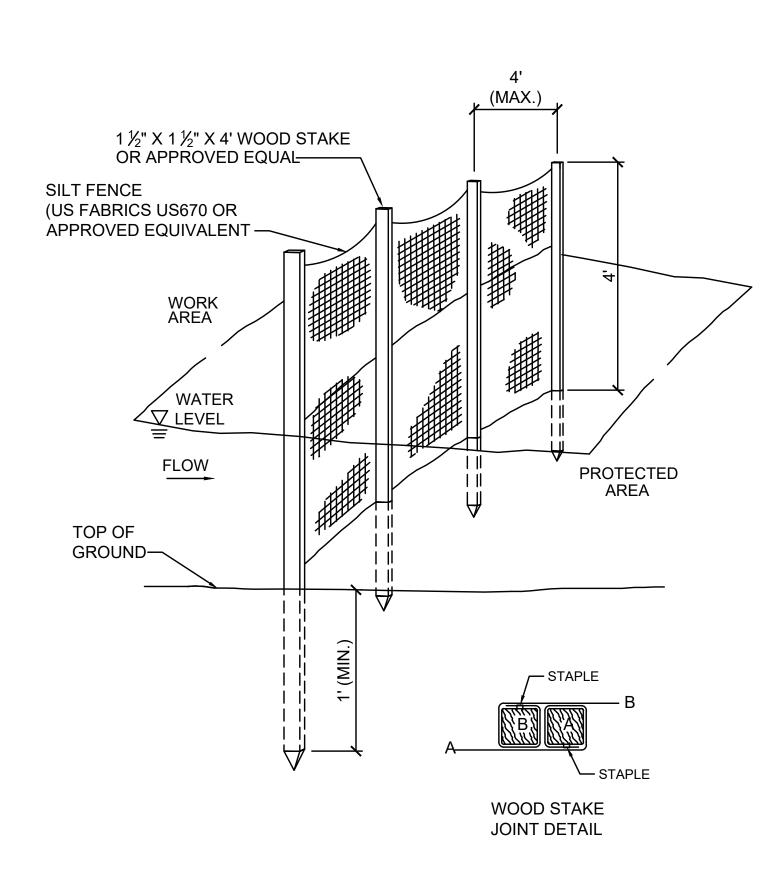

### 4' HIGH SILT FENCE BARRIER DETAIL - EROSION CONTROL BARRIER TYPE C (OPTION 1) SCALE: N.T.S.

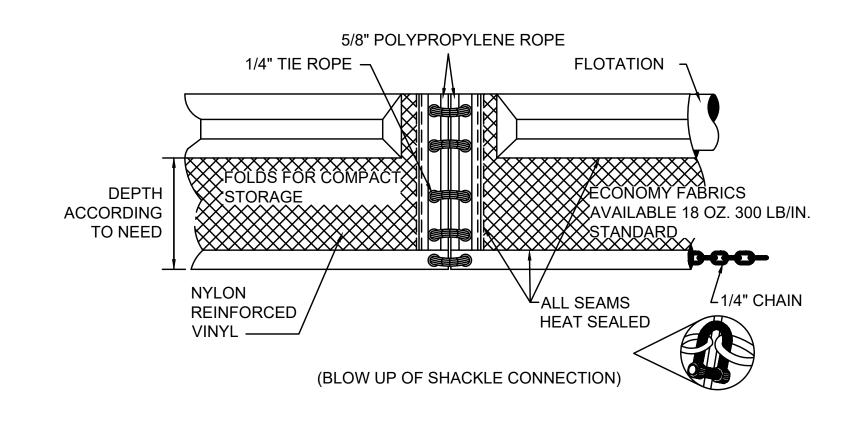


### TURBIDITY CURTAIN DETAIL - EROSION CONTROL BARRIER TYPE C (OPTION 2) SCALE: N.T.S.




### COMMONWEALTH OF MASSACHUSETTS DEPARTMENT OF CONSERVATION AND RECREATION DIVISION OF PLANNING AND ENGINEERING

Υ		MASS CENTRAL RAIL TRAIL - WAYSIDE	
	HUDS	MASS CENTRAL RAIL TRAIL ON, STOW, MARLBOROUGH & SUDBUF	RY, MA
	DESIGNER:JCR CHECKED:SHK	CONSTRUCTION DETAILS	SHEET NO.
	DRAWN: JCR CHECKED: TAL	CONT. P19-3295-D1A   SCALE: 1" = 20'-0"   DATE: 3/13/2020	D-08

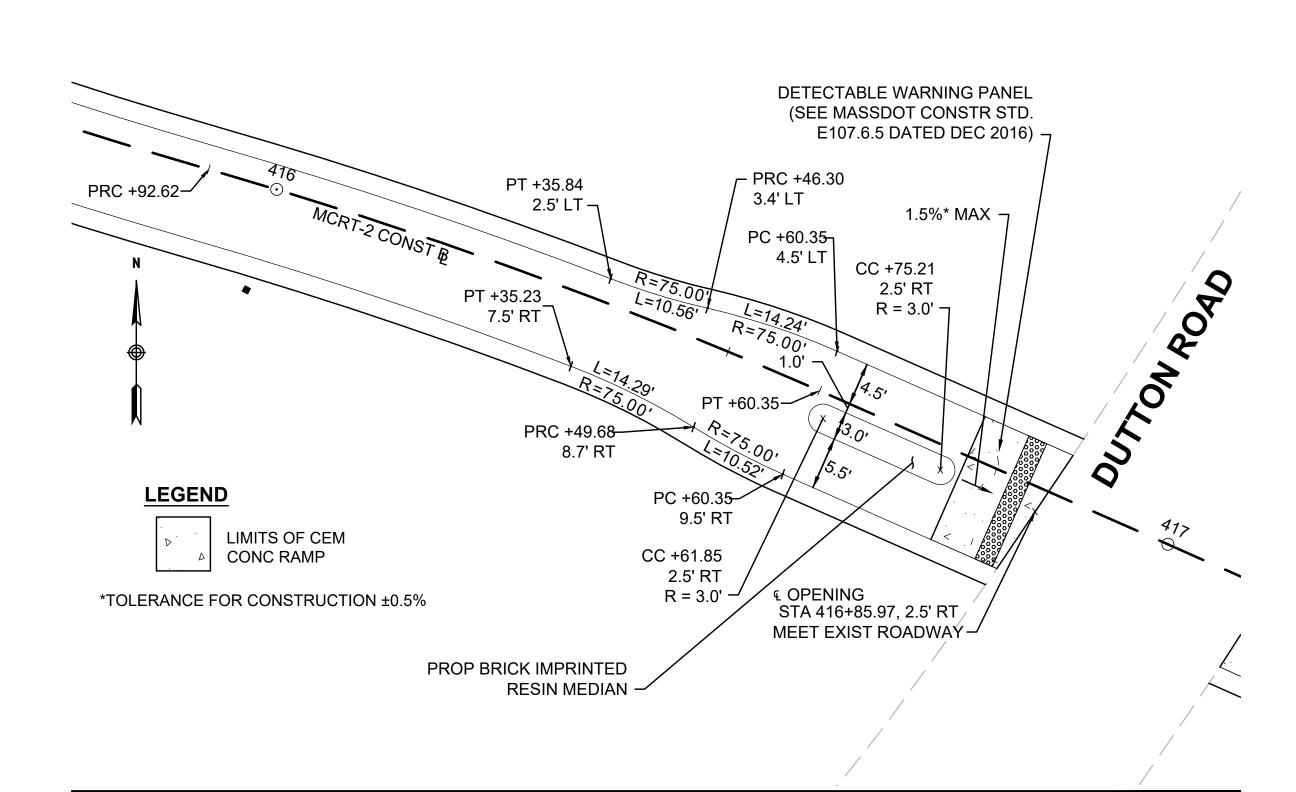


#### **GATEWAY 9 - DUTTON ROAD (WEST)**

SCALE: 1" = 10'

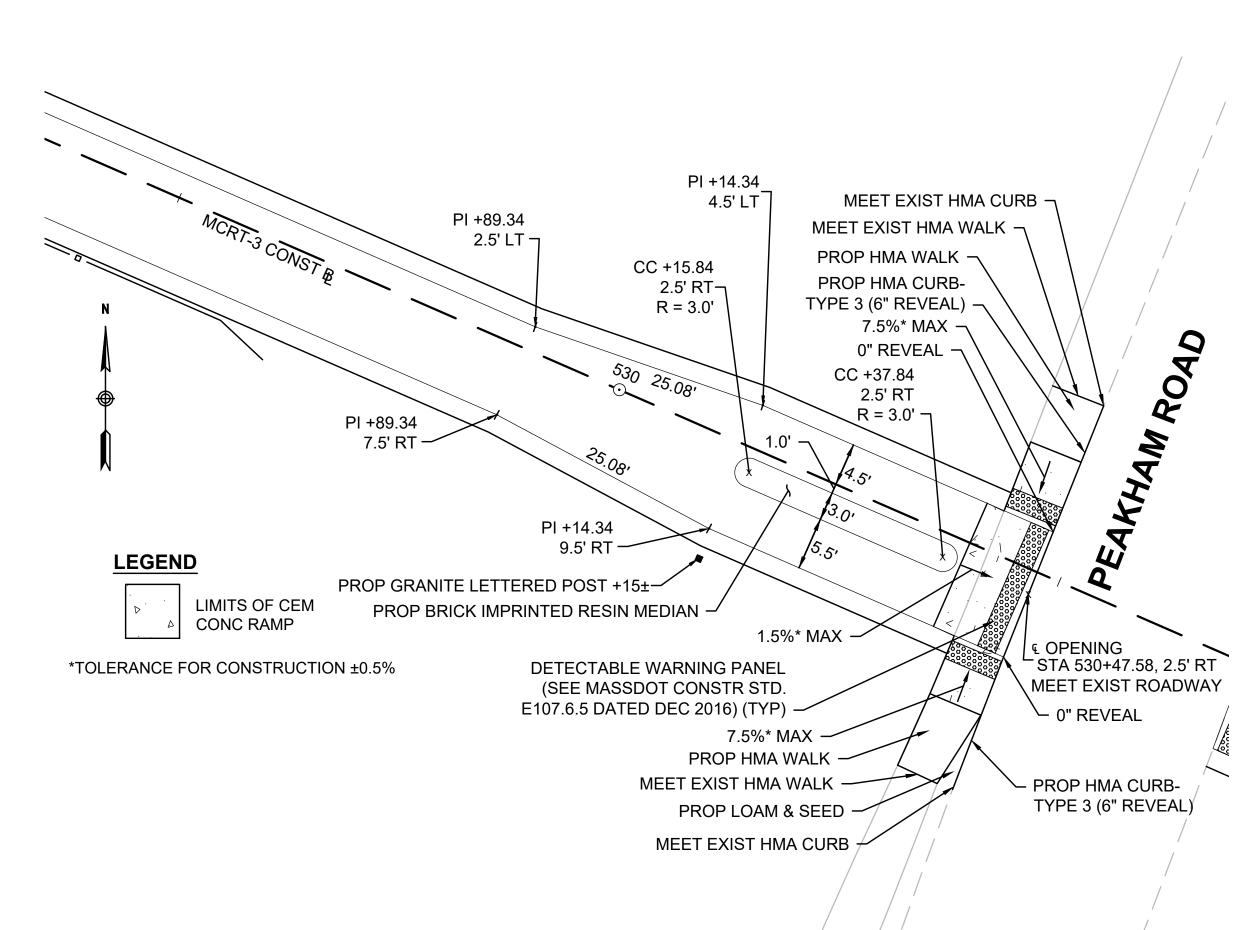


#### GATEWAY 11 - PEAKHAM ROAD (WEST)

SCALE: 1" = 10'

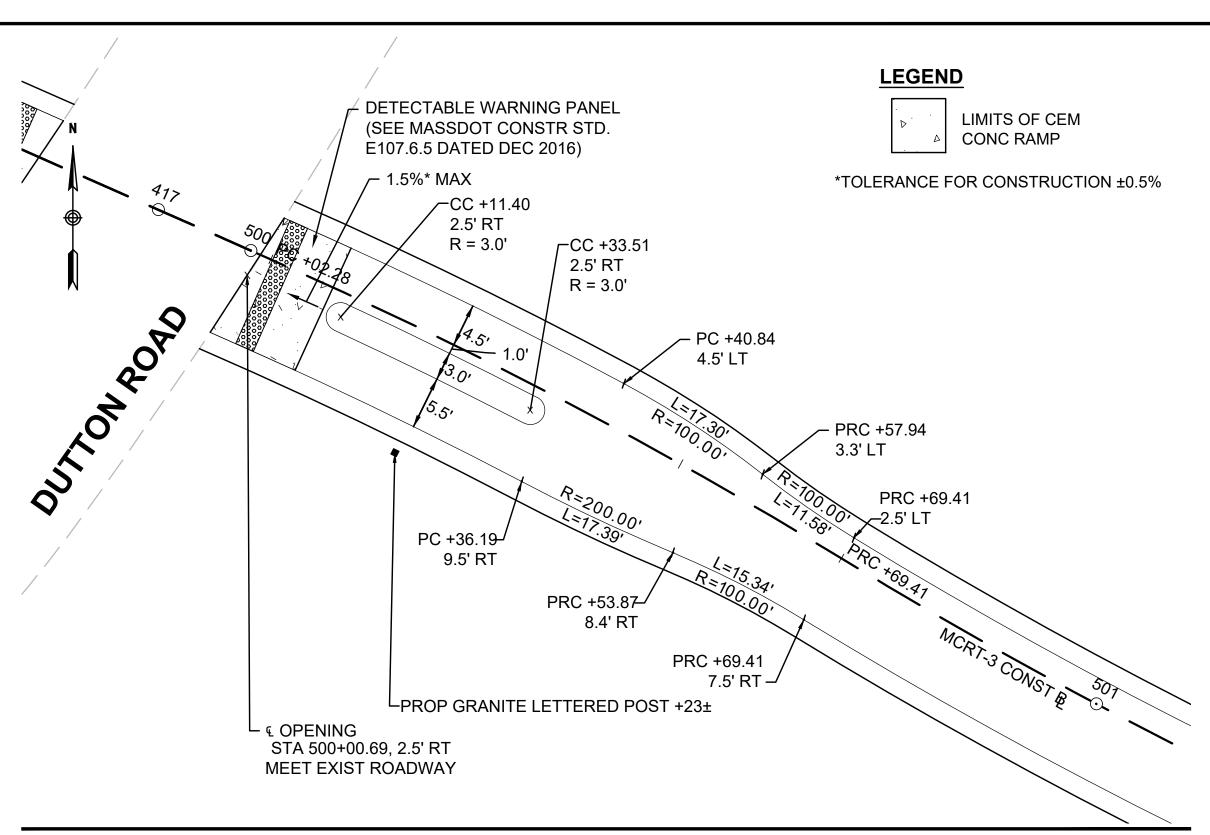

#### **GATEWAY 10 - DUTTON ROAD (EAST)**

SCALE: 1" = 10'

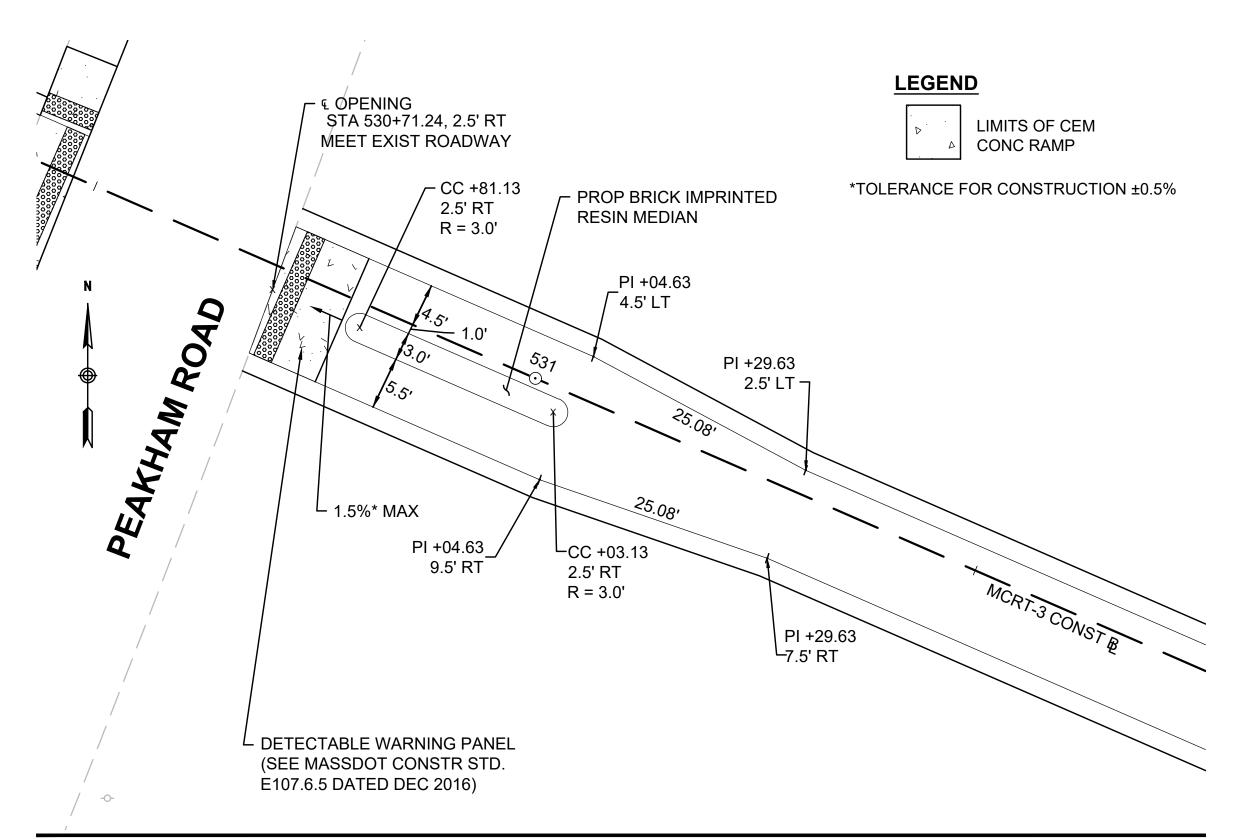

#### GATEWAY 12 - PEAKHAM ROAD (EAST)

SCALE: 1" = 10'





### COMMONWEALTH OF MASSACHUSETTS DEPARTMENT OF CONSERVATION AND RECREATION DIVISION OF PLANNING AND ENGINEERING

MASS CENTRAL RAIL TRAIL - WAYSIDE

MASS CENTRAL RAIL TRAIL
HUDSON, STOW, MARLBOROUGH & SUDBURY, MA

DESIGNER:JCR	GATEWAY	DETAILS	SHEET
CHECKED: SHK	GAILWAI	DETAILO	
DRAWN: JCR	CONT. P19-3295-D1A	SCALE: 1" = 20'-0"	GW.
CHECKED: TAL	ACC. XXXXXXX	DATE: 3/13/2020	   3 OF

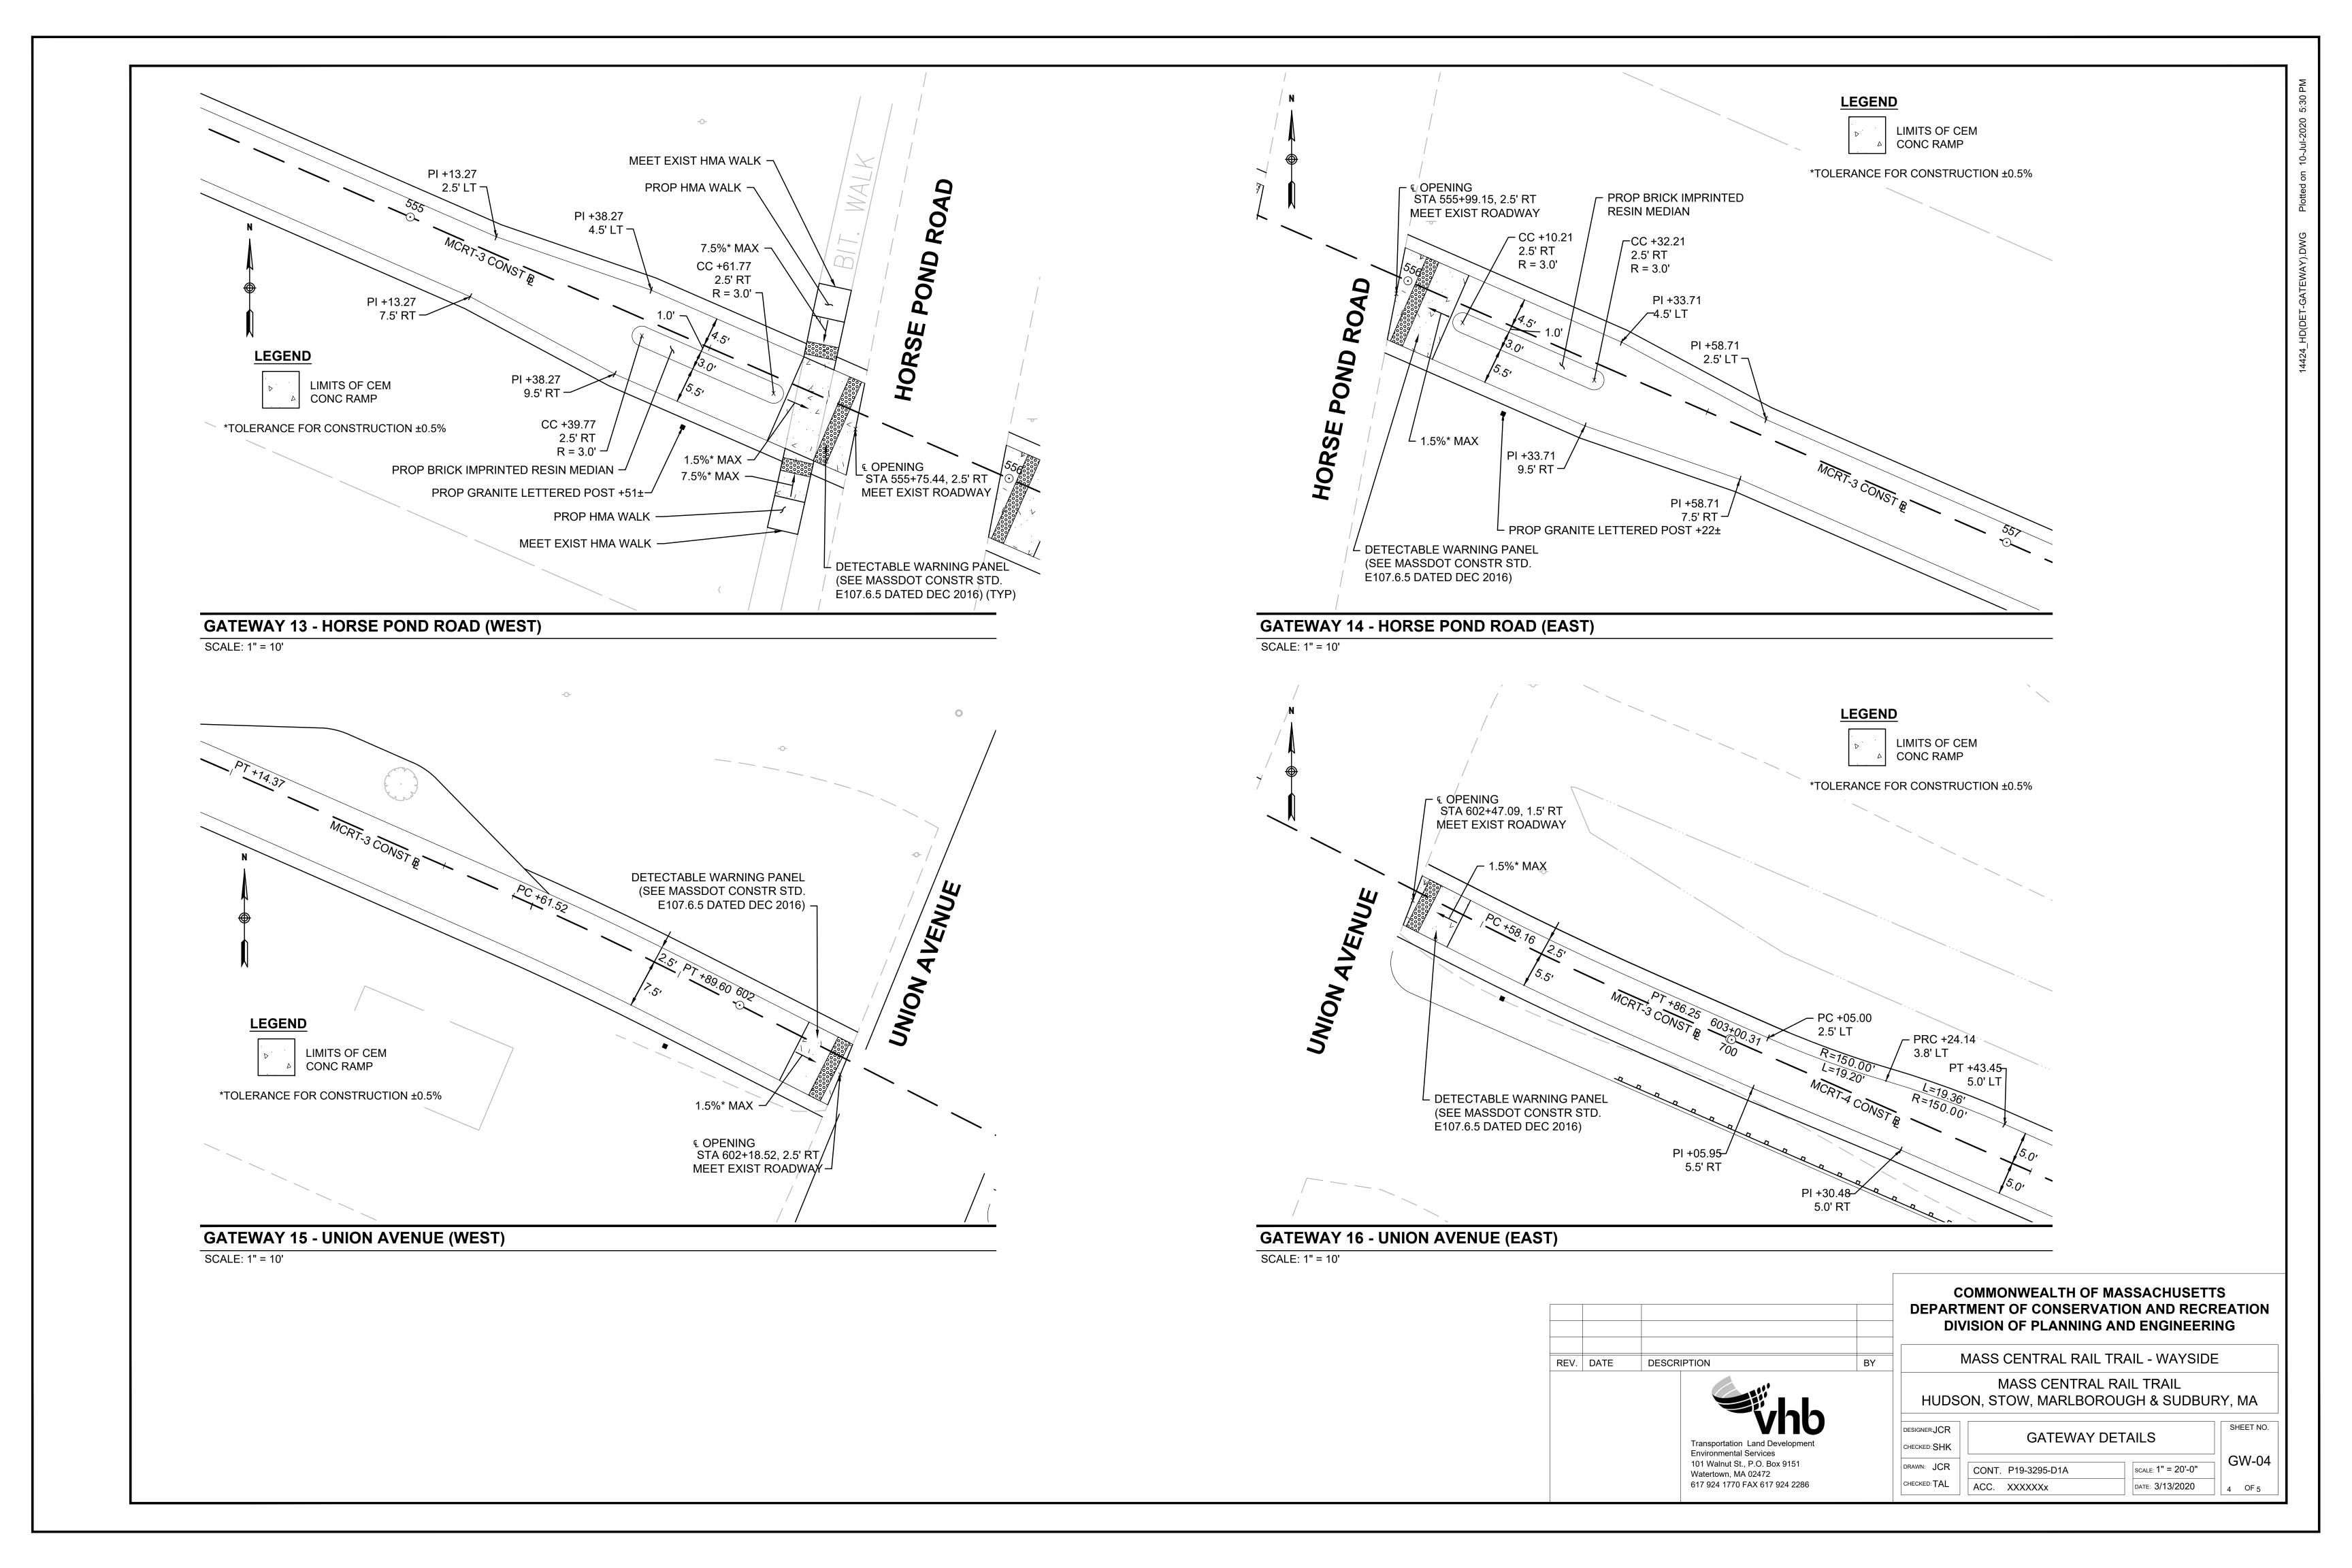

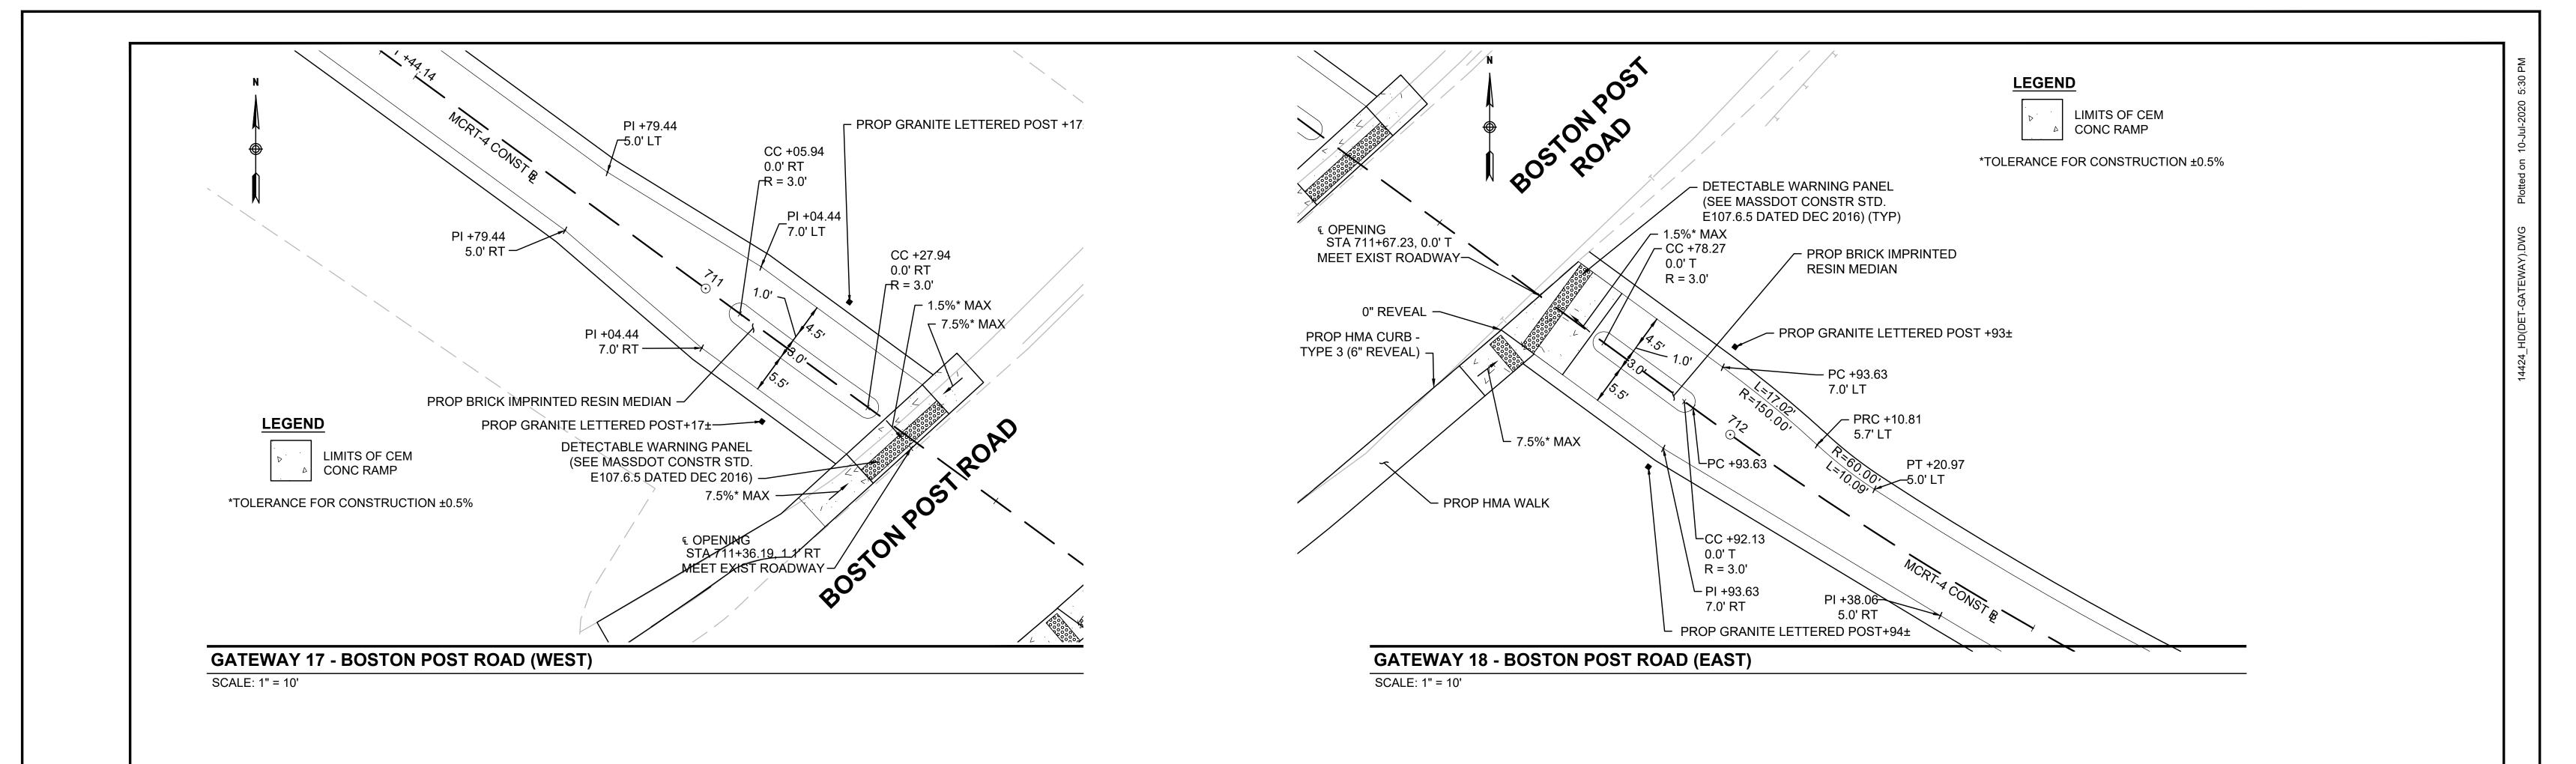



# COMMONWEALTH OF MASSACHUSETTS DEPARTMENT OF CONSERVATION AND RECREATION DIVISION OF PLANNING AND ENGINEERING

,	MASS CENTRAL RAIL TRAIL - WAYSIDE			
	MASS CENTRAL RAIL TRAIL			
	HUDSON, STOW, MARLBOROUGH & SUDBURY, MA			
	DESIGNER: ICR SHEET NO.			

DESIGNER:JCR	GATEWAY DETAILS		SHEET NO.
CHECKED: SHK			
DRAWN: JCR	CONT. P19-3295-D1A	SCALE: 1" = 20'-0"	GW-05
CHECKED: TAL	ACC. XXXXXXX	DATE: 3/13/2020	5 OF 5