




7 EXISTING: PHOTO OF ATTIC FLOOR
NTS

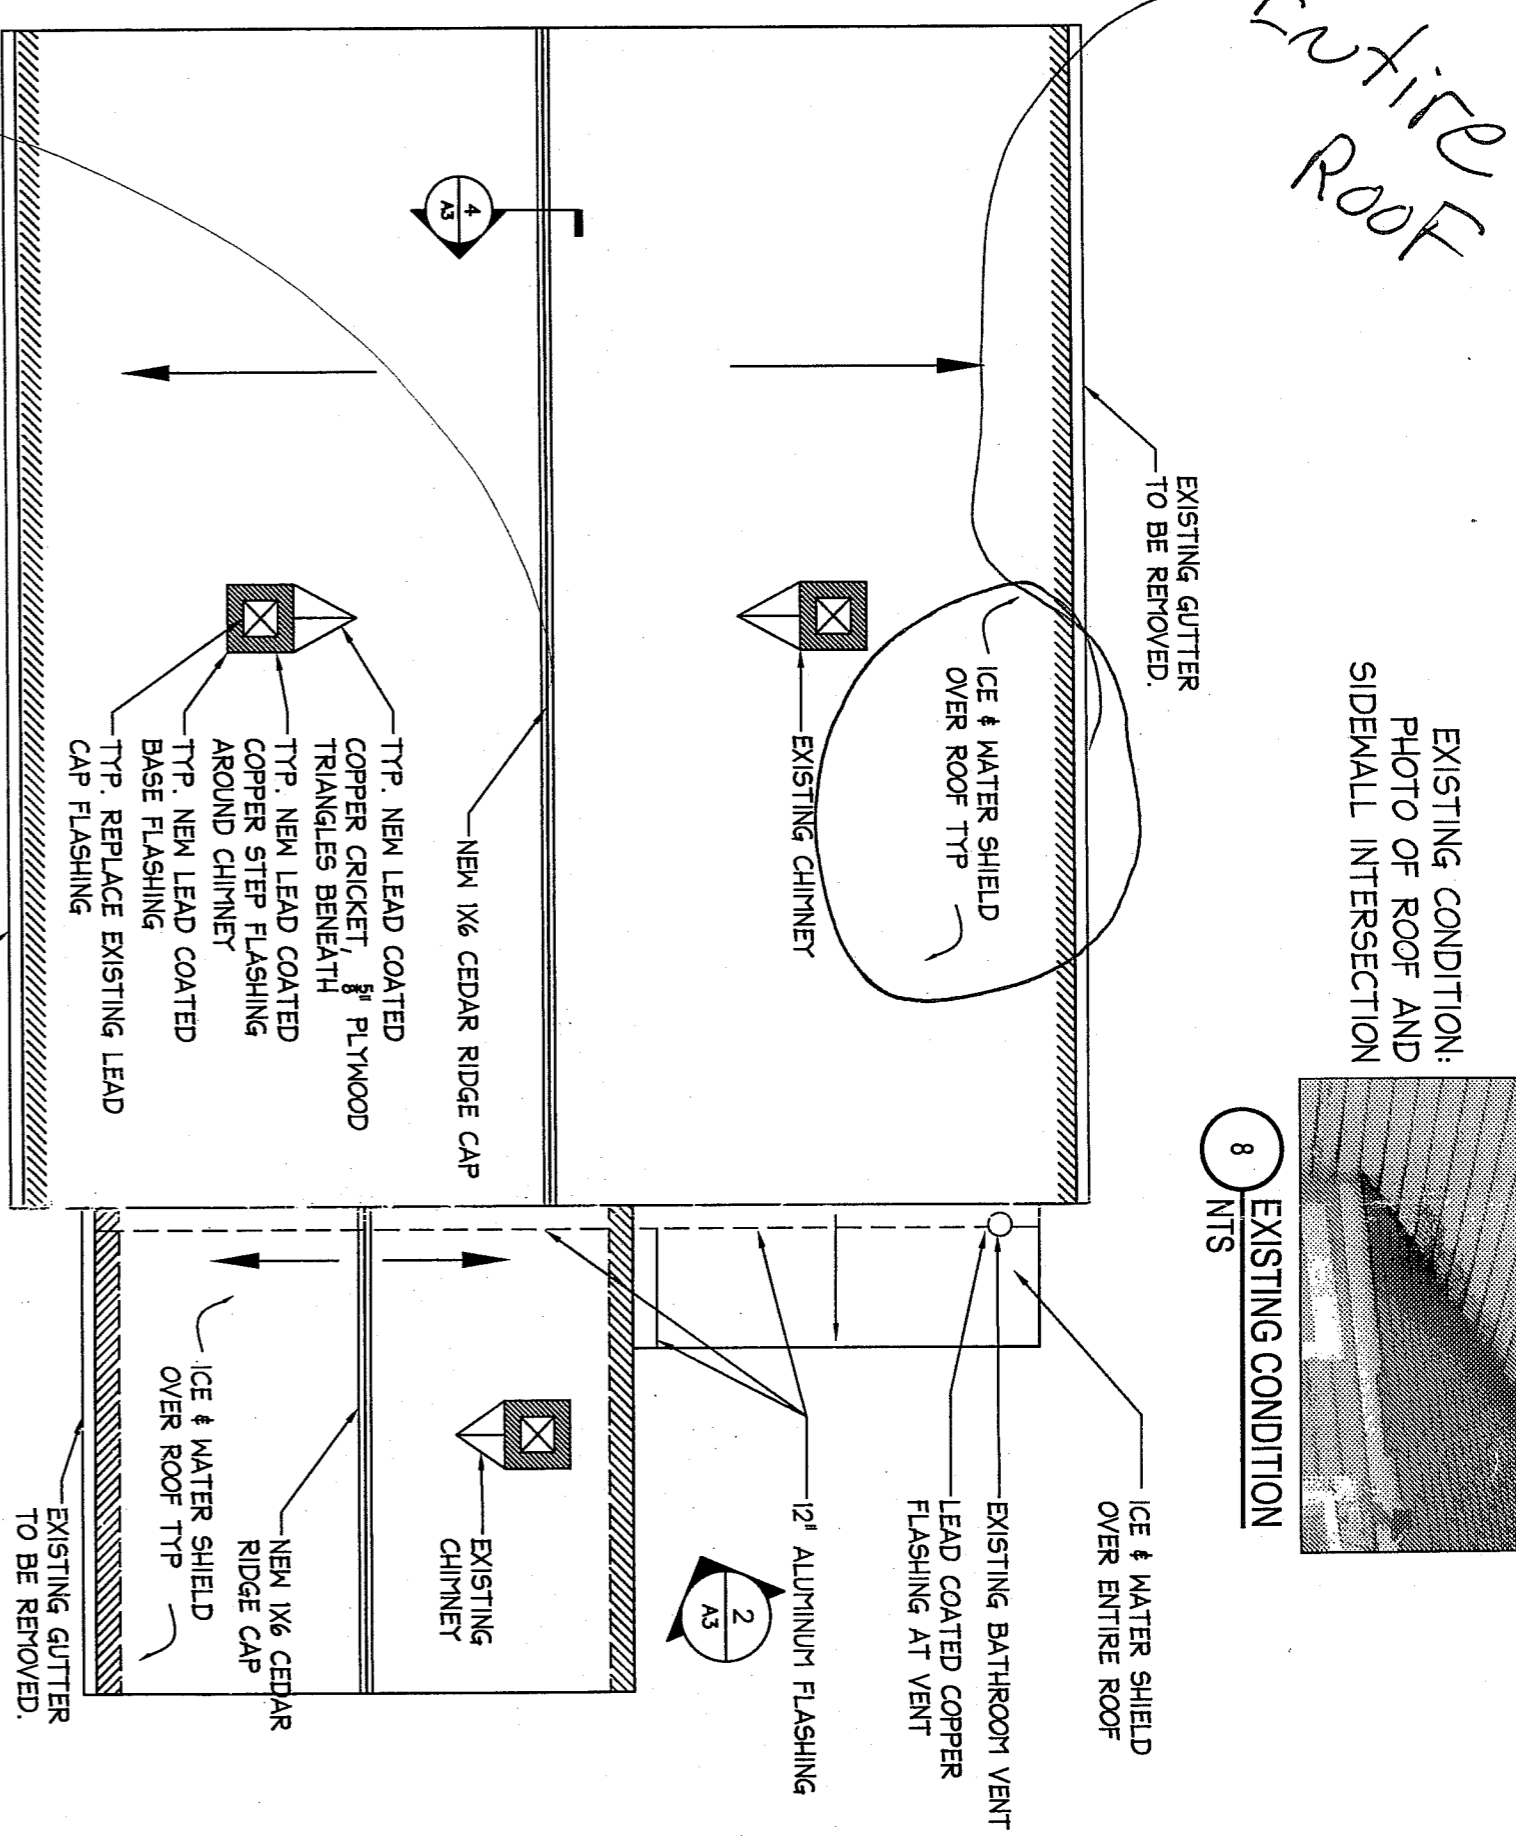



8 EXISTING CONDITION: PHOTO OF ROOF AND SIDEWALL INTERSECTION
NTS

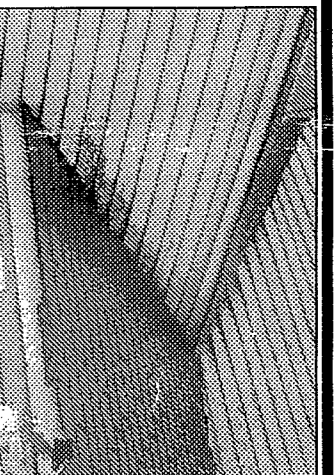


8 EXISTING CONDITION
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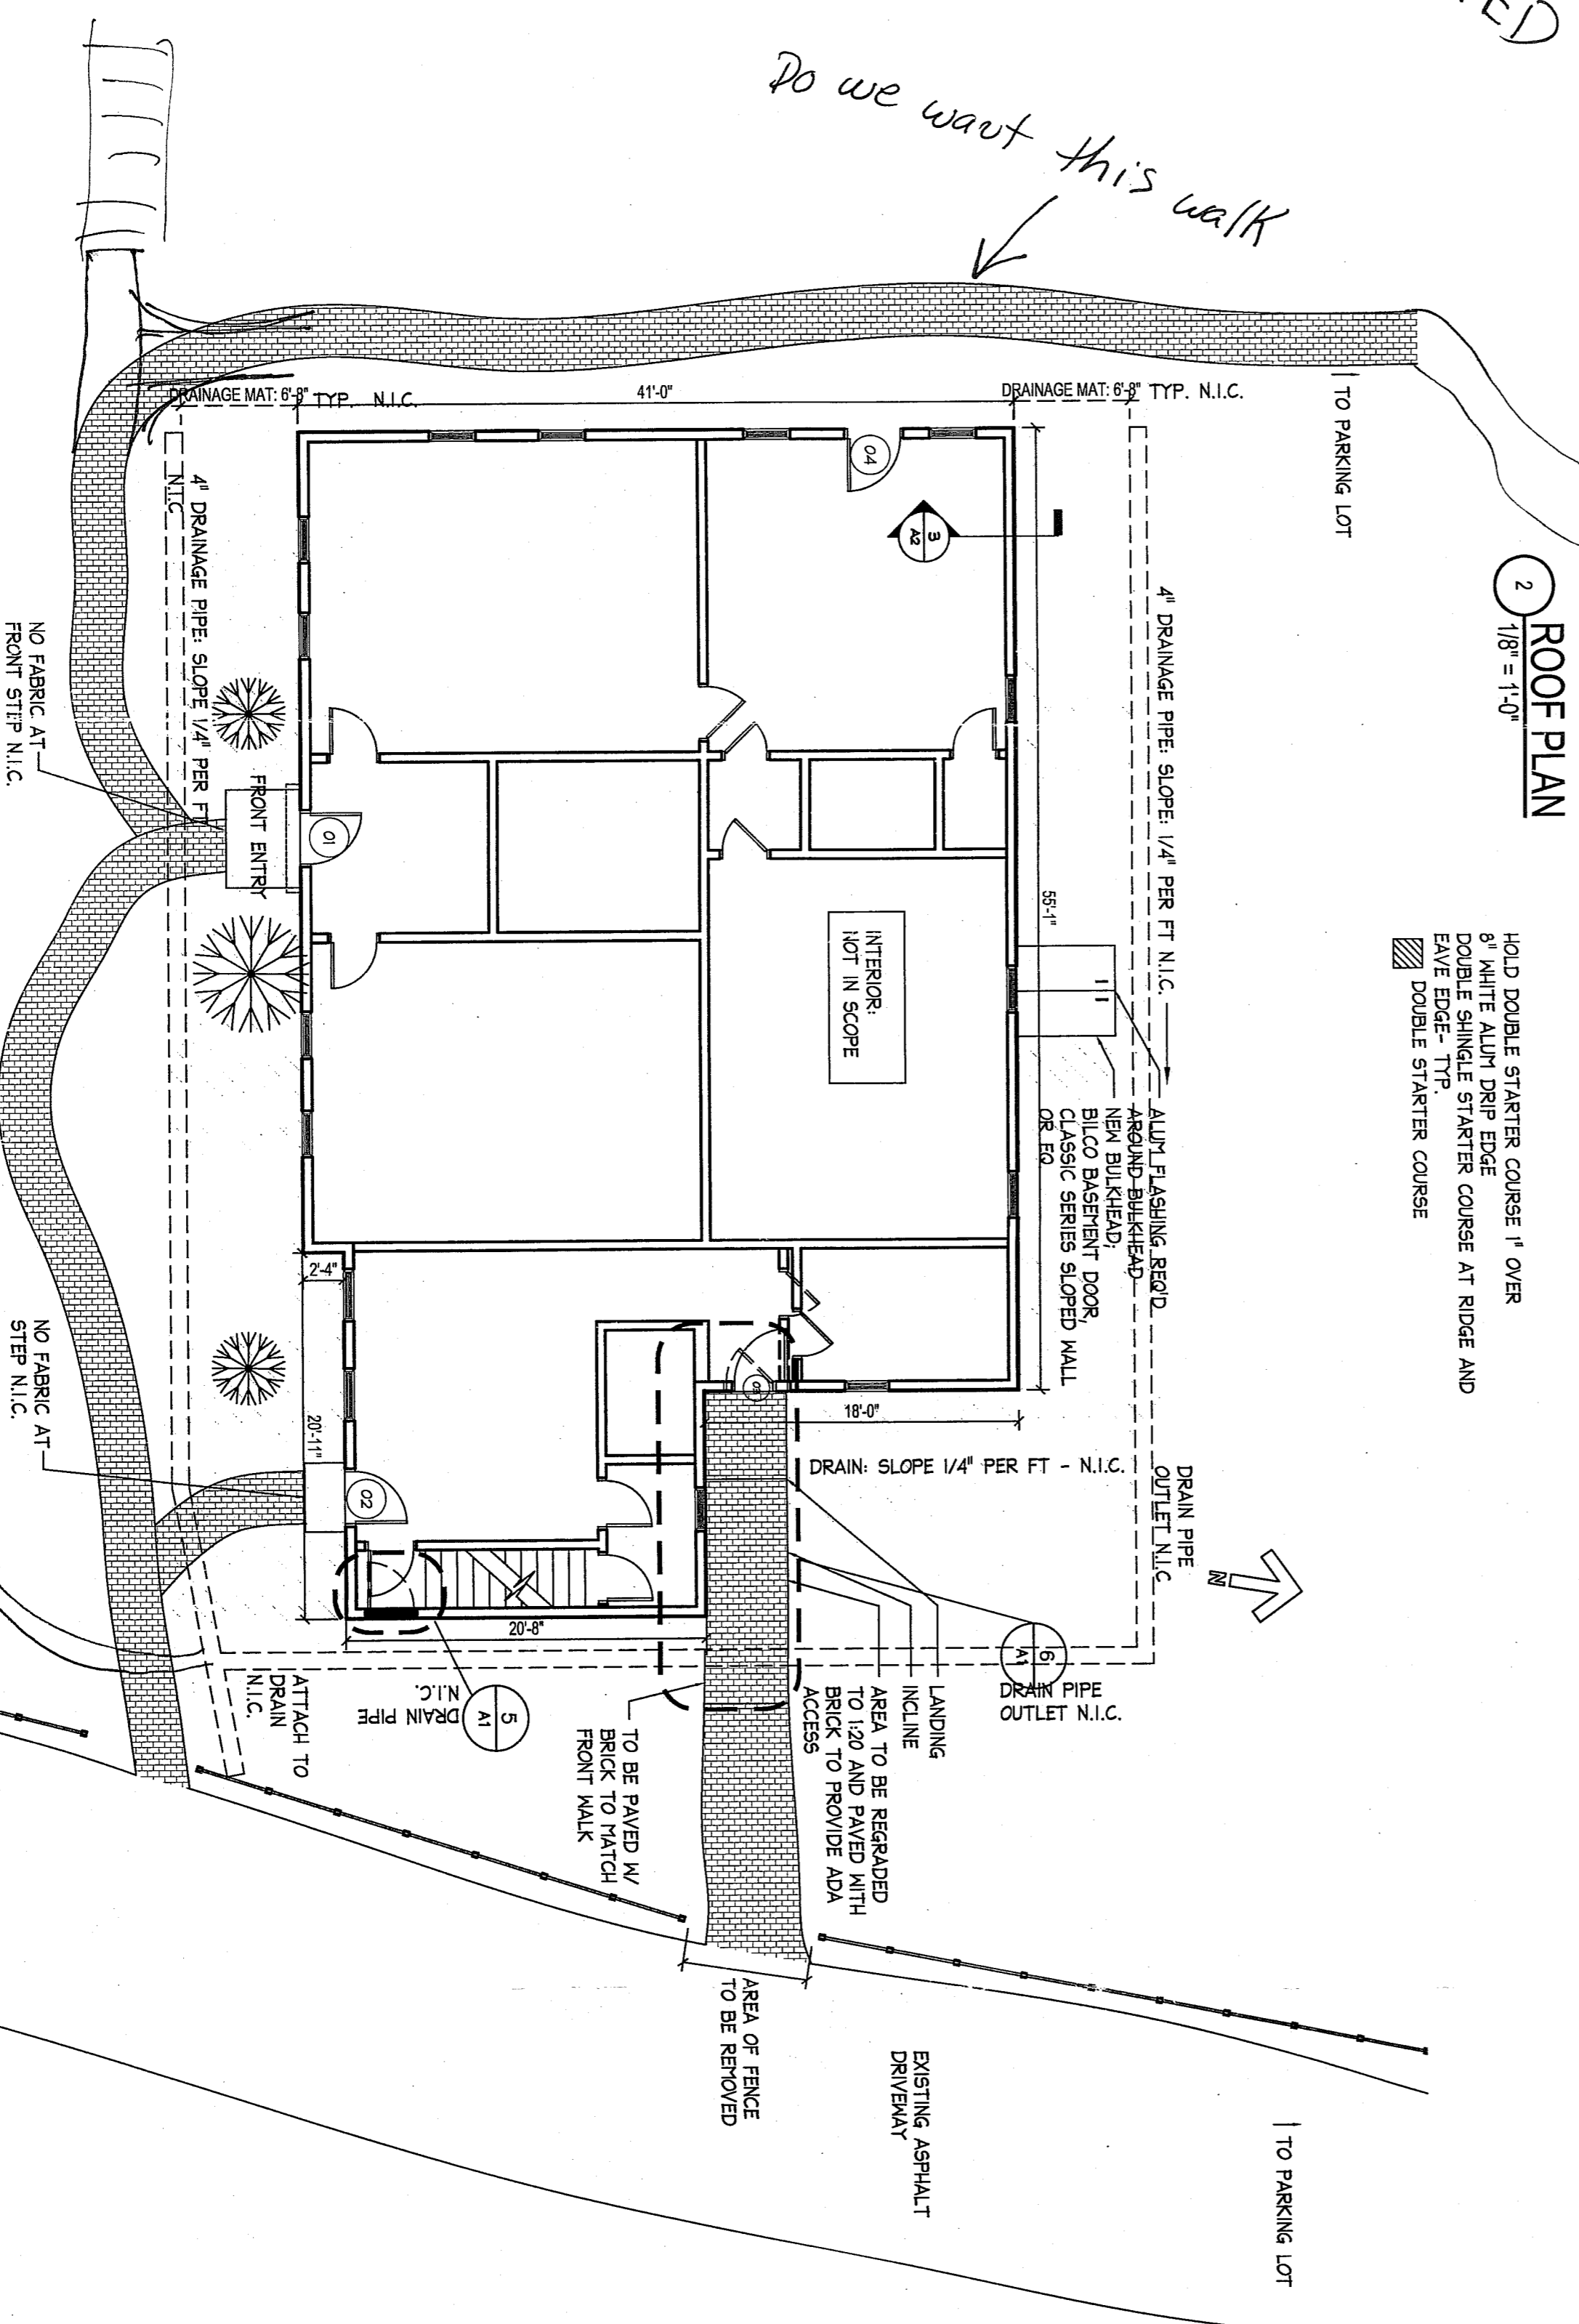
10 EXISTING CONDITION
NTS

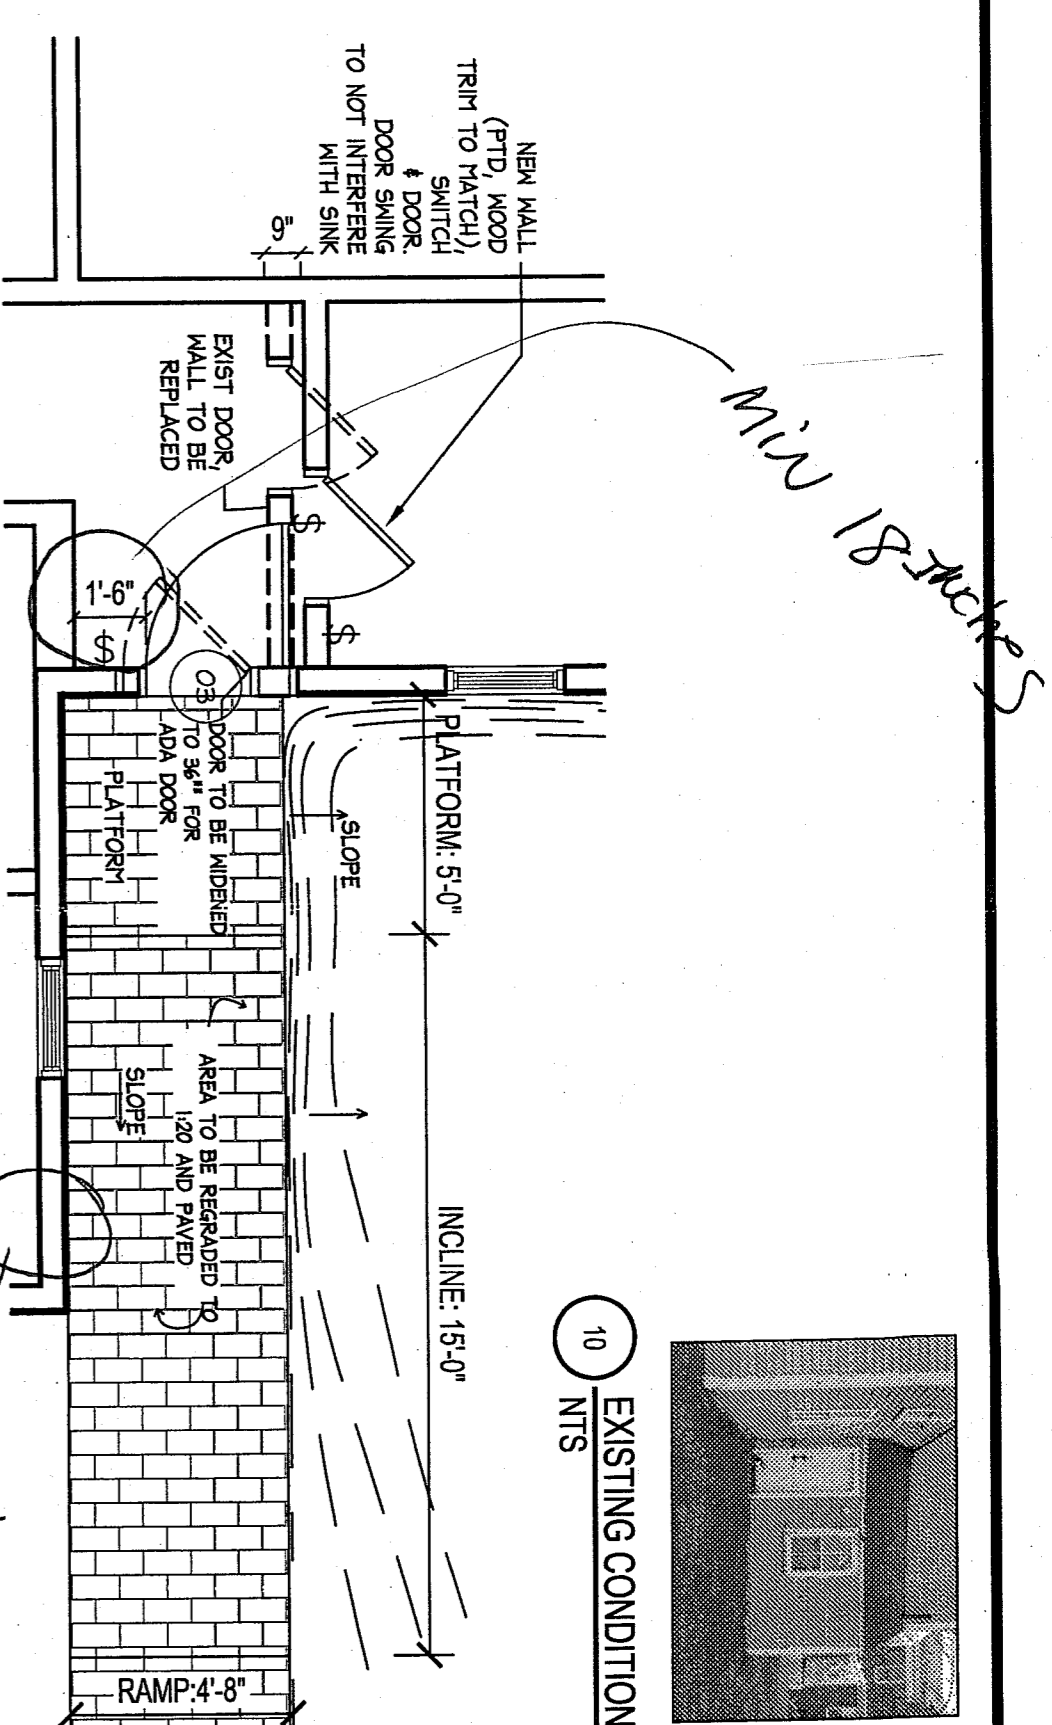

9 EXISTING CONDITION
NTS

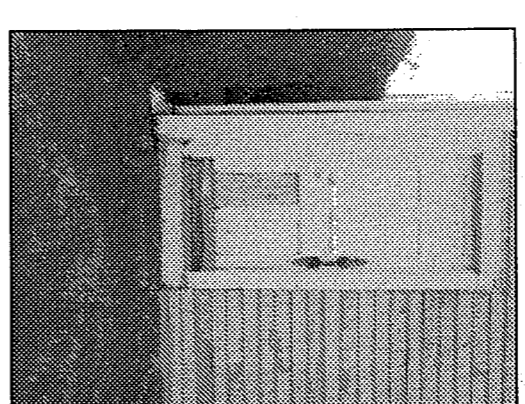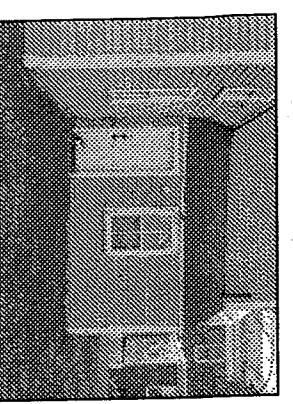

5 PARTIAL ENLARGED FIRST FLOOR PLAN
1/4" = 1'-0"

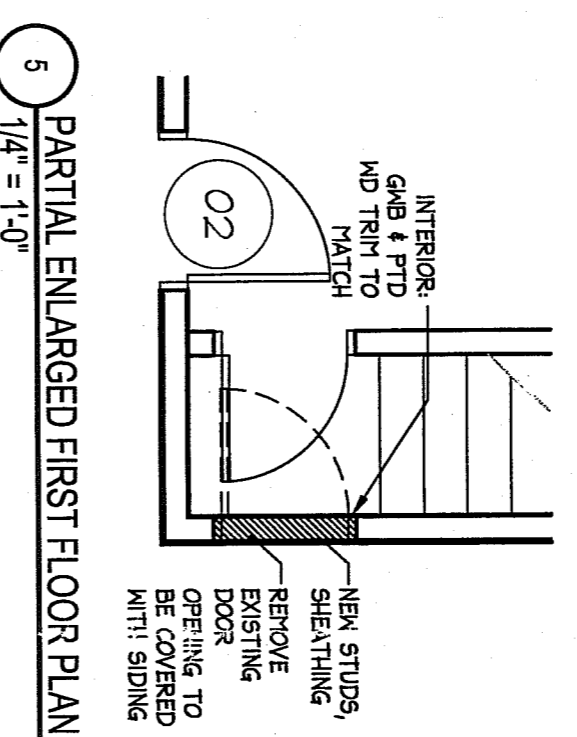

2 ROOF PLAN
1/8" = 1'-0"

HOLD DOUBLE STARTER COURSE 1' OVER
8" WHITE ALUMINUM EDGE COURSE AT RIDGE AND
EAVE EDGE. TYP.
DOUBLE STARTER COURSE

1 PARTIAL SITE PLAN
1/8" = 1'-0"

Drains Goes to Basin

FOR CONSTRUCTION

ERRA

E. R. RACEK ASSOCIATES
ARCHITECTURE - PLANNING - INTERIORS
180 CANAL ST.
BOSTON, MA 02114
WWW.ERRACAK.COM


P: 617-567-0725
F: 617-273-1418
INFO@ERRACK.COM

PROJECT INFO:
Loring Parsonage
Town of Sudbury
288 Old Sudbury Road
Sudbury, MA 01776

SHEET TITLE:
ROOF PLAN
BASEMENT PLAN
SITE PLAN
PARTIAL ENLARGED FLOOR
PLANS

SCALE: AS SHOWN
DATE: 2.25.09
DRAWN BY: JR
CHECKED BY: BMR

A1

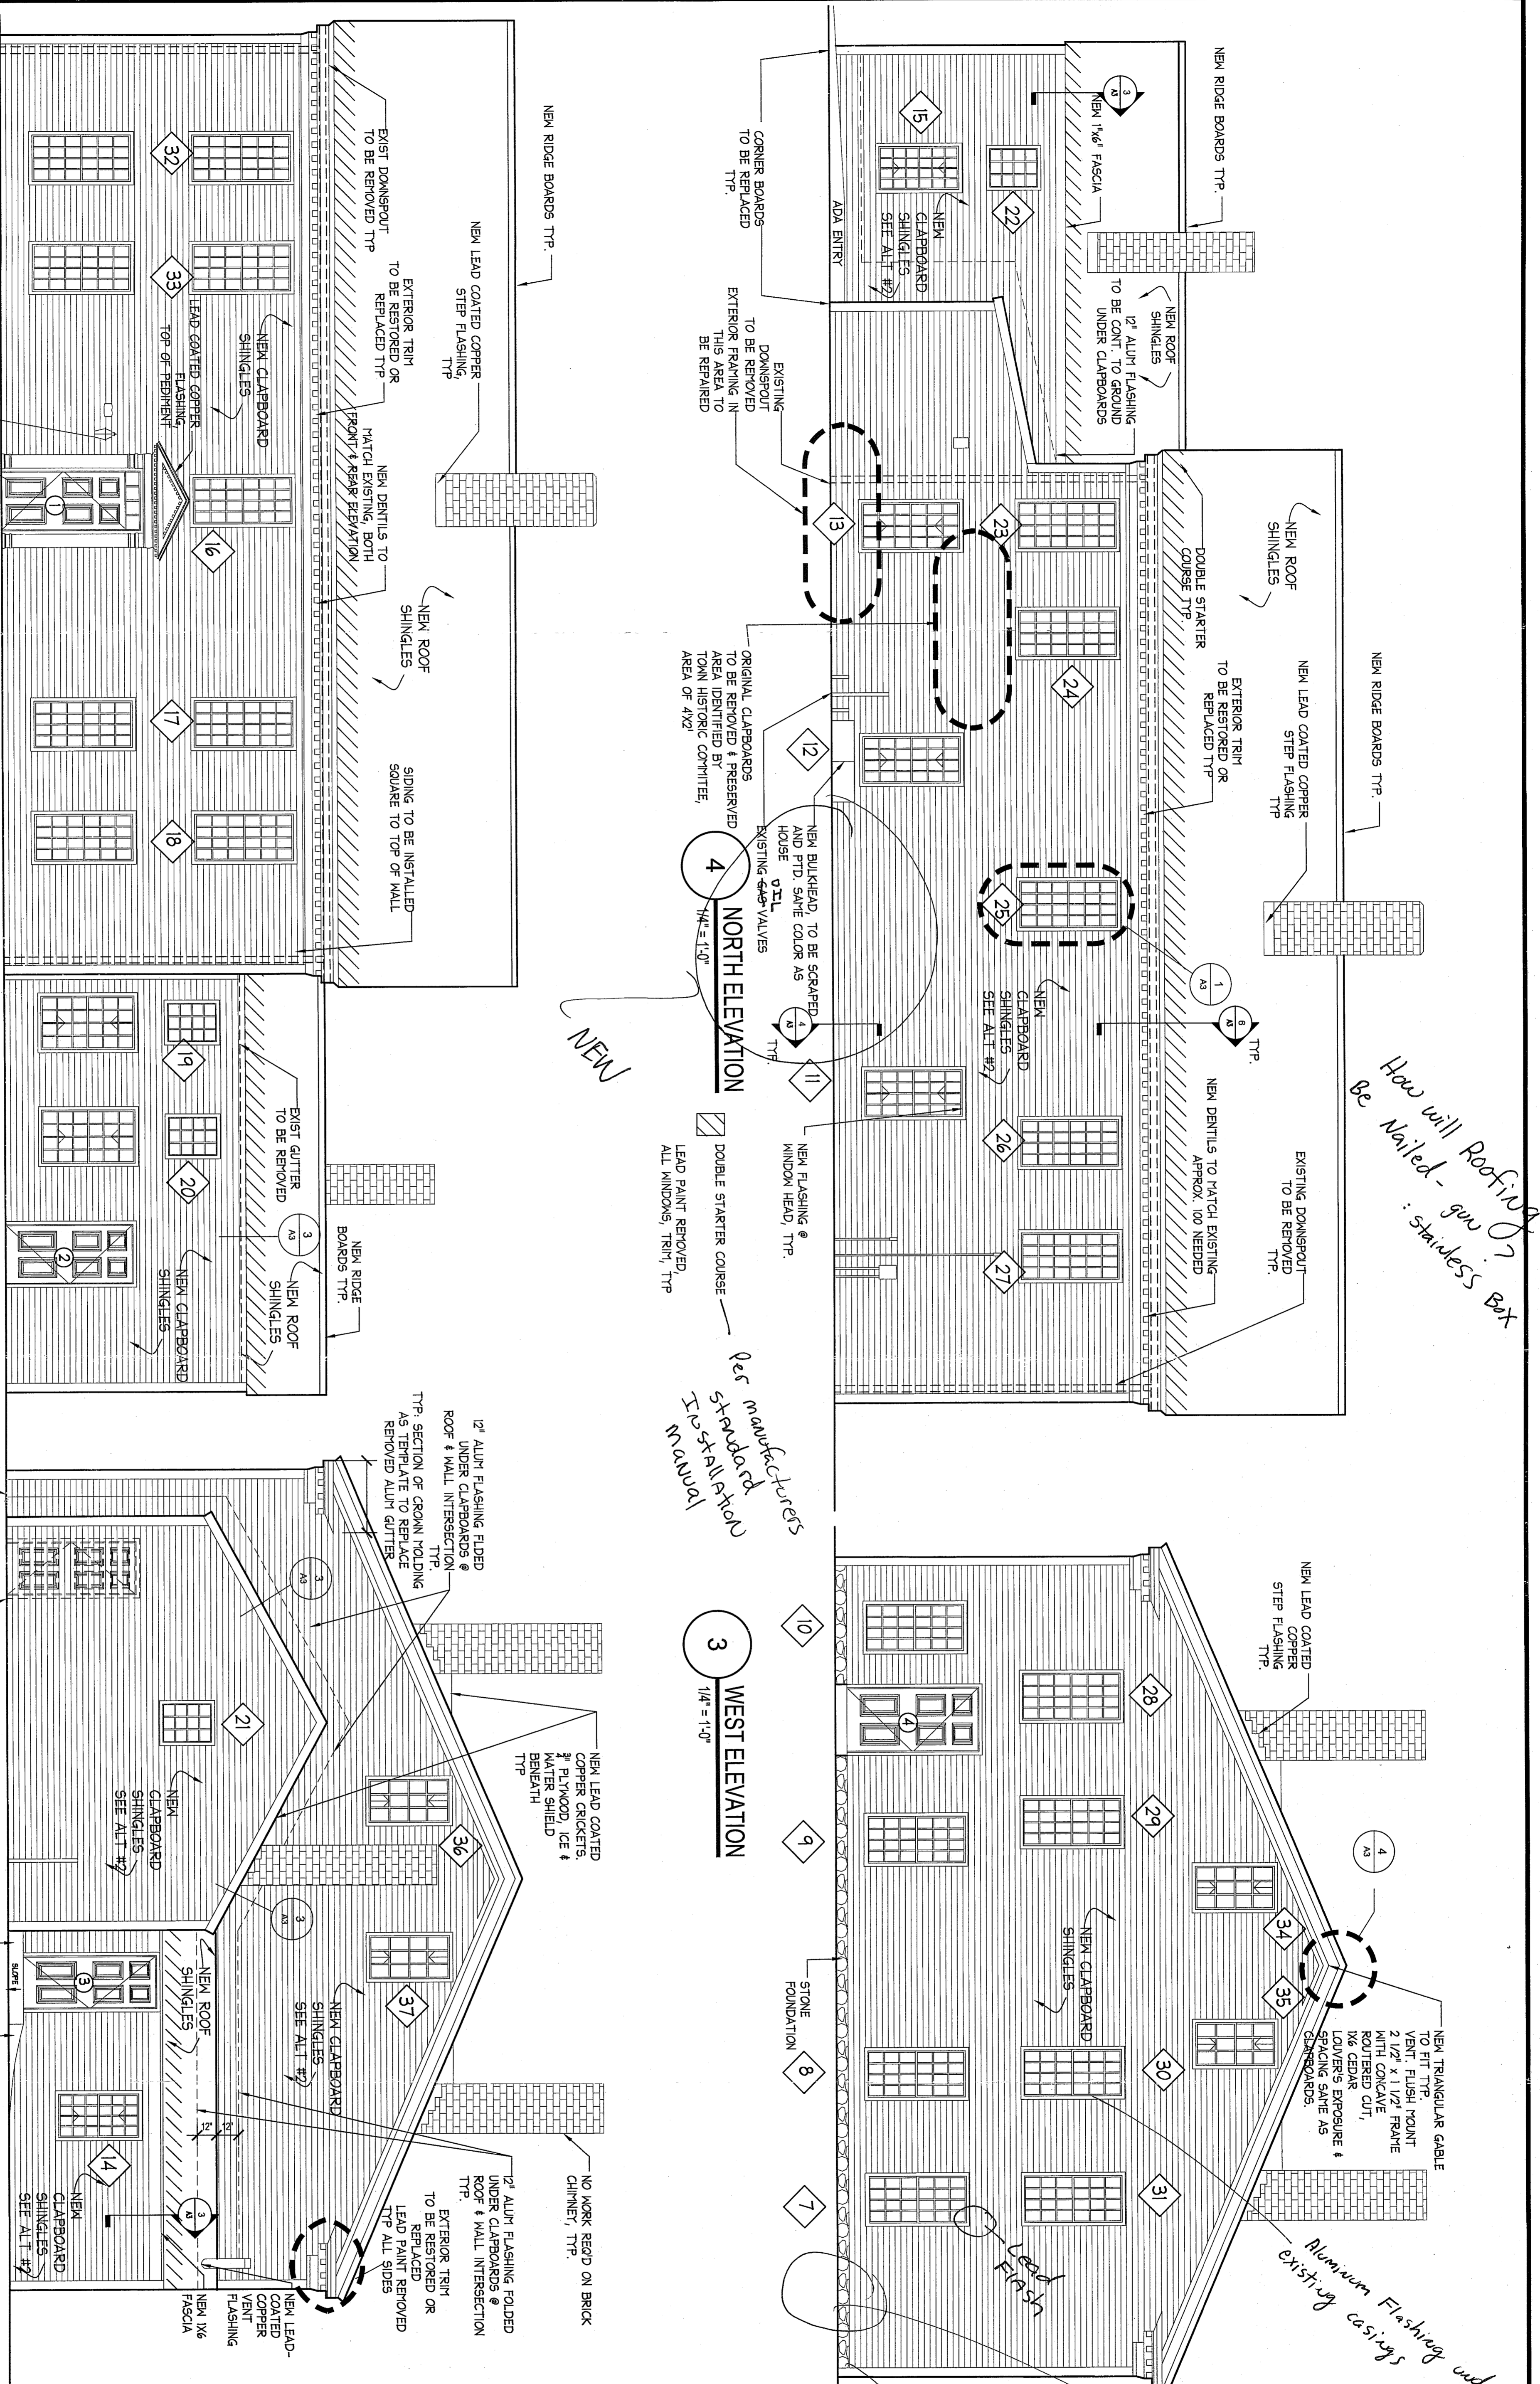

FOR CONSTRUCTION

SCALE	AS SHOWN	DRAWN BY:	JR
DATE	2.25.09	CHECKED BY:	ERR


ELEVATIONS

Project Name:
Loring Parsonage
Town of Sudbury
288 Old Sudbury Road
Sudbury, MA 01776


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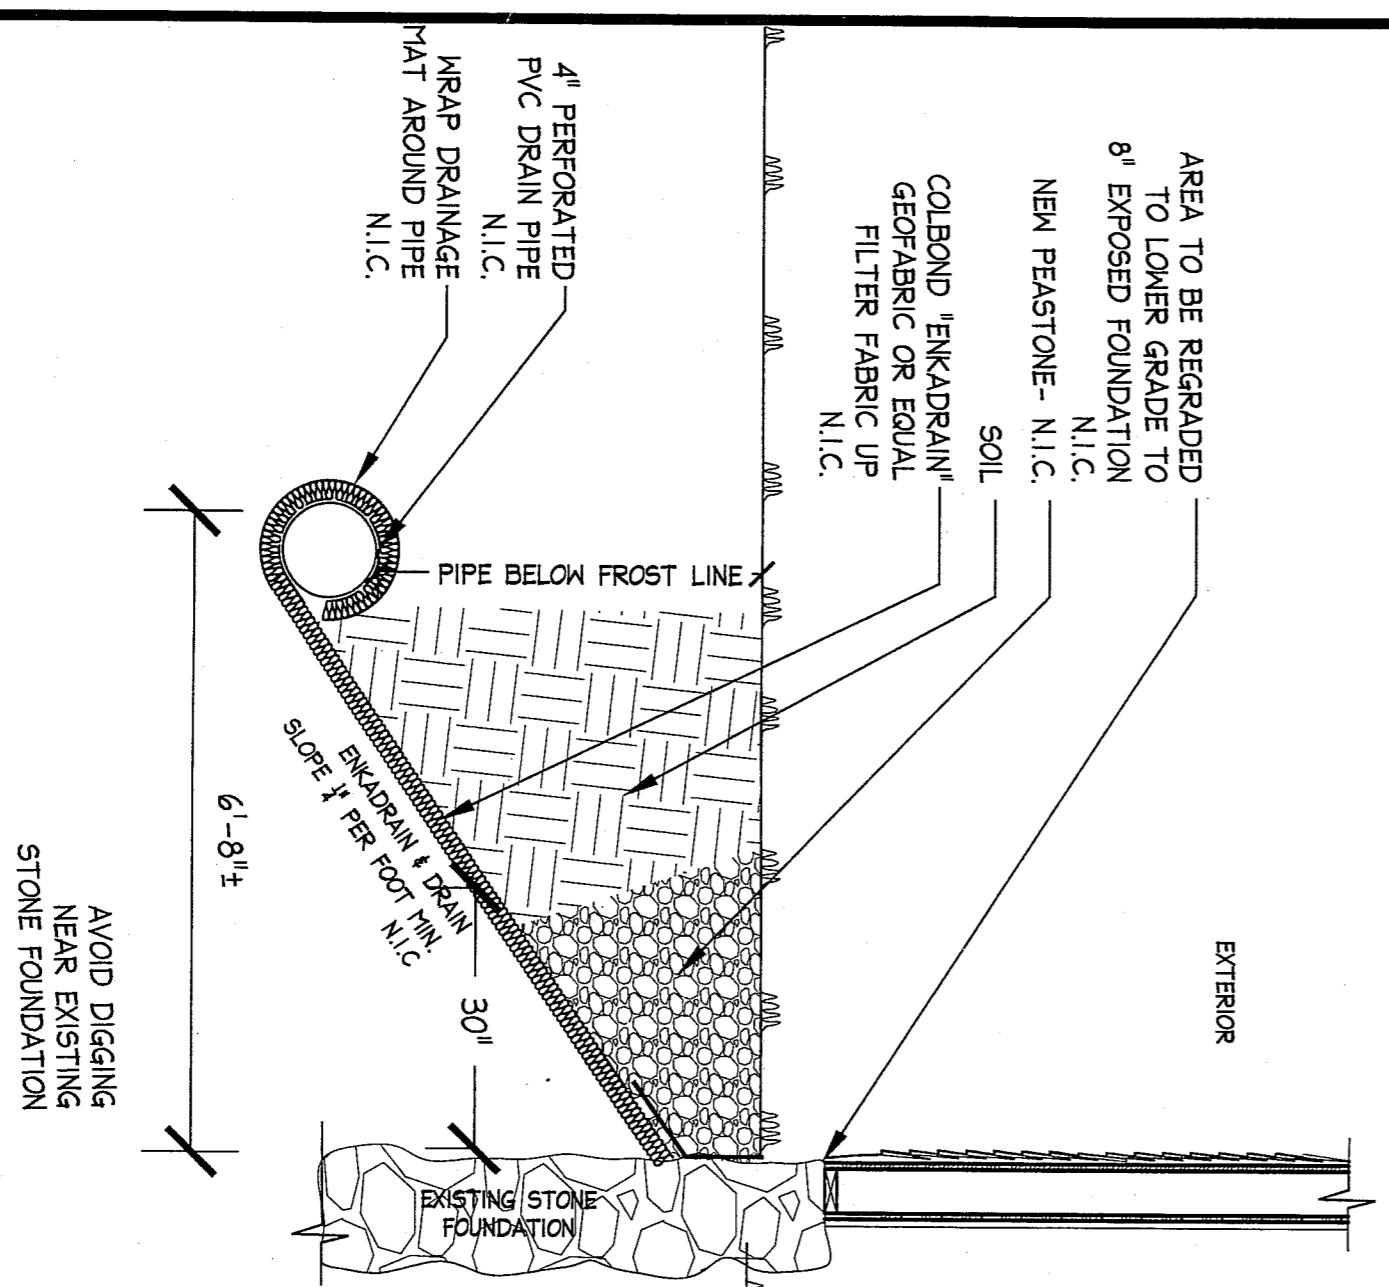
DATE: _____
DRAWINGS ISSUED TO: _____




7 TYPICAL ROOF SECTION
3/4" = 1'-0"

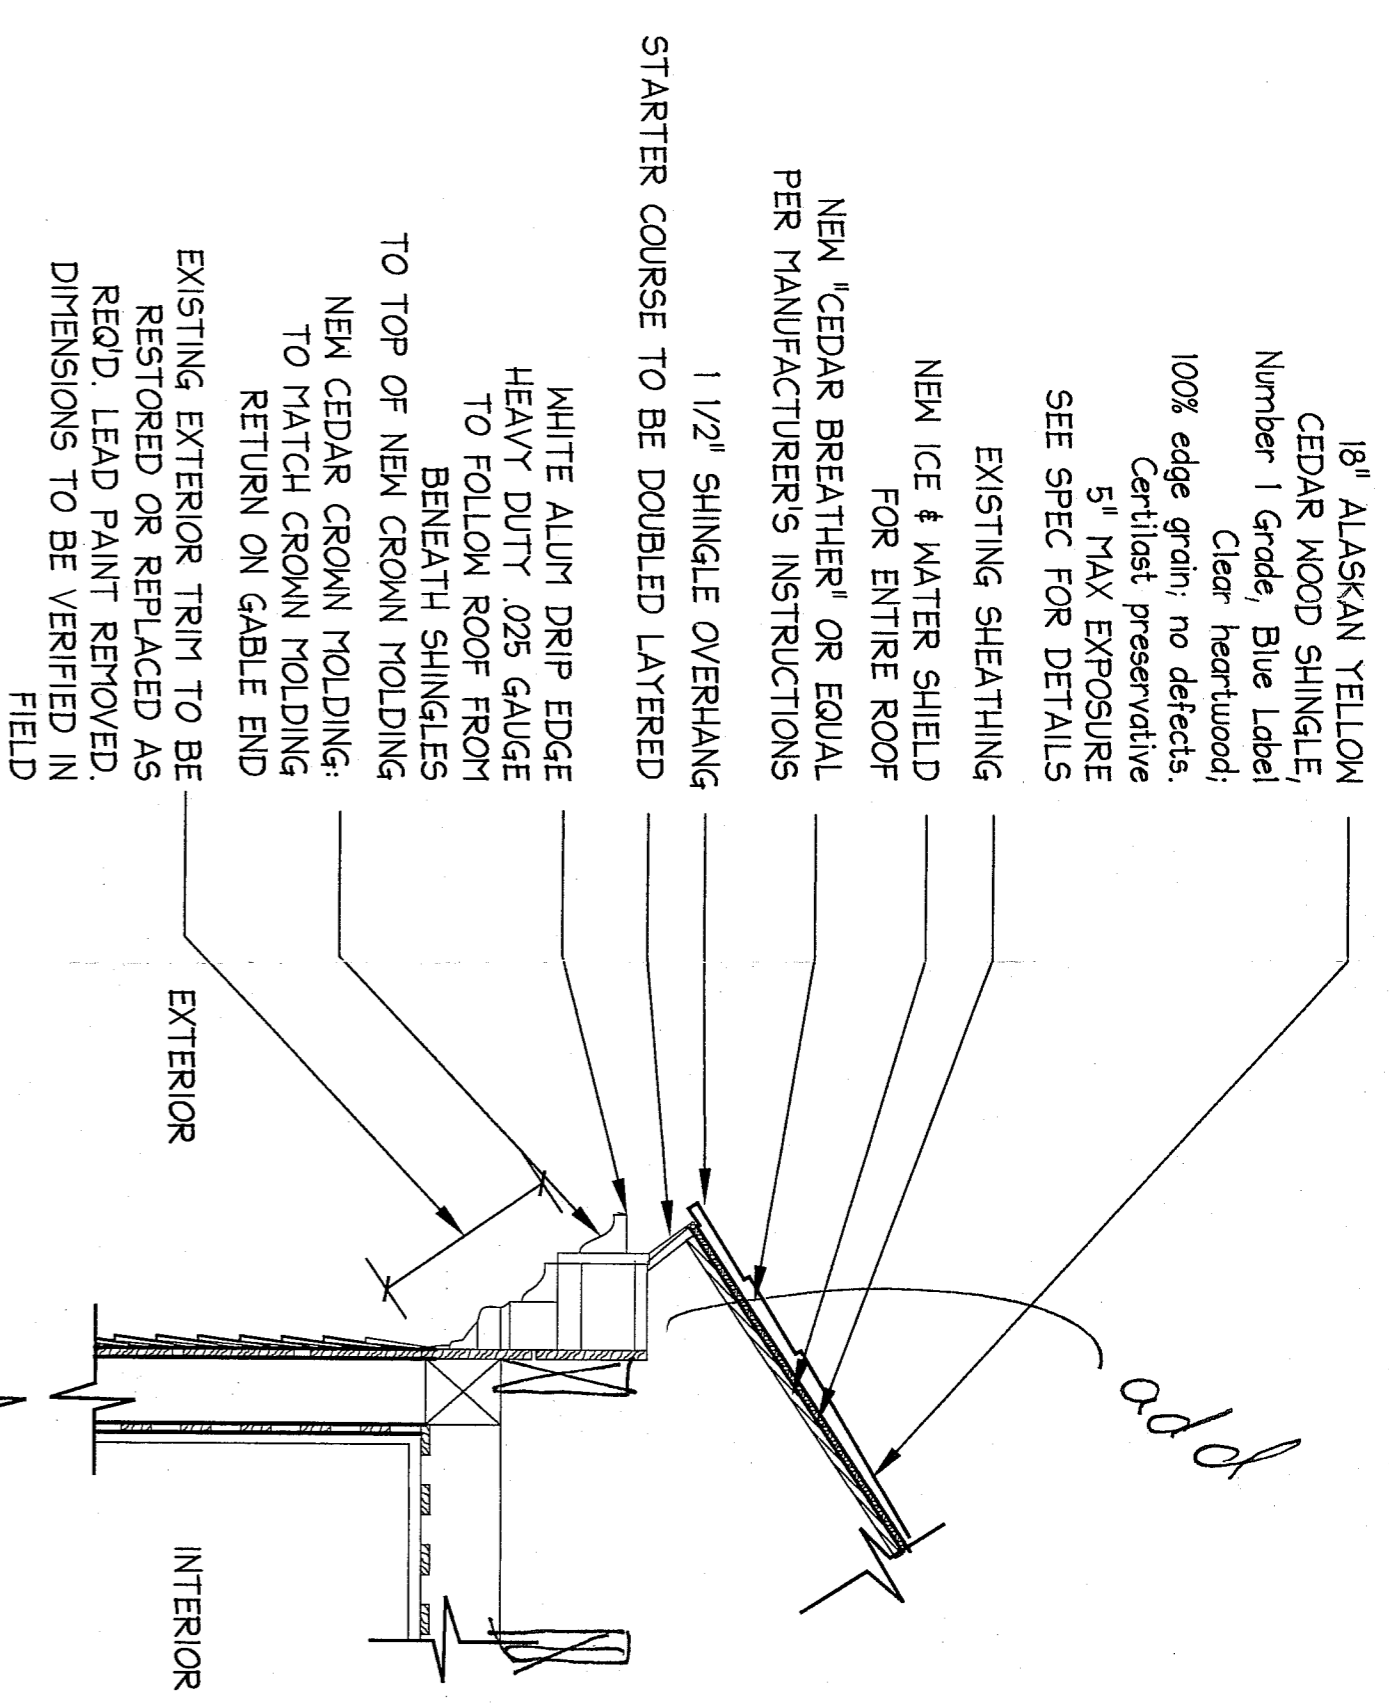

6 TYPICAL WALL SECTION
3/4" = 1'-0"

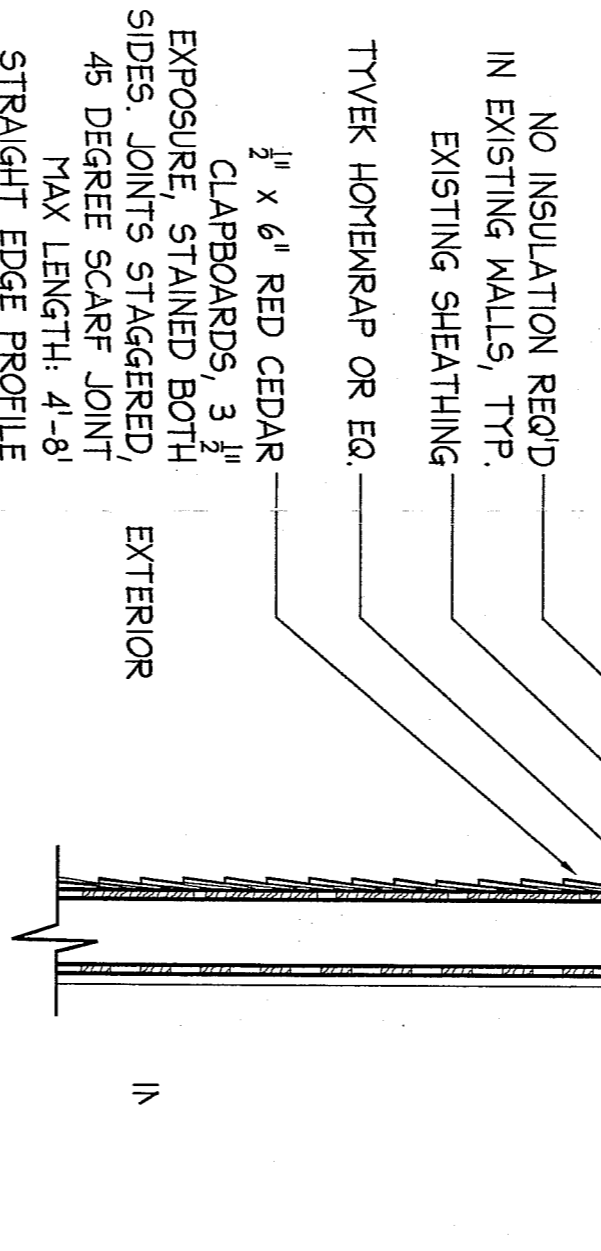


8 DRAINAGE MAT DETAIL N.I.C.
1/2" = 1'-0"

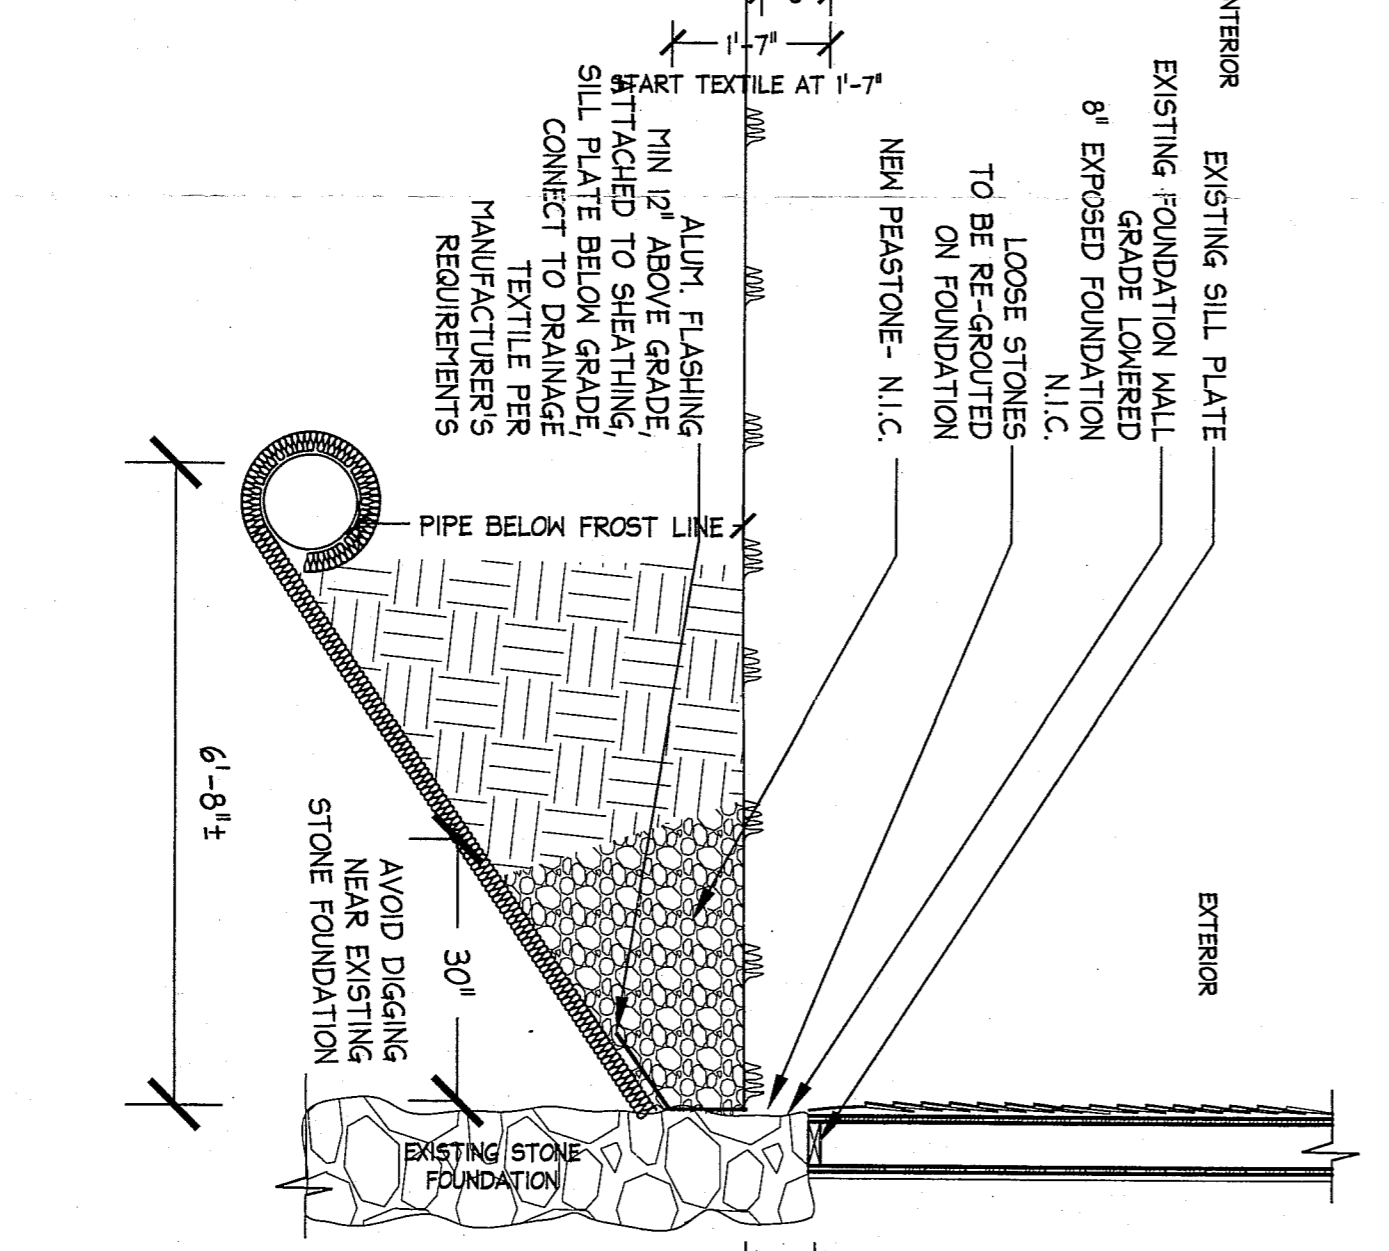


5 WALL FLASHING SECTION
1/2" = 1'-0"

WINDOW SCHEDULE						
MARK	SIZE	Window	Sash	Sill	Operability	GLAZING
	WIDTH	HEIGHT	Repairs	Repairs		PUTTY
1	3'-0"	3'-0"	REQUIRED			
2	2'-8"	2'-8"	REQUIRED			
3	2'-8"	2'-8"	REQUIRED			
4	2'-8"	2'-8"	REQUIRED			
5	2'-8"	2'-8"	REQUIRED			
6	2'-8"	2'-8"	REQUIRED			
7	2'-8"	2'-8"	REQUIRED			
8	2'-8"	2'-8"	REQUIRED			
9	2'-8"	2'-8"	REQUIRED			
10	2'-8"	2'-8"	REQUIRED			
11	2'-8"	2'-8"	REQUIRED			
12	2'-8"	2'-8"	REQUIRED			
13	2'-8"	2'-8"	REQUIRED			
14	2'-8"	2'-8"	REQUIRED			
15	2'-6"	4'-4"	REQUIRED			
16	2'-8"	2'-8"	REQUIRED			
17	2'-8"	2'-8"	REQUIRED			
18	2'-8"	2'-8"	REQUIRED			
19	2'-8"	2'-8"	REQUIRED			
20	2'-8"	2'-8"	REQUIRED			
21	2'-8"	2'-8"	REQUIRED			
22	2'-8"	2'-8"	REQUIRED			
23	2'-8"	2'-8"	REQUIRED			
24	2'-8"	2'-8"	REQUIRED			
25	2'-8"	2'-8"	REQUIRED			
26	2'-8"	2'-8"	REQUIRED			
27	2'-8"	2'-8"	REQUIRED			
28	2'-8"	2'-8"	REQUIRED			
29	2'-8"	2'-8"	REQUIRED			
30	2'-8"	2'-8"	REQUIRED			
31	2'-8"	2'-8"	REQUIRED			
32	2'-8"	2'-8"	REQUIRED			
33	2'-8"	2'-8"	REQUIRED			
34	2'-8"	2'-8"	REQUIRED			
35	2'-8"	2'-8"	REQUIRED			
36	2'-8"	2'-8"	REQUIRED			
37	2'-8"	2'-8"	REQUIRED			

ALL SILLS/SASH/TRIM TO BE SCRUBBED AND PAINTED
LEAD PAINT TO BE REMOVED, EXTERIOR ONLY.
ALTERNATE #1 = LEAD PAINT TO BE REMOVED, WINDOWS TO BE PAINTED.

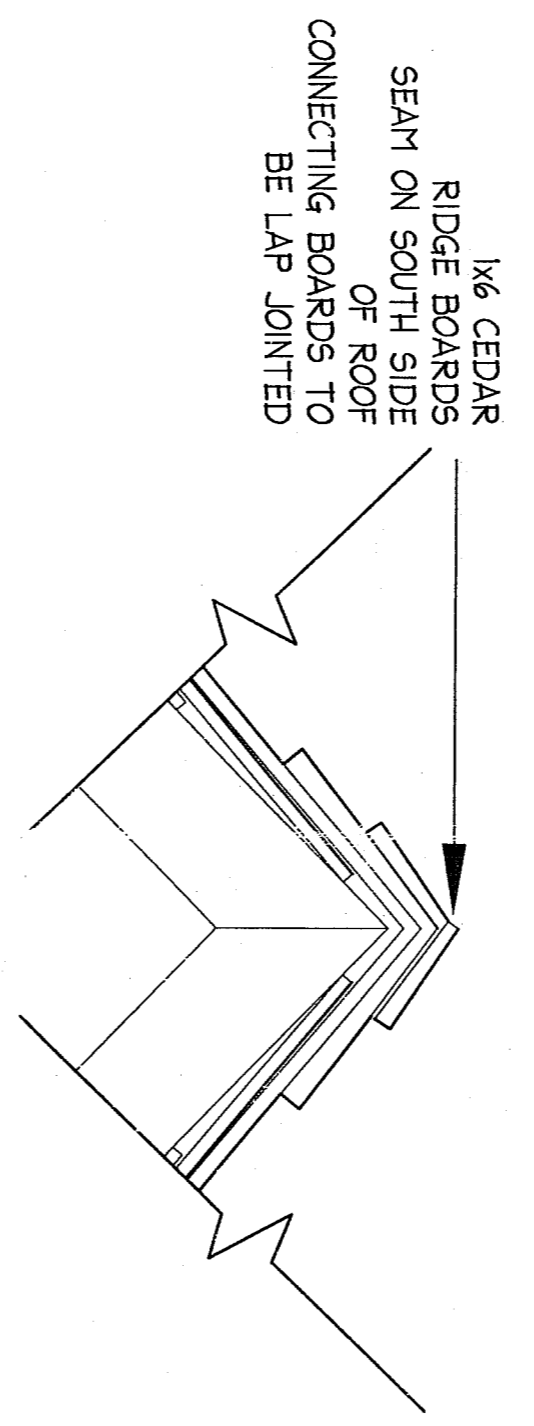


4 ROOF RIDGE SECTION
3" = 1'-0"

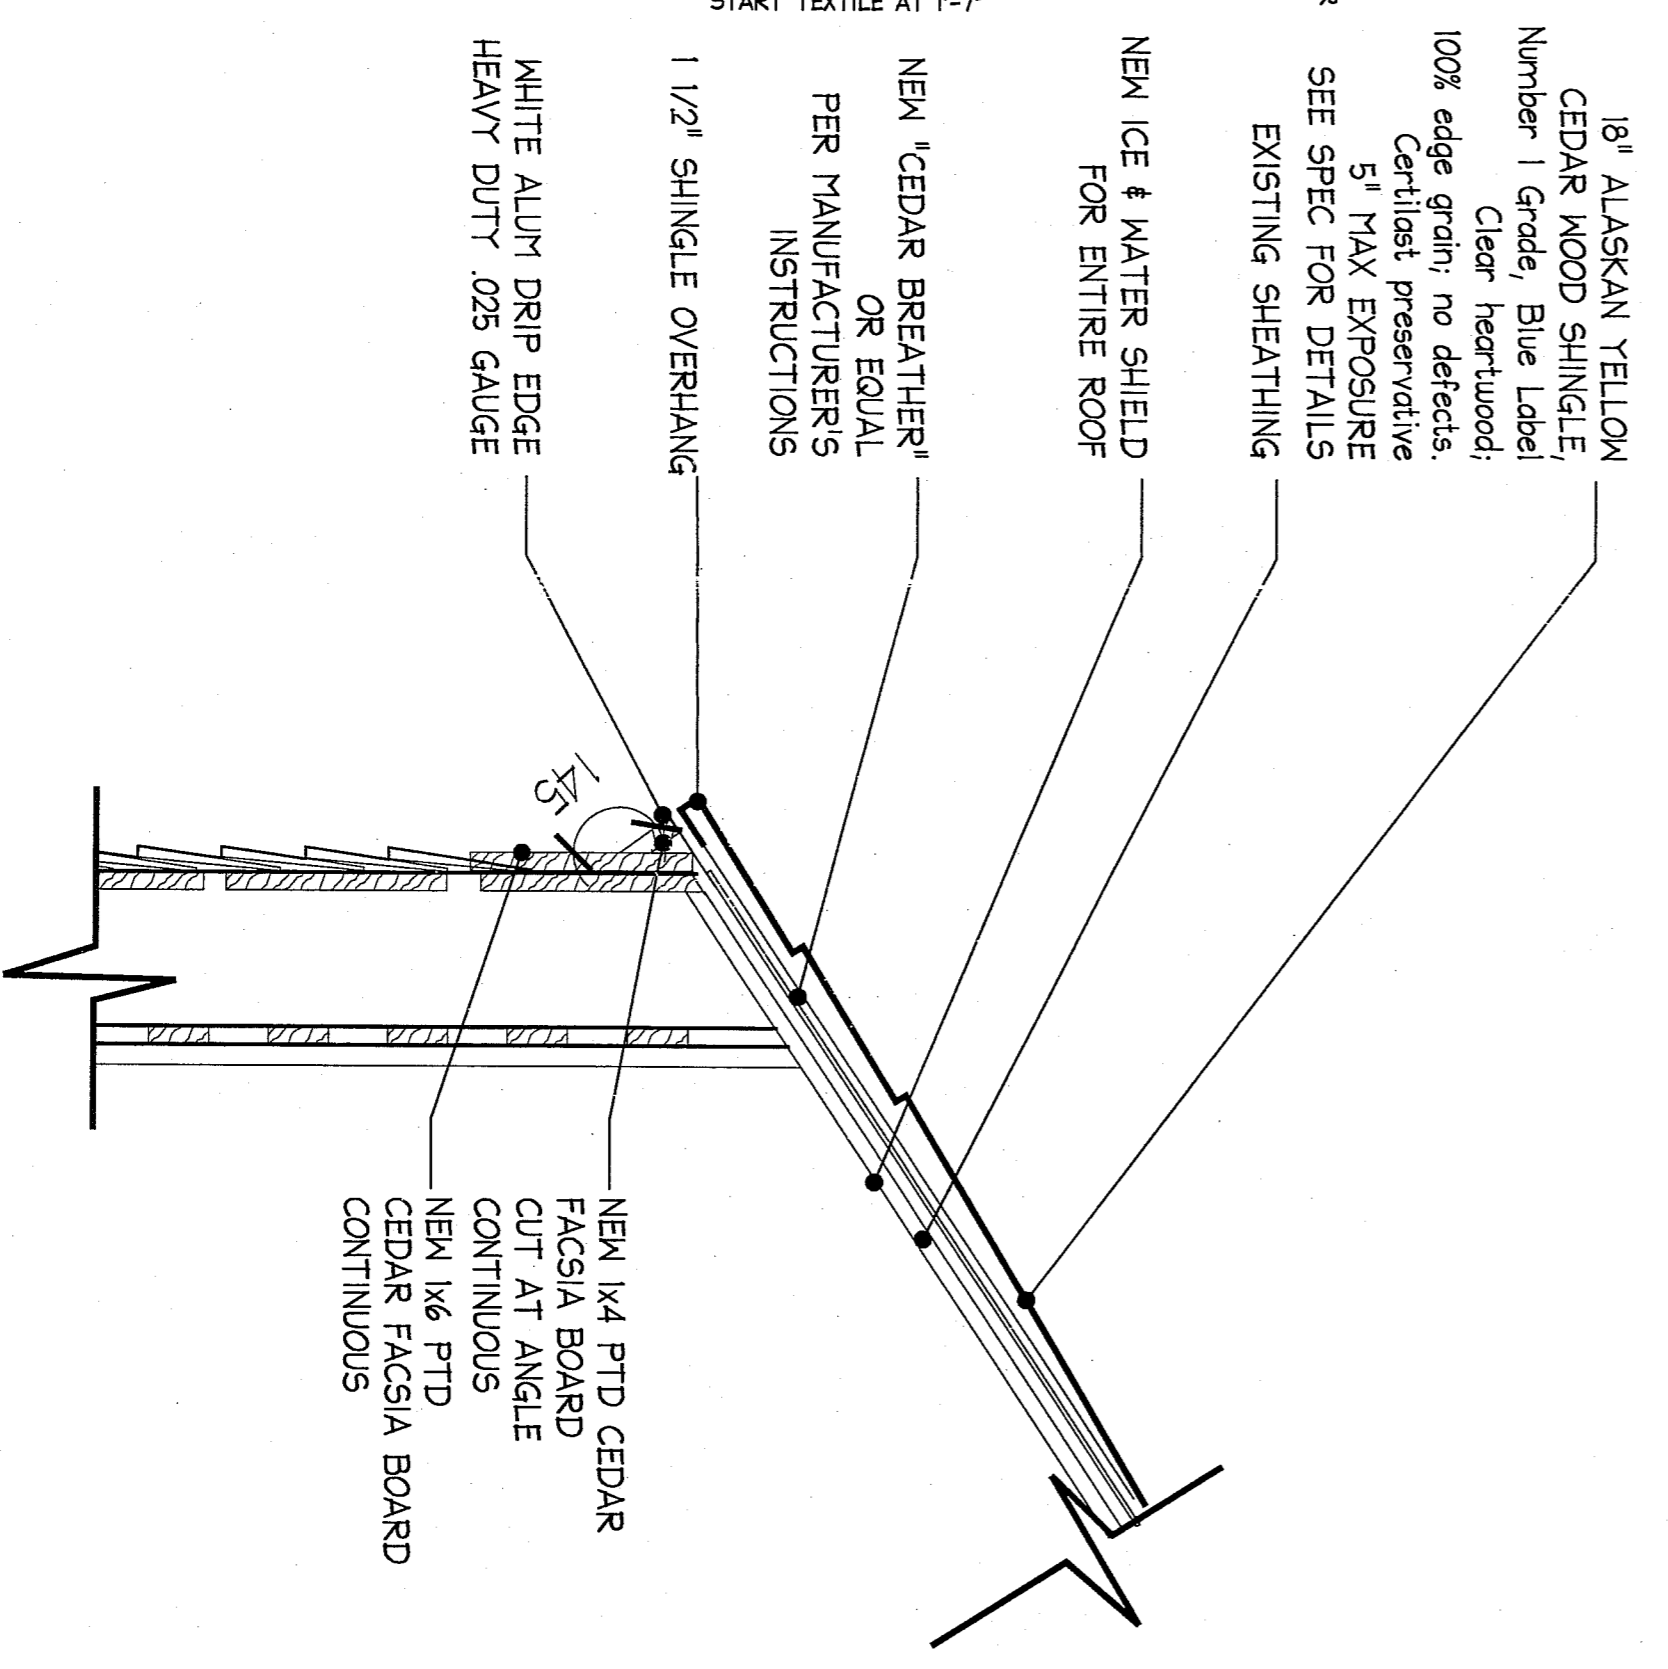


3 SHED ROOF SECTION, TYP.
1 1/2" = 1'-0"

DOOR SCHEDULE						
MARK	SIZE	GLAZING	HARDWARE	NOTES		
	WD	HGT	THK			
01	2'-11"	6'-8"	1 3/4"	EXISTING TRANSOM TO BE REPAIRED TO BRING TO ORIGINAL HISTORICAL CONDITION.		
02	2'-11 3/4"	6'-4 3/4"	1 3/4"	REUSE EXISTING		
03	3'-0"	6'-8"	1 3/4"	REUSE EXISTING L20 IRON HIGHLIGHT EIE-E www.period.com /solutions/iron OR EQUAL		
04	3'-0"	6'-3"	1 3/4"	REUSE EXISTING DOOR TO BE RESTORED. SEE SPEC FOR DETAILS. NEW ADA DOOR. EXISTING OPENING TO BE WIDENED FOR NEW 3'-0" DOOR. FIELD-NEW 7108 Pine Wood Door OR EQUAL PTD.		

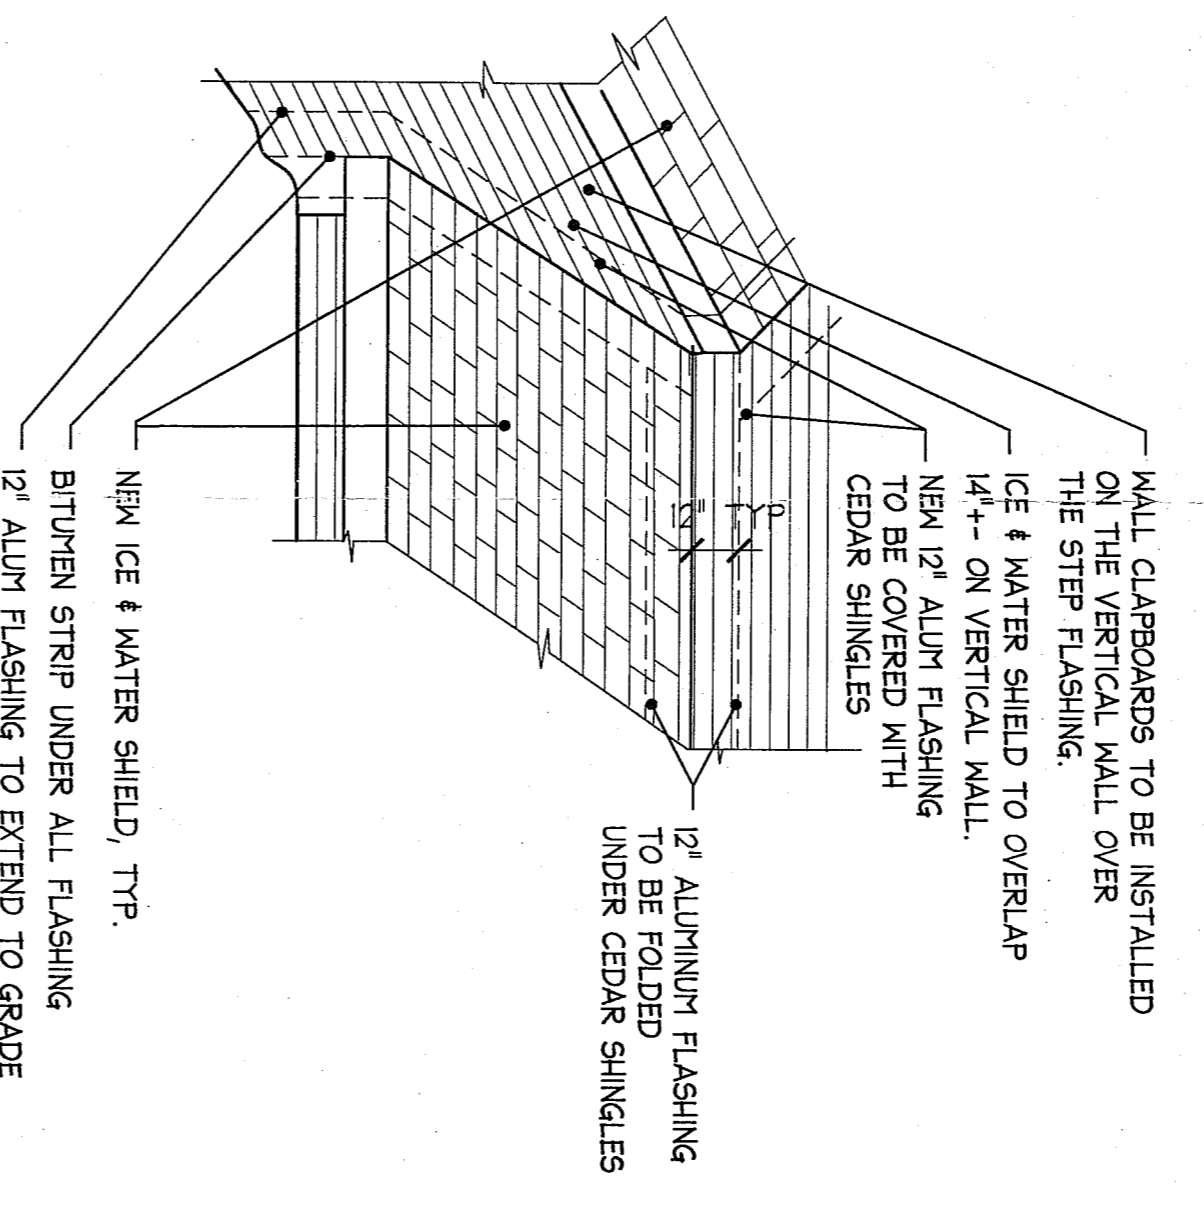

2 ROOF TO SIDEWALL AXONOMETRIC WEST ELEVATION
NTS

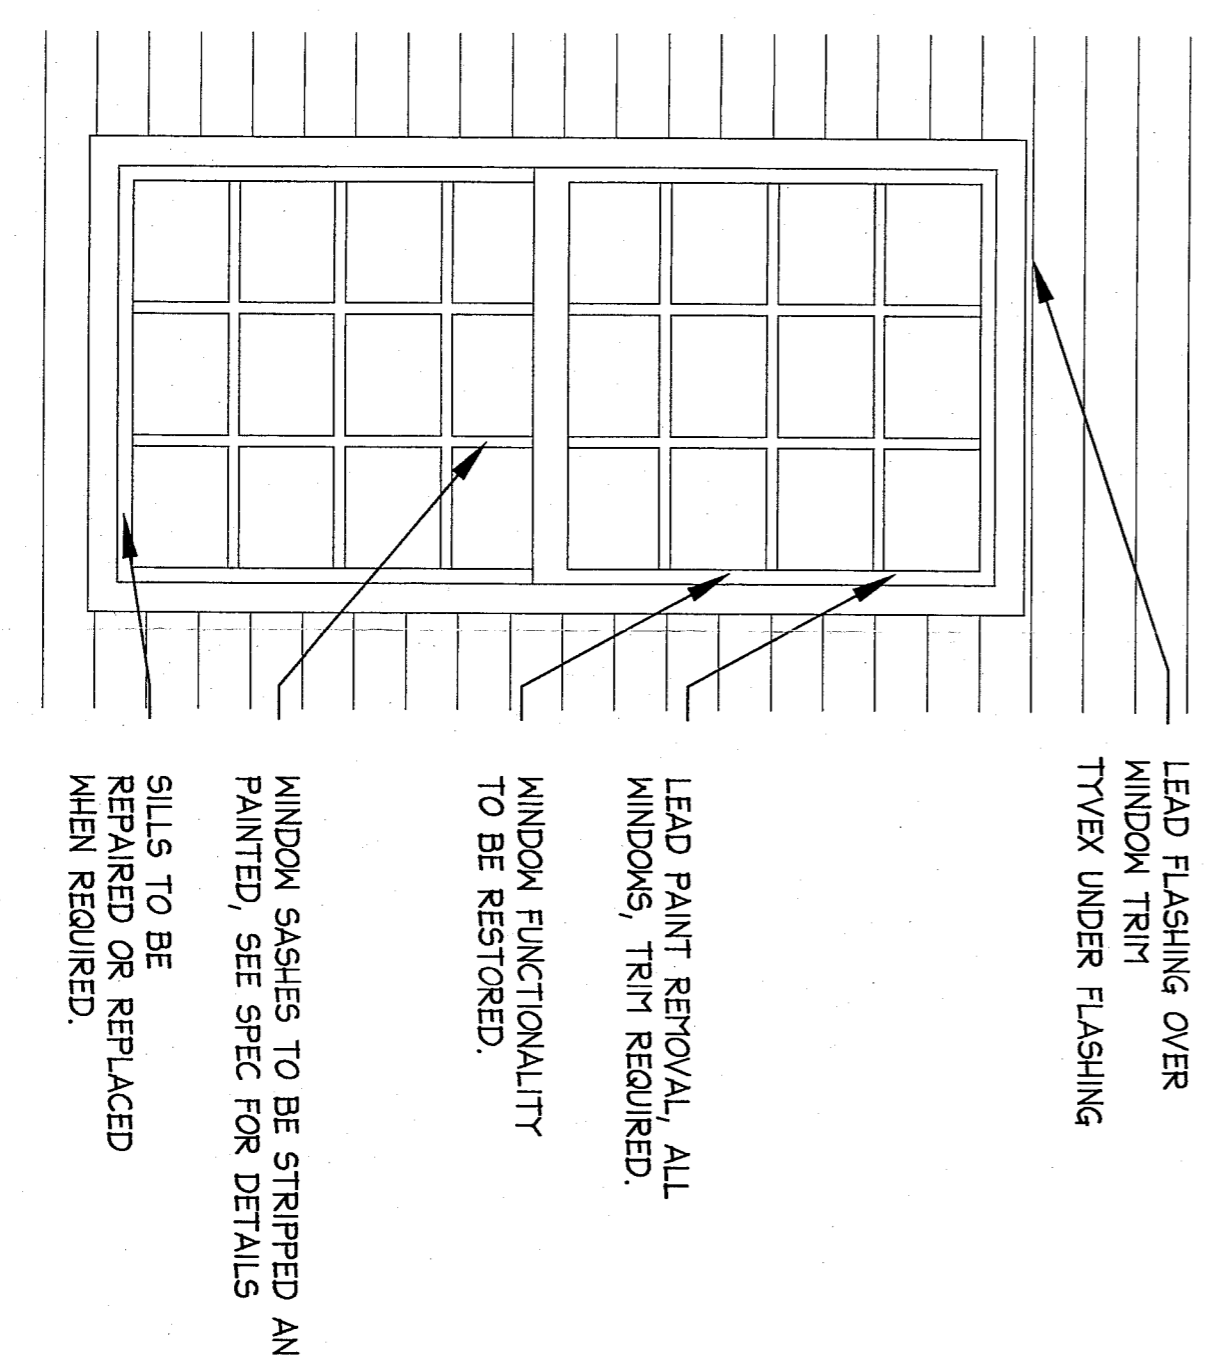


1 TYPICAL WINDOW ELEVATION, (SEE ALT #1)
1" = 1'-0"

NUMBER	DATE	ITEM

DRAWINGS ISSUED TO

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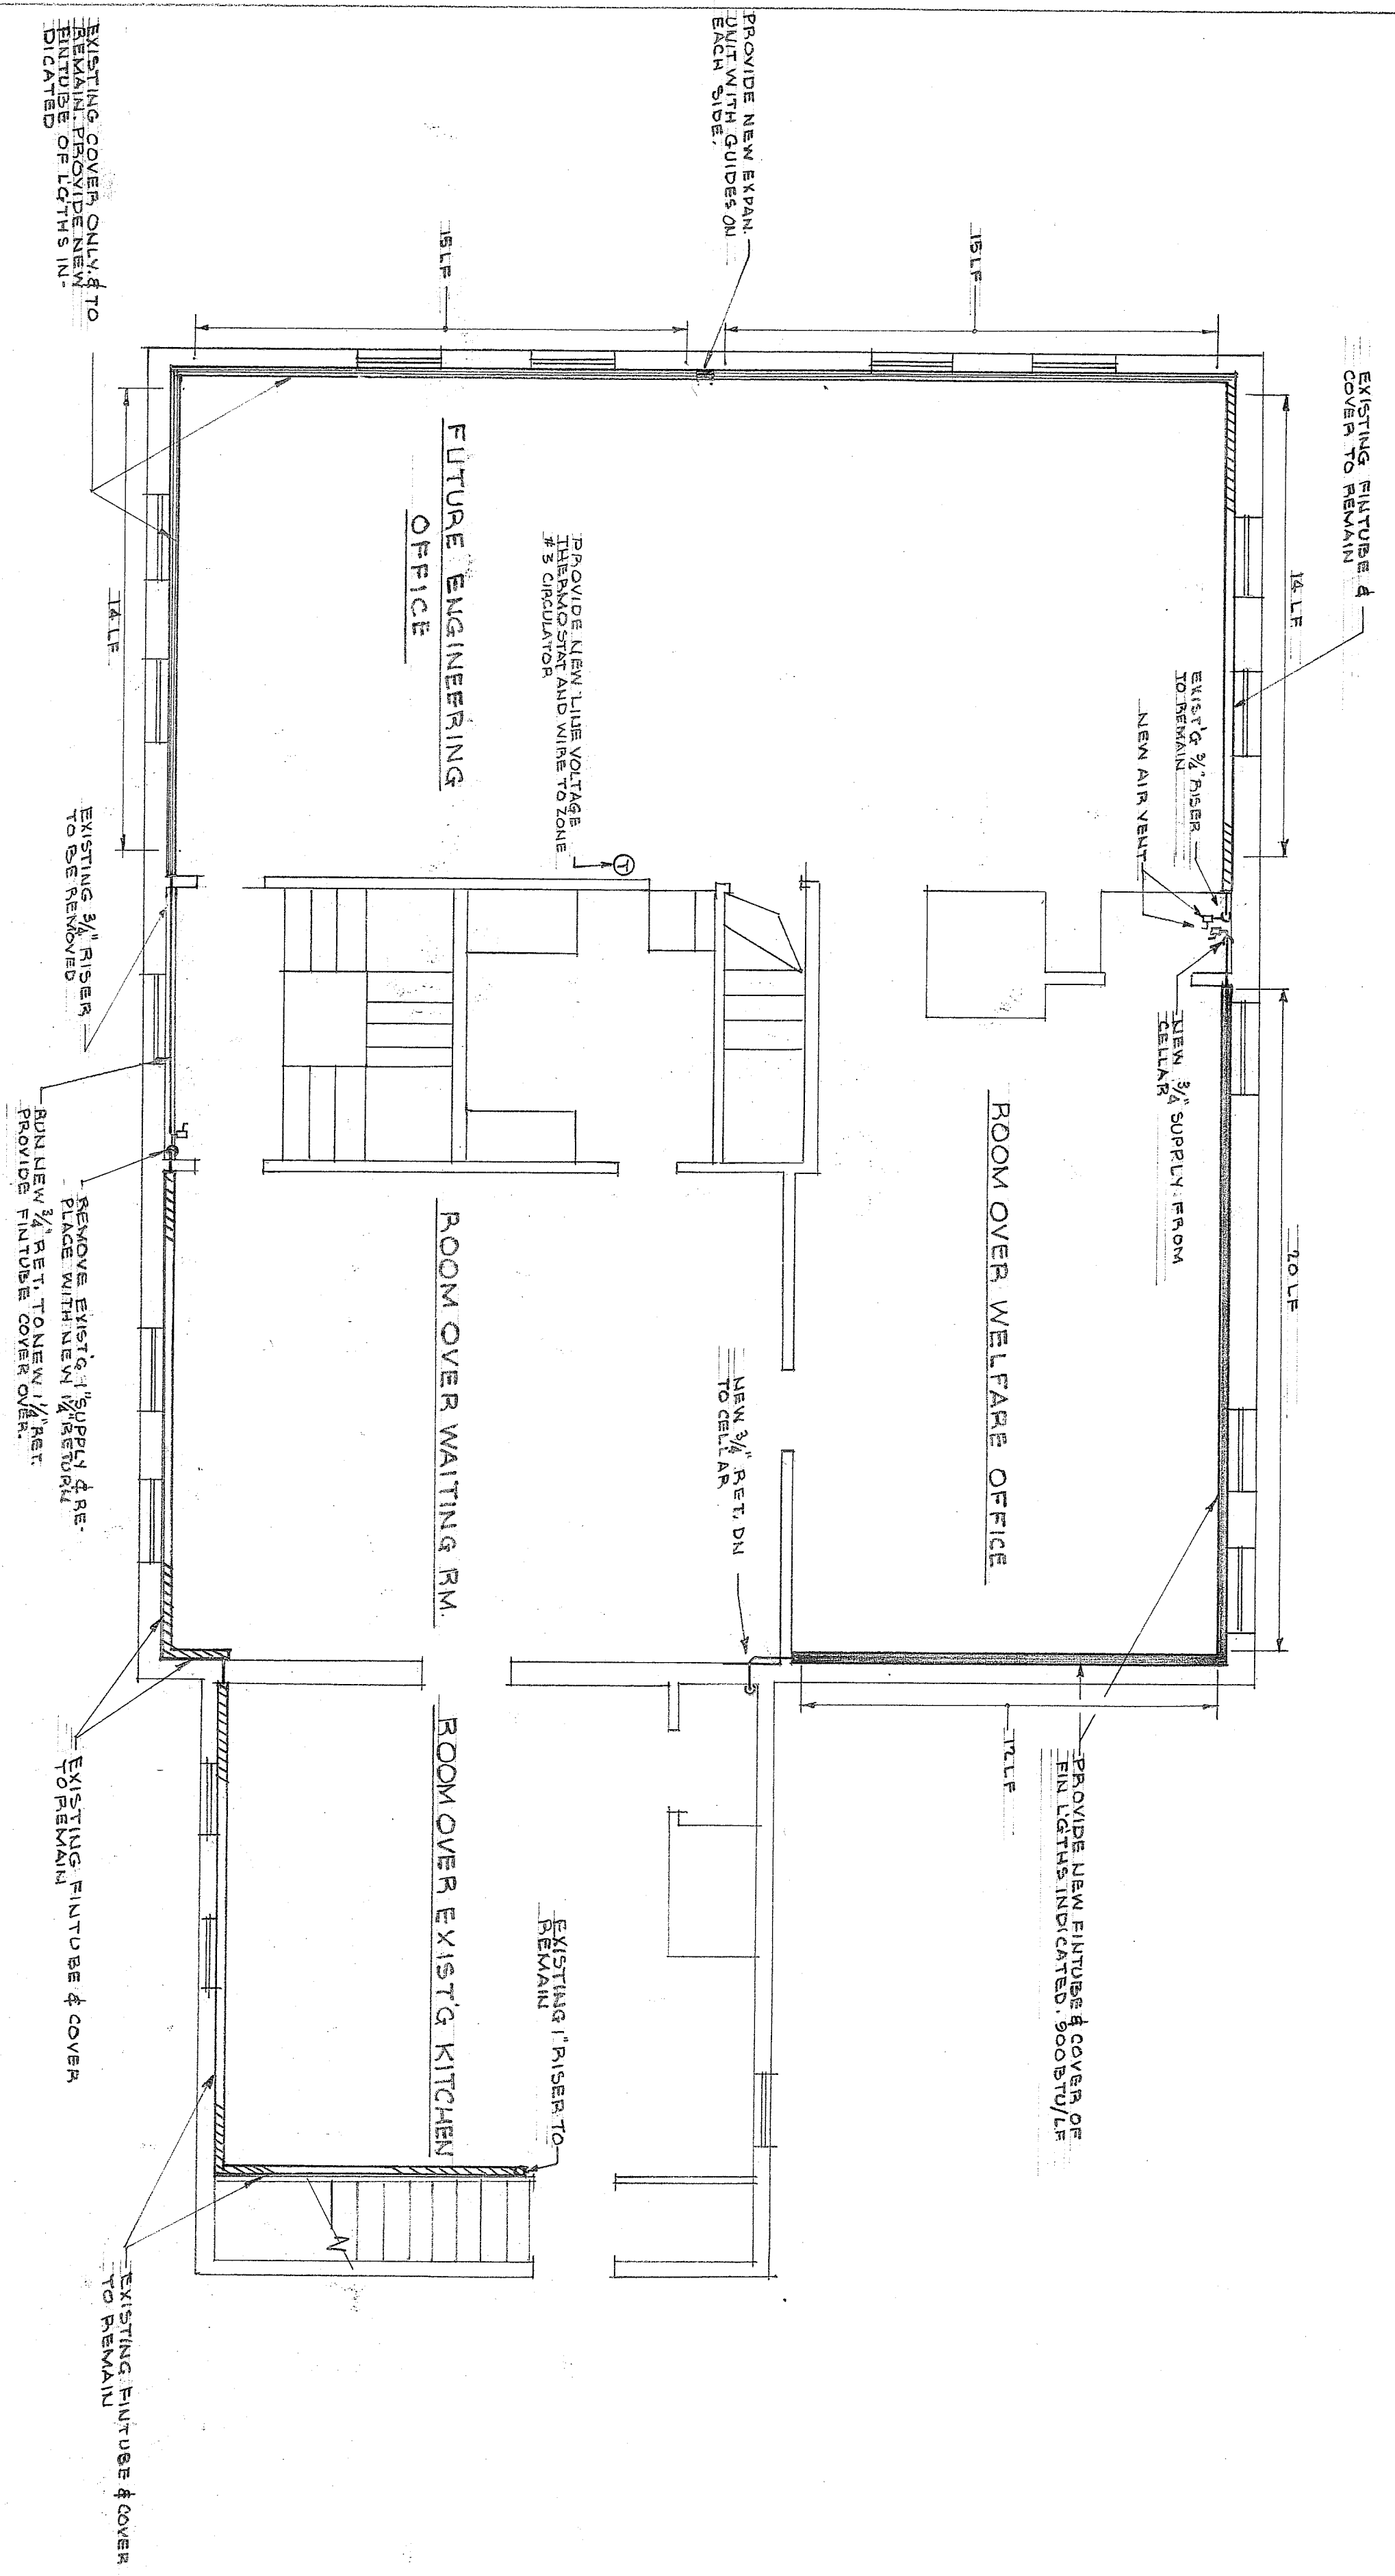

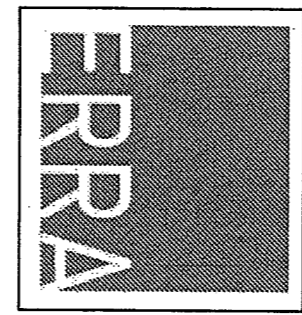
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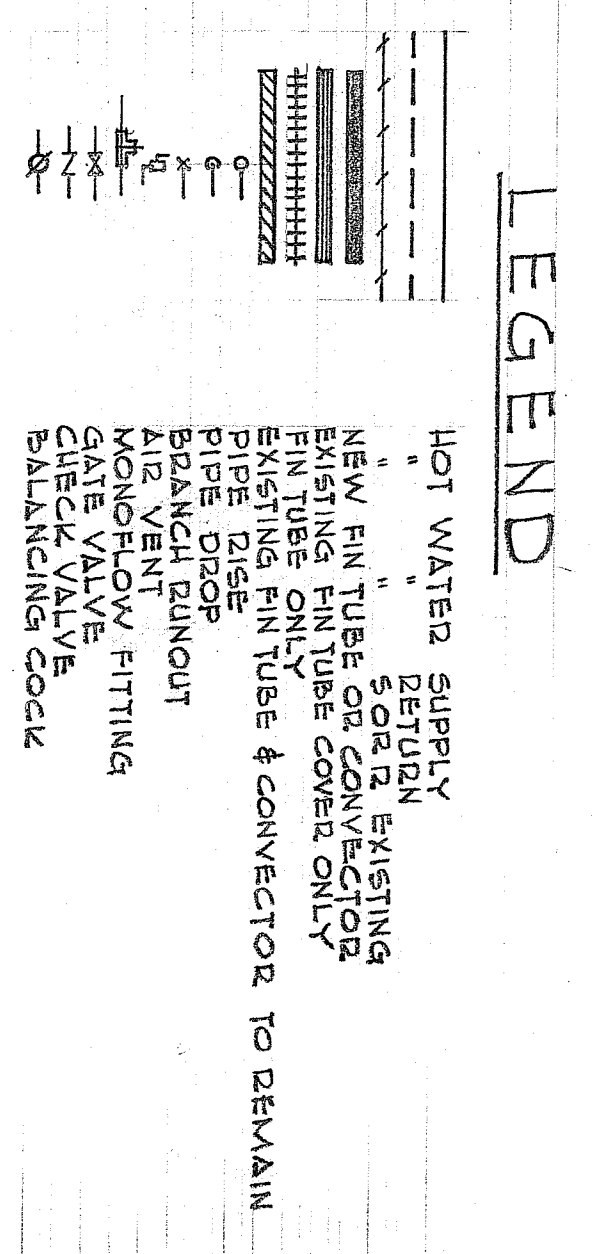
Loring Parsonage
Town of Sudbury
288 Old Sudbury Road
Sudbury, MA 01776

SCHEDULES			
DETAILS			
SHEET TITLE	SCALE	DRAWN BY	JR
	AS SHOWN		
	DATE: 2.25.09	CHECKED BY:	ERR


A3





SECOND FLOOR
PLAN
SCALE: 1/4" = 1'-0"



LORING PARSONAGE

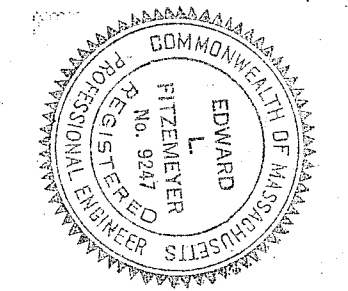

NEW HEATING SYSTEM FOR THE
HAYNES HOUSE - SUDBURY, MASS.
SCALE: AS NOTED DATE: FEB. 21, 1968
CHECKED BY: EIT DATE: DWG. NO. H-1
FITZMEYER & T O C C I, INC.
CONSULTING ENGINEERS BOSTON, MASS.

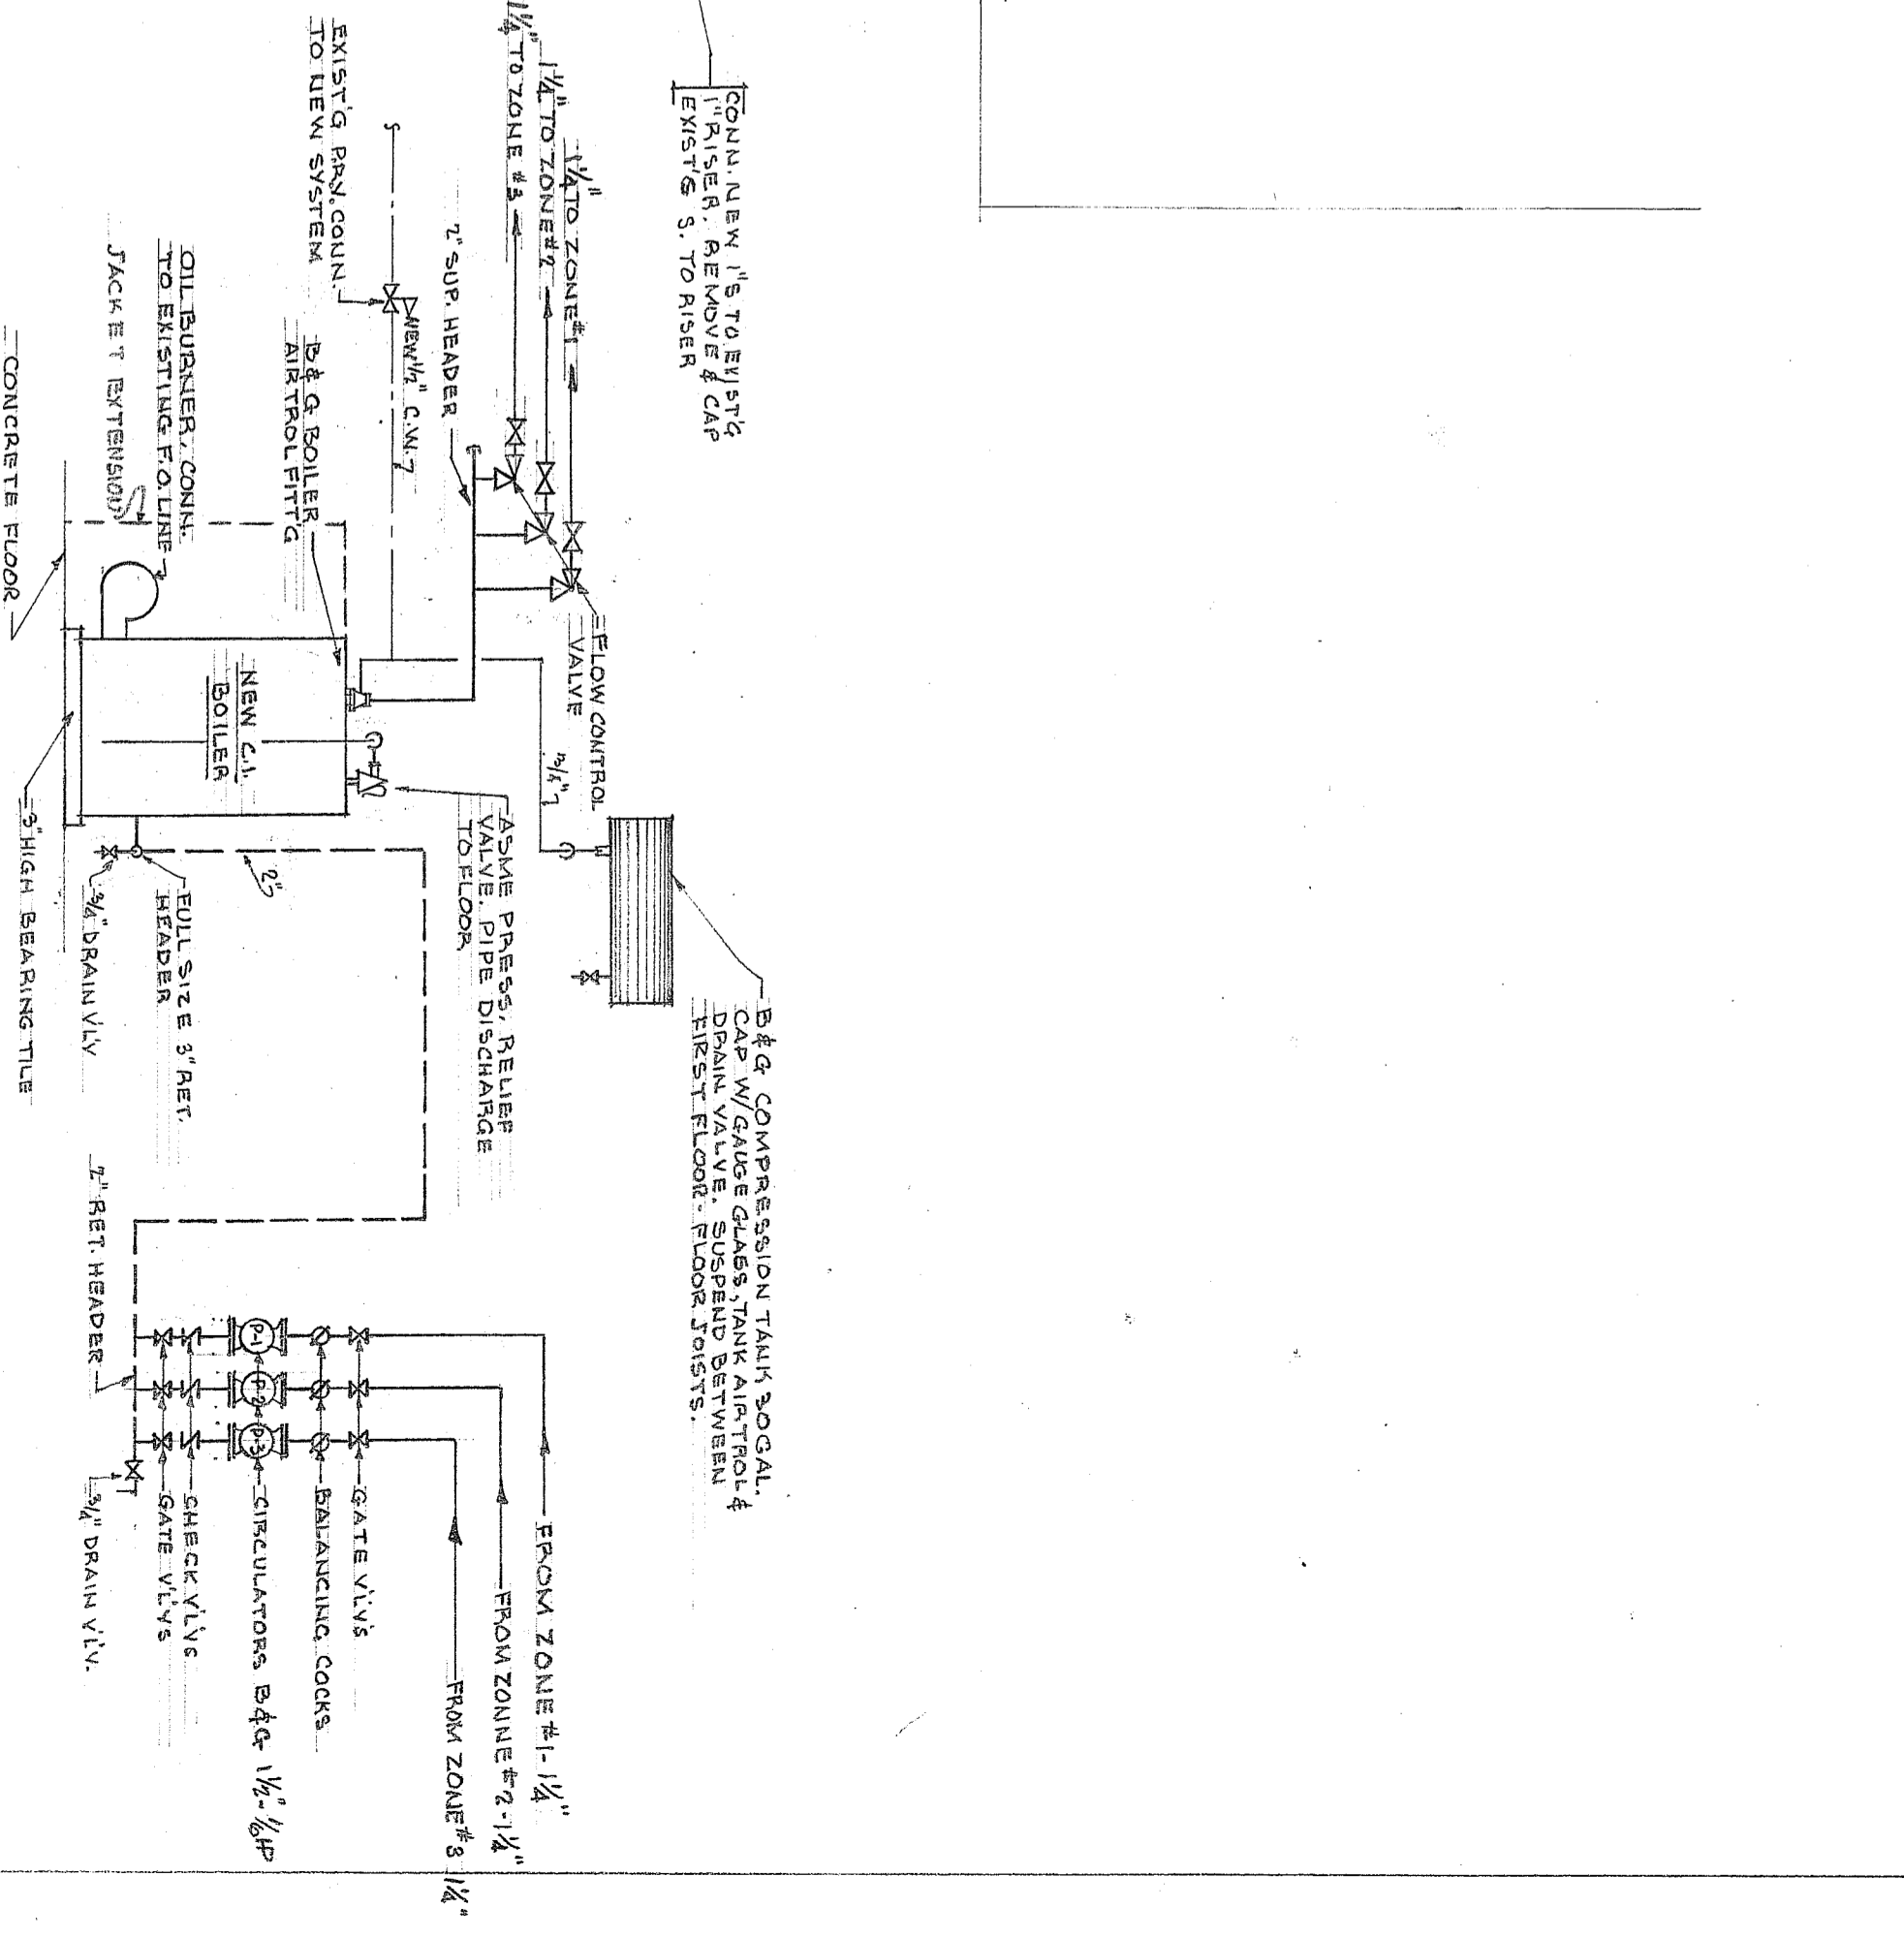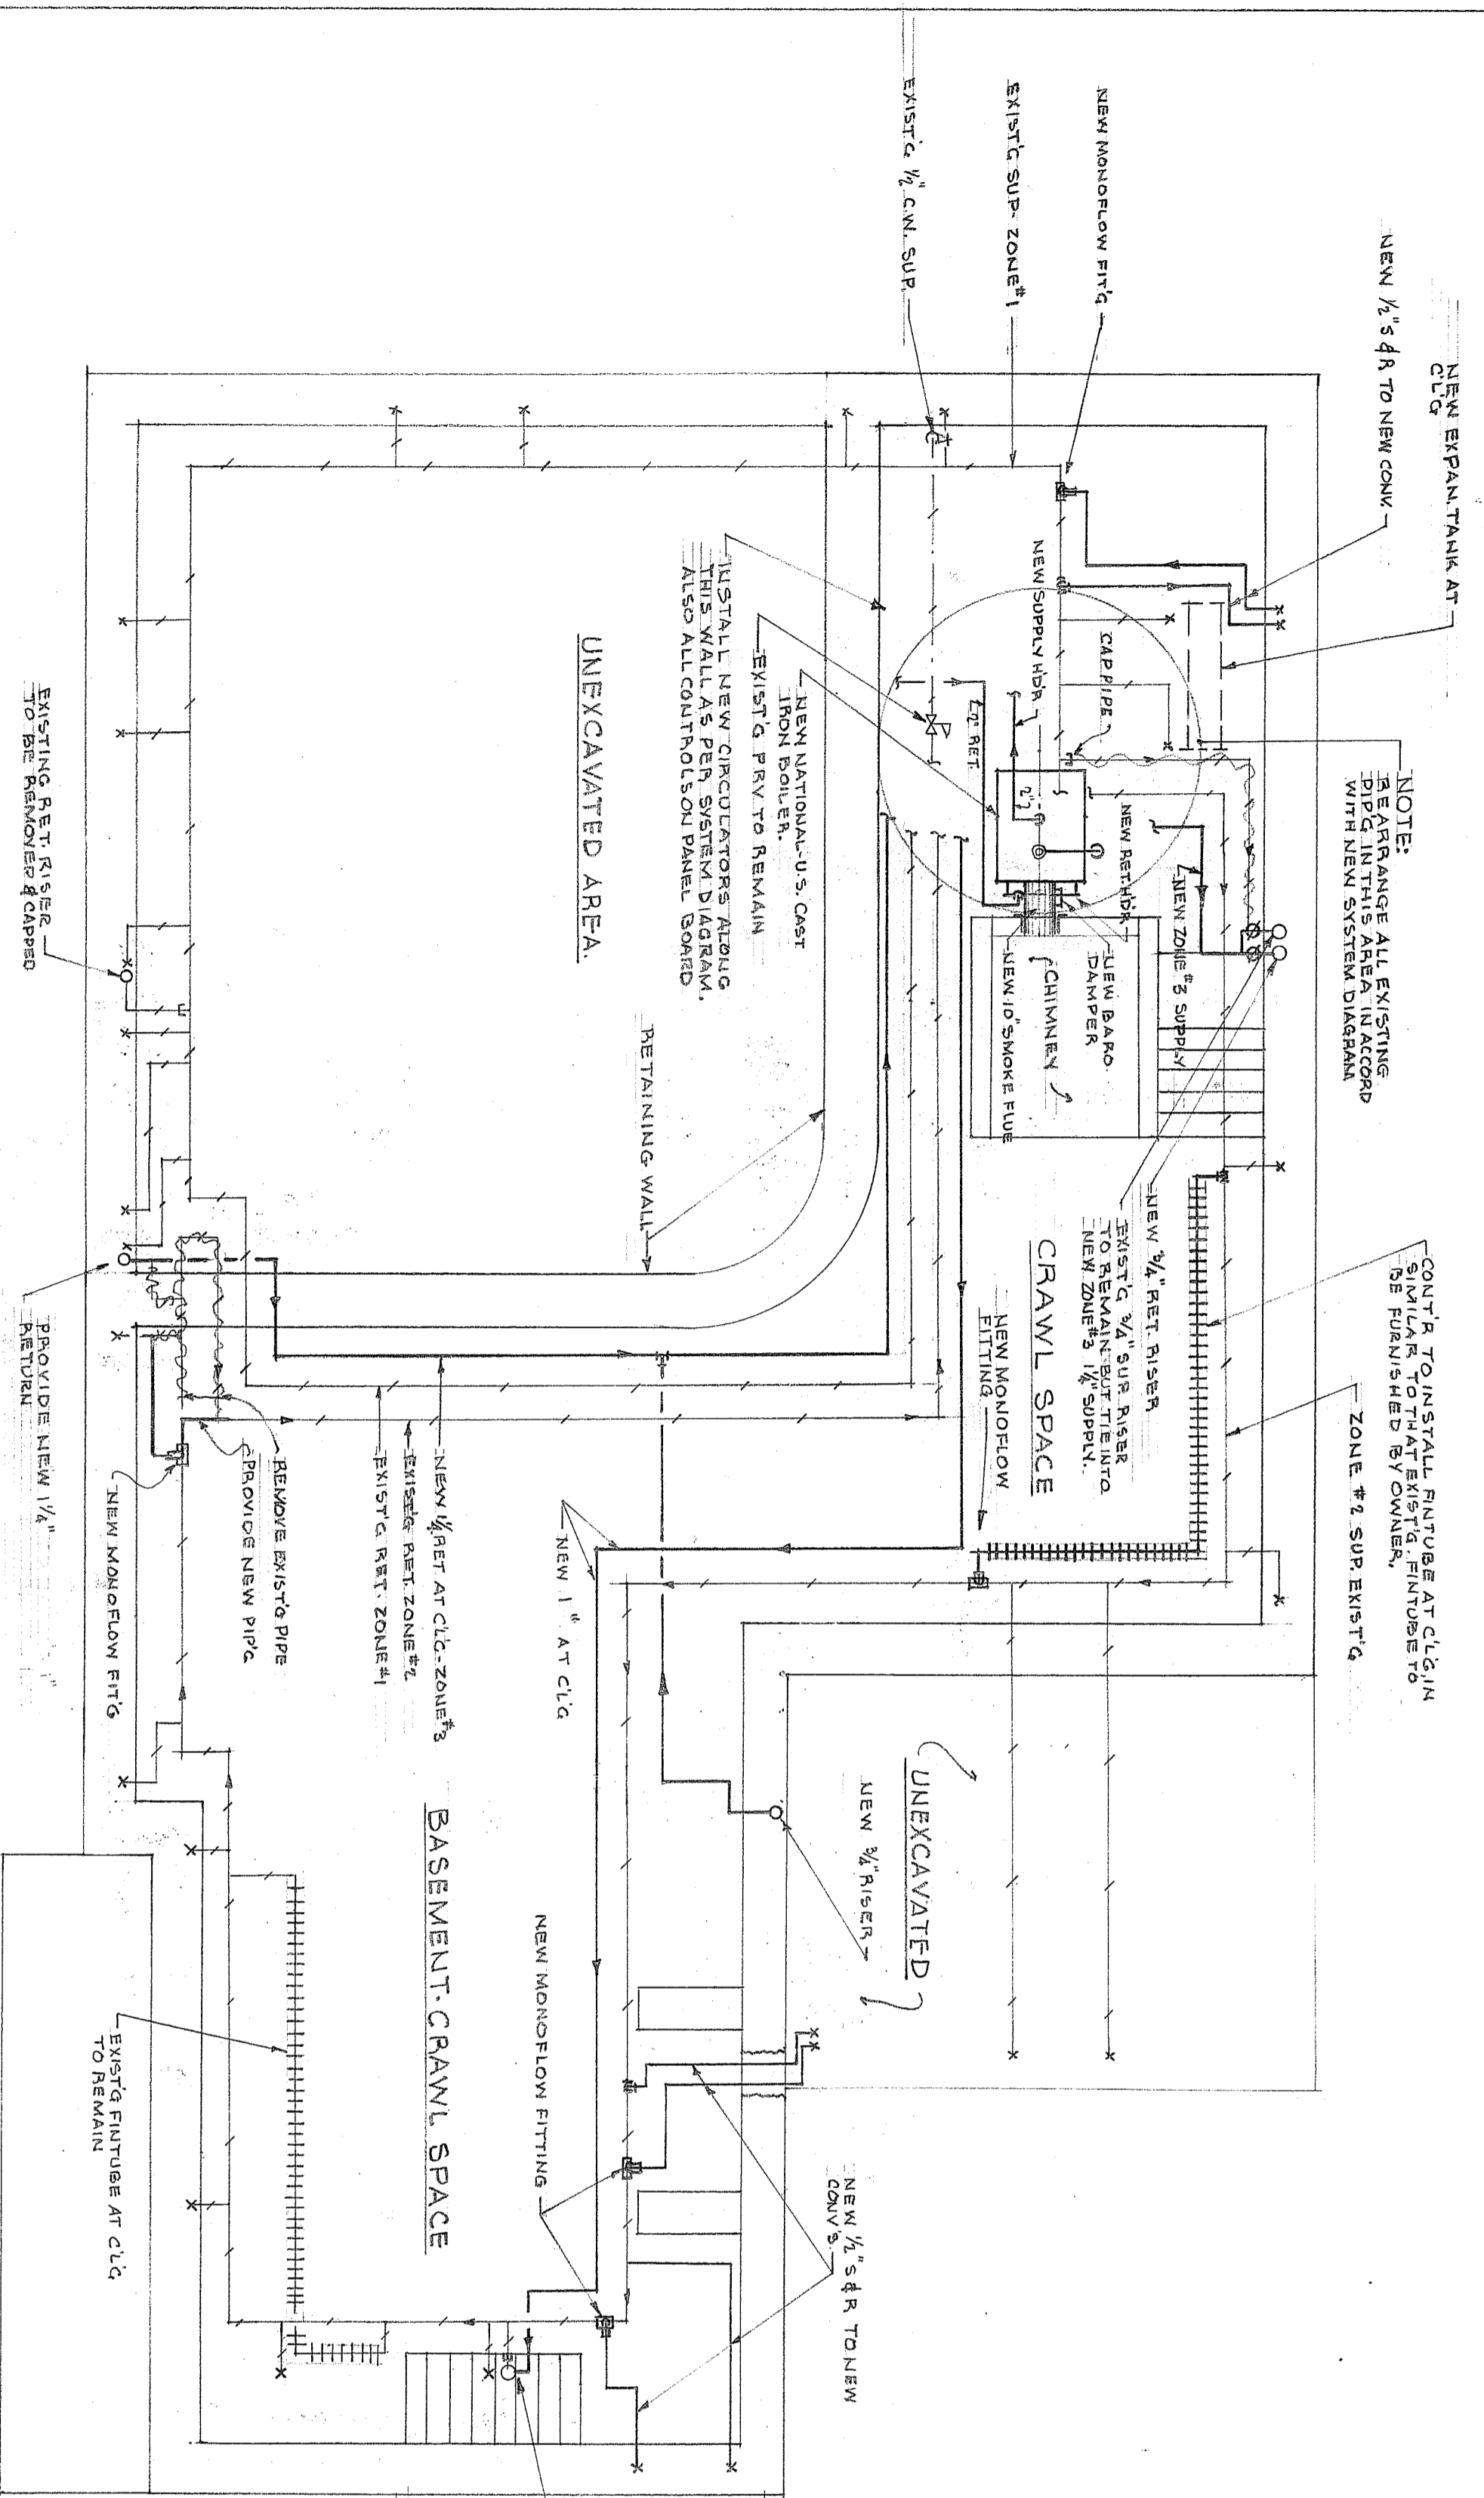

LORING PARSONAGE

NEW HEATING SYSTEM FOR THE
HAYNES HOUSE - SUDBURY, MASS.
SCALE: AS NOTED
CHECKED BY: J.T.
DATE: FEB. 21, 1963
FITZMEYER & TOCCO, INC.
CONSULTING ENGINEERS, BOSTON, MASS.



LORING PARSONAGE

LORING PARSONAGE