

The Sudbury Conservation Commission will hold a public meeting to review the Request for Determination of Applicability filing under the Wetlands Protection Act and the Sudbury Wetlands Administration Bylaw to replace a bridge parapet and guardrails within the 100-foot Buffer Zone, 200-foot Riverfront Area, and Bordering Land Subject to Flooding at Wayside Inn Road, in Sudbury, MA. Daniel Nason, Applicant. The meeting will be held on Monday, August 12, 2024 at 7:00 pm, via Zoom.

Copies of the application may be reviewed on the Conservation Department web page at:

 $\underline{https://sudbury.ma.us/conservationcommission/meeting/conservation-commission-meeting-monday-August-12-2024/}$

Please contact the Conservation Office with any questions at 978-440-5470.

SUDBURY CONSERVATION COMMISSION 7/29/2024

Via E-Mail



7/25/2024

David Henkels Town of Sudbury Conservation Commission 275 Old Lancaster Road Sudbury, MA 01776

Re: Wayside Bridge Repairs - RDA Filing

Dear Mr. Henkels:

On behalf of the Town of Sudbury, Woodard & Curran has prepared the following executive summary in support of the RDA application:

The bridge is located on Wayside Inn Road, just east of Dutton Road. The project is generally described as replacement of a bridge parapet and guardrails; erosion and sedimentation control; other surficial improvements as shown on the plans. The Work shown on the Drawings includes, but is not limited to, the following principal features:

- Installation and maintenance of erosion and sedimentation control measures.
- Removal and disposal of temporary bridge parapet repairs and existing guardrail. Work to be completed from the roadway surface.
- Replacement of bridge parapet as shown on the plans and as directed by the Engineer. Essentially, new guardrail/wall over the bridge structure.
- Furnish and install new guardrails along the edge of road, outside the limits of the bridge structure.
- Other surficial improvements essentially, new line striping on the roadway surface.

Sincerely,

Woodard & Curran, Inc.

Scott Salvucci, P.E.

Senior Client Manager, Vice President

Scoth Salm



Massachusetts Department of Environmental ProtectionBureau of Resource Protection - Wetlands

Sudbury City/Town

WPA Form 1- Request for Determination of Applicability

Massachusetts Wetlands Protection Act M.G.L. c. 131, §40

A. General Information

Important: When filling out 1 forms on the computer, use only the tab key to move your cursor - do not use the return





1.	Applicant:				
	Daniel Nason	nasond@sudbury.ma.us			
	Name	E-Mail Address			
	275 Old Lancaster Road				
	Mailing Address				
	Sudbury	MA	01776		
	City/Town	State	Zip Code		
	978-443-2209	NA			
	Phone Number	Fax Number (if	applicable)		
2.	Representative (if any):				
	Woodard & Curran				
	Firm				
	Scott Salvucci		voodardcurran.com		
	Contact Name	E-Mail Address			
	250 Royall Street, Suite 200E				
	Mailing Address				
	Canton	MA MA	02021		
	City/Town	State	Zip Code		
	781-613-0311	NA			
	Phone Number	Fax Number (if	applicable)		
В.	. Determinations				
1.	I request the Sudbury make the following determination(s). Check any that apply:				
	a. whether the area depicted on plan(s) and/or map(s) referenced below is an area subject to jurisdiction of the Wetlands Protection Act.				
	b. whether the boundaries of resource area(s) depicted on plan(s) and/or map(s) referenced below are accurately delineated.				
	c. whether the work depicted on plan(s) referenced below is subject to the Wetlands Protection Act.				
	d. whether the area and/or work depicted on plan(s) referenced below is subject to the jurisdiction of any municipal wetlands ordinance or bylaw of:				
	Town of Sudbury Name of Municipality				
	 e. whether the following scope of alternatives is ad depicted on referenced plan(s). 	equate for work in the	e Riverfront Area as		



Massachusetts Department of Environmental ProtectionBureau of Resource Protection - Wetlands

Sudbury City/Town

WPA Form 1- Request for Determination of Applicability Massachusetts Wetlands Protection Act M.G.L. c. 131, §40

	C. P	ro	iect	Des	cri	ptio	n
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Wayside Inn Road	Sudbury
Street Address	City/Town
Various-refer to Project Drawings	Various
Assessors Map/Plat Number	Parcel/Lot Number
b. Area Description (use additional paper	, if necessary):
Refer to Figure 1 - Site Location Map and Freplacement of a bridge parapet and guard	Project Drawings. The proposed project includes lrails along Wayside Inn Road.
c. Plan and/or Map Reference(s):	
, , ,	July 2024
c. Plan and/or Map Reference(s): Figure 1 - Site Location Map Title	July 2024 Date
Figure 1 - Site Location Map	
Figure 1 - Site Location Map	Date
Figure 1 - Site Location Map Title Wayside Bridge Repairs Drawings Title	Date April 2024 Date
Figure 1 - Site Location Map Title Wayside Bridge Repairs Drawings	Date April 2024

equipment, servies and construction inherent to the Work, as specified and shown on the Drawings.



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C. Project Description (cont.)

b. Identify provisions of the Wetlands Protection Act or regulations which may exempt the applicant from having to file a Notice of Intent for all or part of the described work (use additional paper, if necessary).

No work is proposed to occur inside of areas specified in 310 CMR 10.02(1)(a-f) under this project. The extent of the work will be limited to the bridge parapet and guardrails. No work will be performed within the wetlands or stream bed.

3.	If this application is a Request for Determination of Scope of Alternatives for work in the erfront Area, indicate the one classification below that best describes the project.
	Single family house on a lot recorded on or before 8/1/96
	Single family house on a lot recorded after 8/1/96
	Expansion of an existing structure on a lot recorded after 8/1/96
	Project, other than a single-family house or public project, where the applicant owned the lot before 8/7/96
	New agriculture or aquaculture project
	Public project where funds were appropriated prior to 8/7/96
	Project on a lot shown on an approved, definitive subdivision plan where there is a recorded deed restriction limiting total alteration of the Riverfront Area for the entire subdivision
	Residential subdivision; institutional, industrial, or commercial project
	Municipal project
	District, county, state, or federal government project
	Project required to evaluate off-site alternatives in more than one municipality in an Environmental Impact Report under MEPA or in an alternatives analysis pursuant to an application for a 404 permit from the U.S. Army Corps of Engineers or 401 Water Quality Certification from the Department of Environmental Protection.
	Provide evidence (e.g., record of date subdivision lot was recorded) supporting the classification ove (use additional paper and/or attach appropriate documents, if necessary.)



Massachusetts Department of Environmental Protection

Bureau of Resource Protection - Wetlands

Name and address of the property owner:

Sudbury City/Town

WPA Form 1- Request for Determination of Applicability

Massachusetts Wetlands Protection Act M.G.L. c. 131, §40

D. Signatures and Submittal Requirements

I hereby certify under the penalties of perjury that the foregoing Request for Determination of Applicability and accompanying plans, documents, and supporting data are true and complete to the best of my knowledge.

I further certify that the property owner, if different from the applicant, and the appropriate DEP Regional Office were sent a complete copy of this Request (including all appropriate documentation) simultaneously with the submittal of this Request to the Conservation Commission.

Failure by the applicant to send copies in a timely manner may result in dismissal of the Request for Determination of Applicability.

Town of Sudbury Department of Public Works	i e
Name	
275 Old Lancaster Road	
Mailing Address	
Sudbury	
City/Town	
MA	01776
State	Zip Code
in accordance with Section 10.05(3)(b)(1) of the V	7/25/2024
Signature of Applicant	Date
Scott Salu	7/24/2024
Signature of Representative (if any)	Date

TOWN OF SUDBURY, MA

PUBLIC WORKS DEPARTMENT

WAYSIDE BRIDGE REPAIRS

ISSUE FOR BID
APRIL 2024










SITE LOCATION MAP

SOURCE: USGS TOPO QUADRANGLE

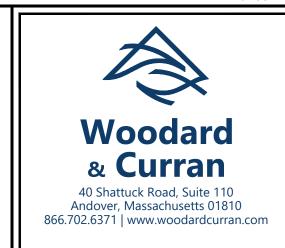

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PE SEAL:

SCUTT C.
SALVUCCI
CIVIL
No. 52343
4/10/2024

***EGISTER

SSONAL ENGINEERING

RESTANCE

ISSUE FOR BID

CLIENT INFO:

TOWN OF SUDBURY MASSACHUSETTS

WAYSIDE BRIDGE REPAIRS

REV MM/DD/YY DESCRIPTION

JOB NO: 0227202.11

DATE: APRIL 2024

SCALE: NONE

DESIGNED BY: KD

DRAWN BY: JBC

CHECKED BY: DS

FILENAME: 0227202.08-G-000.dwg

GENERAL COVER SHEET

DRAWING NO:

- 1. EXISTING CONDITIONS ARE BASED ON A SURVEY PERFORMED BY CHAPPELL ENGINEERING ASSOCIATES, LLC. 201 BOSTON POST ROAD WEST - SUITE 101 MARLBOROUGH, MA 01752. PLAN TITLED, "EXISTING CONDITIONS SURVEY WAYSIDE INN ROAD, SUDBURY, MASSACHUSETTS.", DATED JULY 21, 2021.
- 2. THE HORIZONTAL DATUM DEPICTED ON THE MAPS HEREON IS BASED ON THE MASSACHUSETTS STATE PLANE COORDINATE SYSTEM, MAINLAND ZONE, REFERENCED TO THE NORTH AMERICAN DATUM OF 1983. THE VERTICAL DATUM IS BASED ON THE NORTH AMERICAN VERTICAL DATUM OF 1988 (NAVD 88).
- 3. ANY PROPERTY AND RIGHT OF WAY LOCATIONS THAT MAY BE SHOWN HEREIN ARE APPROXIMATE AND DO NOT REPRESENT A PROPERTY BOUNDARY SURVEY.
- 4. WOODARD & CURRAN ASSUMES NO RESPONSIBILITY FOR DAMAGES INCURRED AS A RESULT OF UTILITIES OMITTED OR INACCURATELY SHOWN.
- 5. COORDINATE CONSTRUCTION ACTIVITY WITH UTILITY COMPANIES, EMERGENCY SERVICES AND TOWN. CONTRACTOR SHALL NOTIFY ALL UTILITIES PRIOR TO COMMENCING WORK, ALLOWING SUFFICIENT TIME TO LOCATE AND MARK THE LOCATION OF BURIED UTILITIES. CONTRACTOR SHALL CONTACT "DIG SAFE", TELEPHONE 811, PRIOR TO EXCAVATION.
- 6. RESTORE ALL AREAS DISTURBED BY CONTRACTOR'S OPERATIONS TO ORIGINAL FINISH (GRAVEL, PAVEMENT, GRASS, ETC.) UNLESS NOTED OTHERWISE ON THE PLANS. RESTORATION OF PAVED SURFACES, GRAVEL SURFACES, DRIVEWAYS, AND LAWNS DAMAGED BY CONSTRUCTION ACTIVITIES SHALL BE PERFORMED AT NO ADDITIONAL COST TO OWNER. ANY CURB DAMAGED BY CONSTRUCTION ACTIVITIES SHALL BE REPLACED IN KIND AND SHALL CONFORM TO TOWN OF SUDBURY AND MASSACHUSETTS DOT SPECIFICATIONS AT NO ADDITIONAL COST TO OWNER.
- 7. PROPERLY PROTECT AND DO NOT DISTURB PROPERTY IRONS AND MONUMENTS. IF DISTURBED, THE PROPERTY MONUMENT SHALL BE RESET AT THE CONTRACTOR'S EXPENSE BY A LICENSED LAND SURVEYOR ACCEPTABLE TO THE TOWN.
- 8. EXISTING FACILITIES (I.E. TREES, JERSEY BARRIERS, STONE, ETC.) SHALL BE REMOVED AND PROTECTED DURING CONSTRUCTION. THE TOWN RETAINS RIGHT TO KEEP ANY AND ALL REMOVED FACILITIES. CONTRACTOR SHALL DISPOSE OF ANY REMOVED FACILITY AT THE REQUEST OF THE TOWN AT NO ADDITIONAL COST TO OWNER.
- 9. ALL TREES NOT NOTED TO BE REMOVED OR RELOCATED SHALL BE PROTECTED BY CONTRACTOR DURING CONSTRUCTION.
- 10. DO NOT PARK, IMPEDE ACCESS TO, OR STORE EQUIPMENT BEYOND LIMIT OF WORK, UNLESS PERMISSION HAS BEEN GRANTED IN WRITING BY TOWN AND/OR LAND OWNER.
- 11. RESTRICT ACCESS TO SITE THROUGH THE USE OF APPROPRIATE SIGNAGE, BARRIERS, FENCES, ETC. SITE SHALL BE LEFT WITH APPROPRIATE SAFETY MEASURES IN PLACE DURING NON-WORKING HOURS. SITE SAFETY IS THE RESPONSIBILITY OF CONTRACTOR, DURING BOTH WORKING AND NON-WORKING
- 12. CONTRACTOR IS RESPONSIBLE FOR OBTAINING ALL NECESSARY CONSTRUCTION PERMITS INCLUDING "PERMIT TO CONSTRUCT WITHIN A PUBLIC WAY" FROM THE TOWN. PERMIT APPLICATIONS SHALL BE SUBMITTED WITH ADEQUATE TIME SO AS NOT TO DELAY CONSTRUCTION.
- 13. ALL WORK ASSOCIATED WITH THE PROJECT SHALL BE COMPLETED IN ACCORDANCE WITH THE TOWN OF SUDBURY BYLAW AND LOCAL REGULATIONS AND MASSACHUSETTS DOT STANDARD SPECIFICATIONS.
- 14. UPON COMPLETION OF CONSTRUCTION, A COMPLETE SET OF "RECORD" DRAWINGS SHALL BE SUBMITTED TO THE TOWN ENGINEER. THESE DRAWINGS SHALL BE SUBMITTED IN BOTH DIGITAL AND HARD COPY FORMAT AS DEFINED IN THE SPECIFICATIONS PRIOR TO PAYMENT OF FINAL RETAINAGE.
- 15. PROTECTION OF EXISTING UTILITIES DURING CONSTRUCTION SHALL BE PROVIDED AT NO ADDITIONAL
- 16. CONTRACTOR SHALL BE RESPONSIBLE FOR SWEEPING WAYSIDE INN ROAD EVERY FRIDAY AND AS NECESSARY DURING THE DURATION OF THE WORK.
- 17. PRIOR TO CONSTRUCTION, CONTRACTOR SHALL ATTEND A PRE-CONSTRUCTION MEETING HELD AT THE PROJECT SITE WITH THE CONTRACTOR, ENGINEER, AND OWNER TO REVIEW THE CONSTRUCTION SCHEDULE AND SEQUENCING, STOCKPILE LOCATIONS AND CRITICAL ASPECTS OF THE PROJECT.
- 18. ALL DISTURBED UPLAND AREAS SHALL BE BROUGHT TO FINAL GRADE AND SHALL BE PERMANENTLY STABILIZED WITHIN 30 DAYS AFTER DISTURBANCE. BARE GROUND AND DISTURBED AREAS THAT CANNOT BE PERMANENTLY VEGETATED WITHIN 30 DAYS SHALL BE TEMPORARY STABILIZED BY AN APPROVED
- 19. CONTRACTOR SHALL DEMARCATE CONSTRUCTION EQUIPMENT AND MATERIAL STORAGE AREAS PRIOR TO CONSTRUCTION.
- 20. THE CONSTRUCTION SITE SHALL BE MAINTAINED IN CLEAN CONDITIONS AT ALL TIMES AND CONSTRUCTION REFUSE AND DEBRIS SHALL BE DISPOSED OF PROMPTLY AND IN A LEGAL MANNER.
- 21. STORING, SERVICING, OR CLEANING OF TRUCKS OR EQUIPMENT SHALL BE PERFORMED IN AN UPLAND AREA AT A HORIZONTAL DISTANCE GREATER THAN 100 FEET FROM THE WATERBURY AND ASSOCIATED RESOURCE AREAS.

EROSION CONTROL NOTES

- 22. EROSION CONTROL DEVICES SHALL REMAIN IN PLACE, UNTIL ALL DISTURBED SURFACES HAVE BEEN STABILIZED WITH FINAL VEGETATION COVER OR THE OWNER HAS AUTHORIZED THEIR REMOVAL.
- 23. EROSION CONTROL MEASURES AND BARRIERS SHALL BE MONITORED DAILY AND MAINTAINED, OR REINFORCED AS NECESSARY TO ENSURE AND PREVENT EROSION AND SILTATION OF SOILS TO WETLAND RESOURCE AREAS. ADDITIONAL FILTER FABRIC AND STRAW WATTLES SHALL BE STORED ON SITE FOR EMERGENCY USE.
- 24. DURING ALL PHASES OF CONSTRUCTION, ALL DISTURBED OR EXPOSED AREAS OUTSIDE THE ROADWAY SHALL BE BROUGHT TO FINISHED GRADE AND EITHER A) LOAMED AND SEEDED FOR PERMANENT STABILIZATION, IN ACCORDANCE WITH U.S. SOIL CONSERVATION SERVICE PROCEDURES, OR B) STABILIZED IN ANOTHER WAY APPROVED BY THE COMMISSION. AREAS THAT CANNOT BE PERMANENTLY STABILIZED WITHIN 30 DAYS OF DISTURBANCE SHALL BE STABILIZED WITH HAY, STRAW, MULCH OR ANY OTHER PROTECTIVE COVERING AND/OR METHOD APPROVED BY THE U.S. DEPARTMENT OF AGRICULTURE SOIL CONSERVATION SERVICE OR BY OTHER TEMPORARY MEASURES ACCEPTABLE TO THE COMMISSION.
- 25. AN ADEQUATE STOCKPILE OF EROSION AND SEDIMENTATION CONTROL MATERIALS SHALL BE ON SITE AT ALL TIMES FOR EMERGENCY OR ROUTINE REPLACEMENT.
- 26. ANY DAMAGE CAUSED AS A DIRECT RESULT OF CONSTRUCTION TO THE RESOURCE AREAS SHALL BE REPAIRED, RESTORED AND/OR REPLACED. SEDIMENTATION OR EROSION SHALL BE CONSIDERED DAMAGE TO THE RESOURCE AREAS. IF SEDIMENTATION REACHES THESE AREAS, THE CONSERVATION COMMISSION SHALL BE CONTACTED AND A PLAN FOR THE PROPOSED RESTORATION SHALL BE SUBMITTED FOR
- 27. THE SILT FENCE AND STRAW BALES MUST BE INSPECTED PRIOR TO THE START OF ANY WORK OR A \$100 PER DAY FINE WILL BE LEVIED ON THE CONTRACTOR.

ABBREVIATIONS

GRAN.

HDPE

HYD

INV.

N.T.S.

LLS

DESCRIPTION

PROP.

MASSDEP

AND

GAS SERVICE

GALVANIZED

HIGH DENSITY POLYETHYLENE

HIGH DENSITY POLYPROPYLENE

MASSACHUSETTS DEPARTMENT OF

GRANITE

HYDRANT

INVERT

LINEAR FEET

NOT TO SCALE

PLUS OR MINUS

OVERHEAD

PROPOSED

OVERHEAD ELECTRIC

LICENSED LAND SURVEYOR

A.G.	ABOVE GROUND	
BIT B/W BVW	BITUMINOUS BETWEEN BORDERING VEGETATED WETLAND	SHEET INDEX
СВ	CATCH BASIN	GENERAL
CI CMP	CAST IRON CORRUGATED METAL PIPE	G-000 COVER SHEET
CONC	CONCRETE	G-001 GENERAL NOTES, LEGEND, AND ABBREVIATIONS
D DI	STORM DRAIN DUCTILE IRON	CIVIL
DIA. DMH	DIAMETER DRAIN MANHOLE	C-100 EXISTING CONDITIONS
DOT	DEPARTMENT OF TRANSPORTATION	C-200 SITE PLAN
DTL. DYL	DETAIL DOUBLE YELLOW LINE	C-300 CIVIL DETAILS - 1
E	UNDERGROUND ELECTRICAL	C-301 CIVIL DETAILS - 2
EL. E.O.P. EXIST.	ELEVATION EDGE OF PAVEMENT EXISTING	STRUCTURAL
FF	FINISH FLOOR	S-101 WAYSIDE INN BRIDGE REPAIRS SITE PLAN, NOTES, EXISTING CONDITIONS, AND DEMOLITION PLAN
FT	FOOT/FEET	S-102 WAYSIDE INN BRIDGE REPAIRS PROPOSED PLAN AND SECTION
G	GAS MAIN	S-103 WAYSIDE INN BRIDGE REPAIR PLAN & SECTION

RESOURCE AREA LEGEND

	ENVIRONMENTAL PROTECTION	BORDERING LAND SUBJECT TO FLOODING
MADOT	MASSACHUSETTS DEPARTMENT OF	(100 YEAR FLOOD ZONE, DEFINED BY FEMA)
	TRANSPORTATION	
MAX.	MAXIMUM	
MIN.	MINIMUM	
MON	MONUMENT	<u>NOTE</u> :
N.I.C.	NOT IN CONTRACT	A RESOURCE AREA DELINEATION WAS NOT CONDUCTED AS PART OF THIS PROJECT.
NO.	NUMBER	PROJECT.
NR	NO REFUSAL	

LINE TYPES & HATCHES


PT. PVC	POINT POLYVINYL CHLORIDE	DESCRIPTION	<u>EXISTING</u>	PROPOSED
R.O.W.	RIGHT-OF-WAY	CONTOUR (1' INTERVAL)		
RCP	REINFORCED CONCRETE PIPE	CONTOUR (INDEX)		
REINF. REQ'D	REINFORCED REQUIRED	EDGE OF PAVEMENT		
RPP	RIBBED PLASTIC PIPE	OVERHEAD ELECTRIC	OE	
S	SLOPE (FT./FT.)	UNDERGROUND GAS	G	
S SMH	SEWER SEWER MANHOLE	RIGHT OF WAY/ PROPERTY LI	NE	
SCH STA.	SCHEDULE STATION	GUARDRAIL		
SWL	SINGLE WHITE LINE	LIMIT OF WORK		LW
TOWN	TOWN OF SUDBURY	SEDIMENT BARRIER		
TYP.	TYPICAL	SAWCUT		
UNO	UNLESS NOTED OTHERWISE	STONE WALL	·	
UP	UTILITY POLE	DOUBLE YELLOW LINE		
VC	VITRIFIED CLAY	SINGLE WHITE LINE		

CENTERLINE

SYMBOLS

WITH

DESCRIPTION	<u>EXISTING</u>	<u>PROPOSED</u>
PK NAIL		
UTILITY POLE	ø	
TREE/STUMP		
SIGN	- 0-	
STEEL POST		-
CONCRETE ANCHOR		
BRIDGE PARAPIT		
STEEL BACKED TIMBER GAURDRAIL		- i i
TEMPORARY BARRIER		

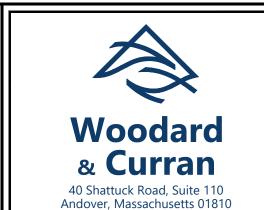

866.702.6371 | www.woodardcurran.com

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ISSUE FOR BID

TOWN OF SUDBURY **MASSACHUSETTS**


WAYSIDE BRIDGE REPAIRS


REV MM/DD/YY DESCRIPTION 0227202.11

APRIL 2024 SCALE: NONE DESIGNED BY: KD DRAWN BY: CHECKED BY: DS II FNAMF 0227202.08-G-001.dwa

DRAWING TITLE: **GENERAL**


GENERAL NOTES, LEGEND, AND ABBREVIATIONS

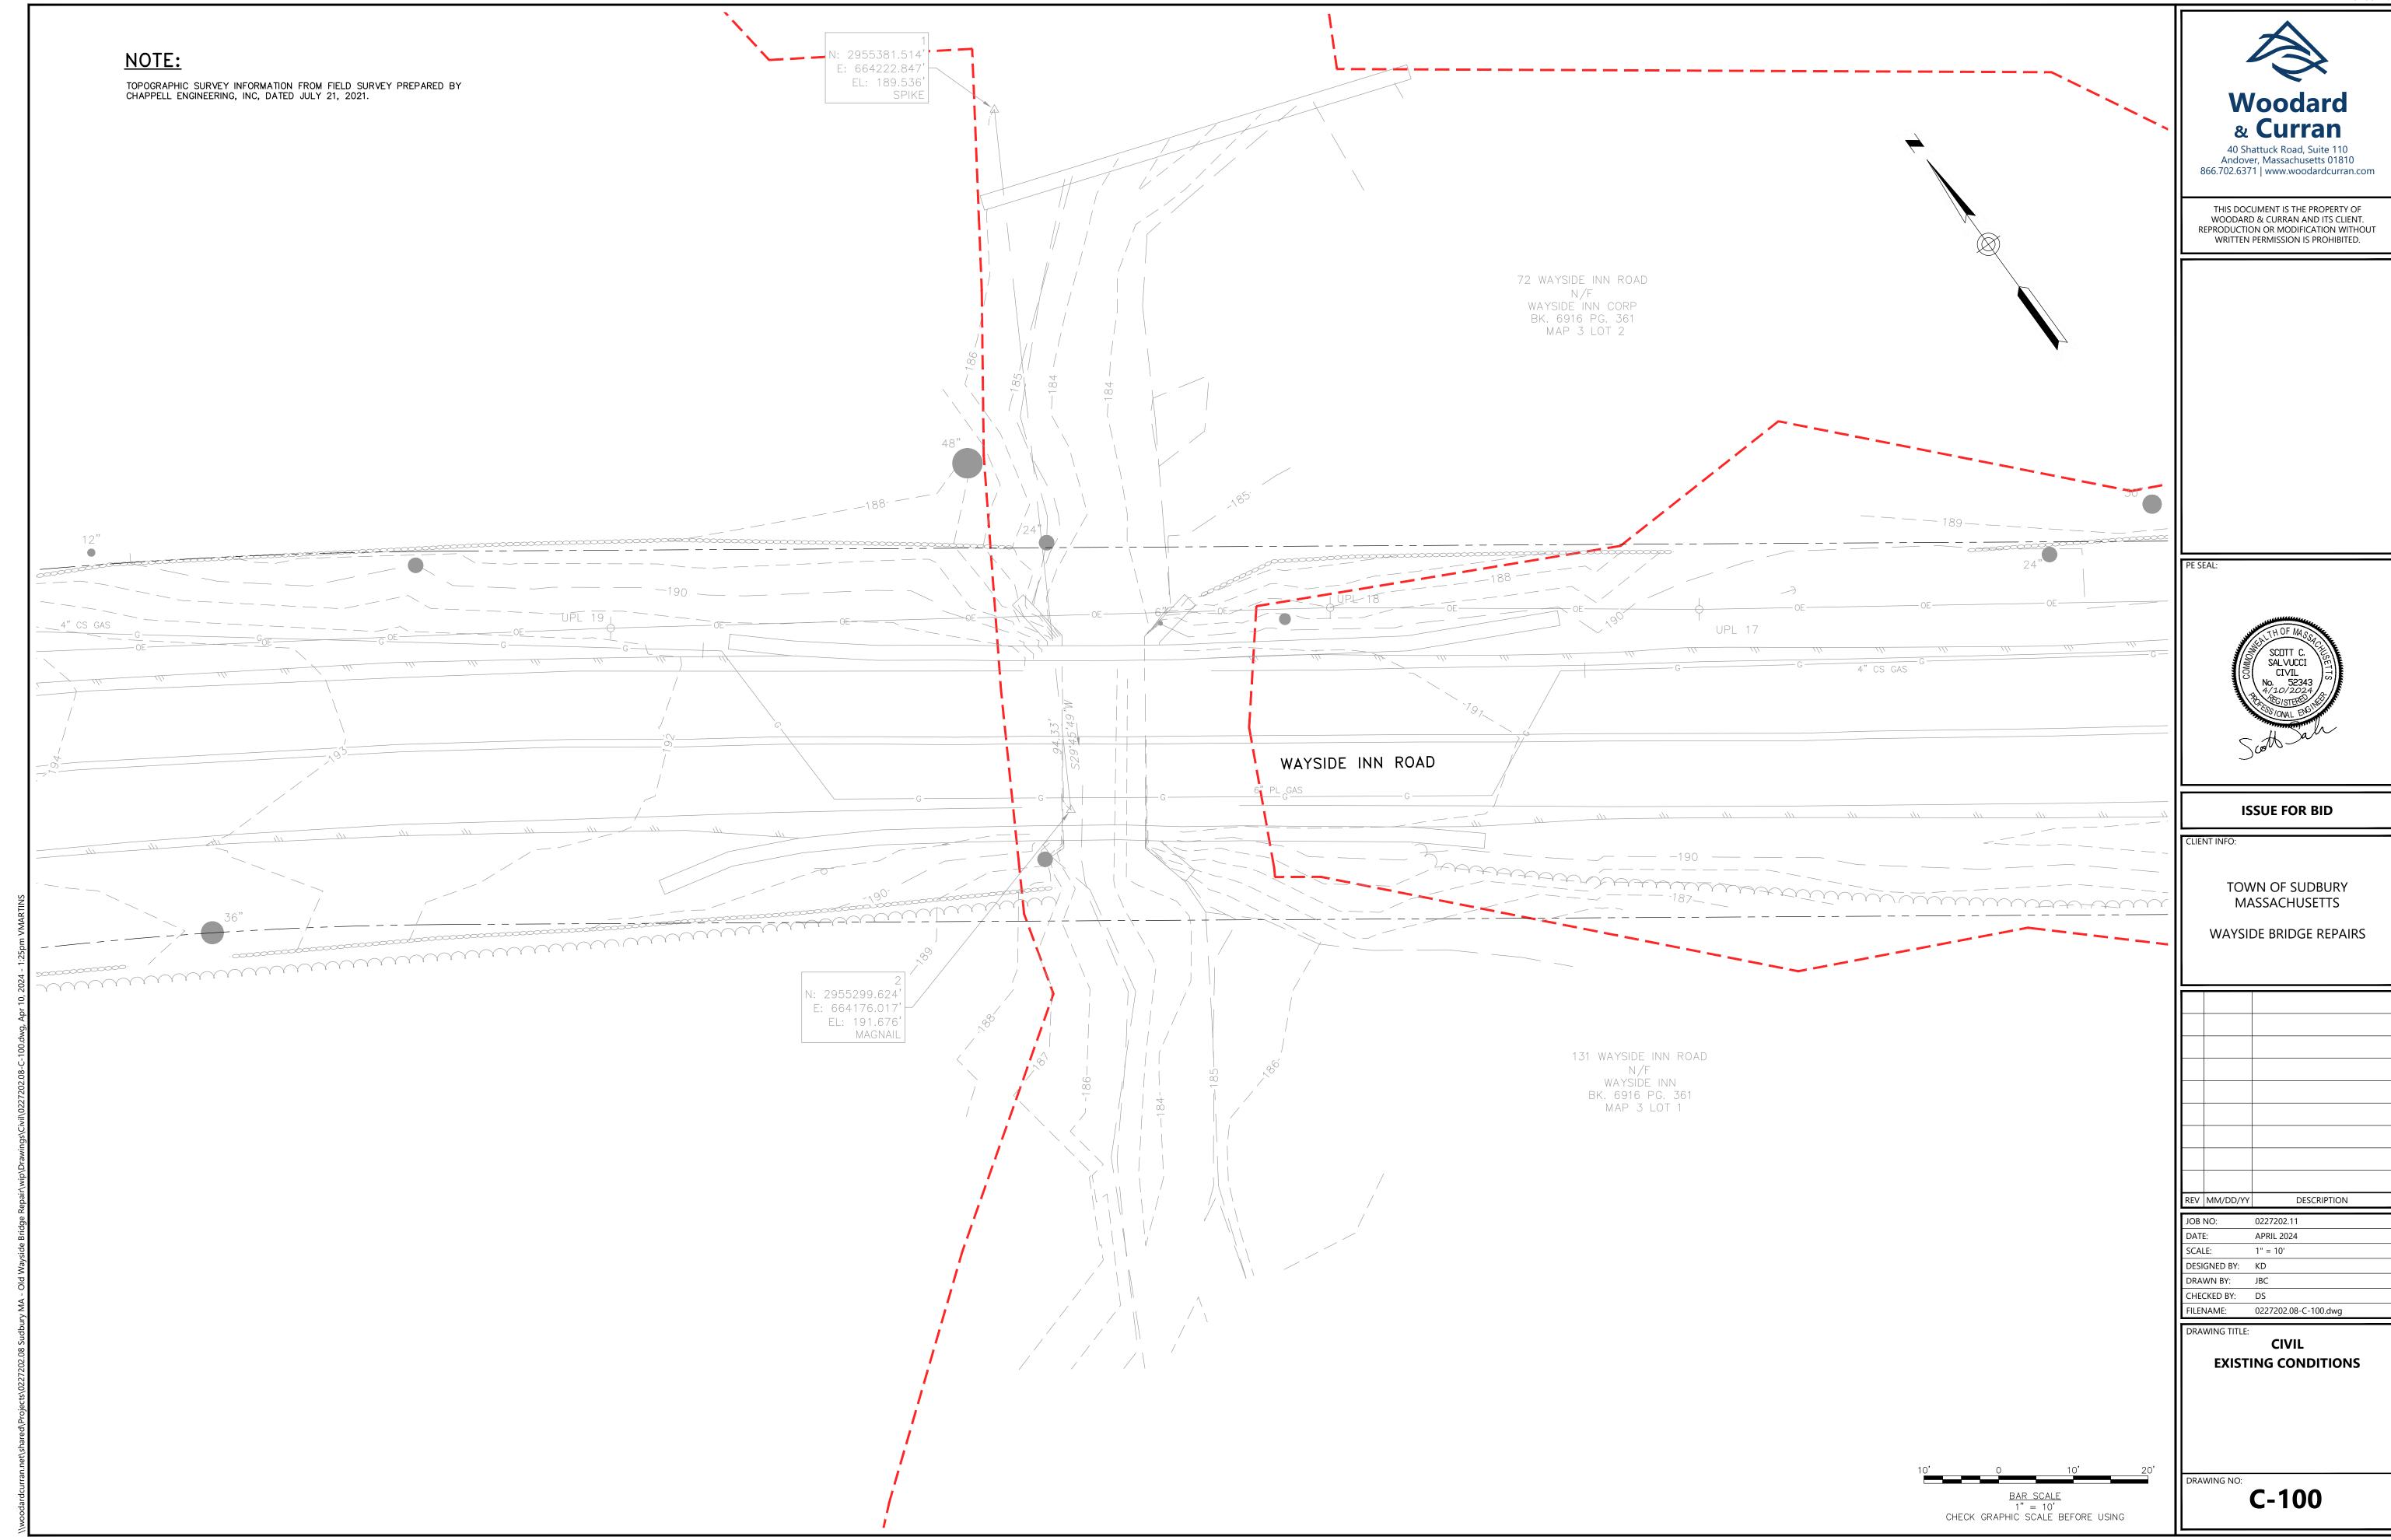

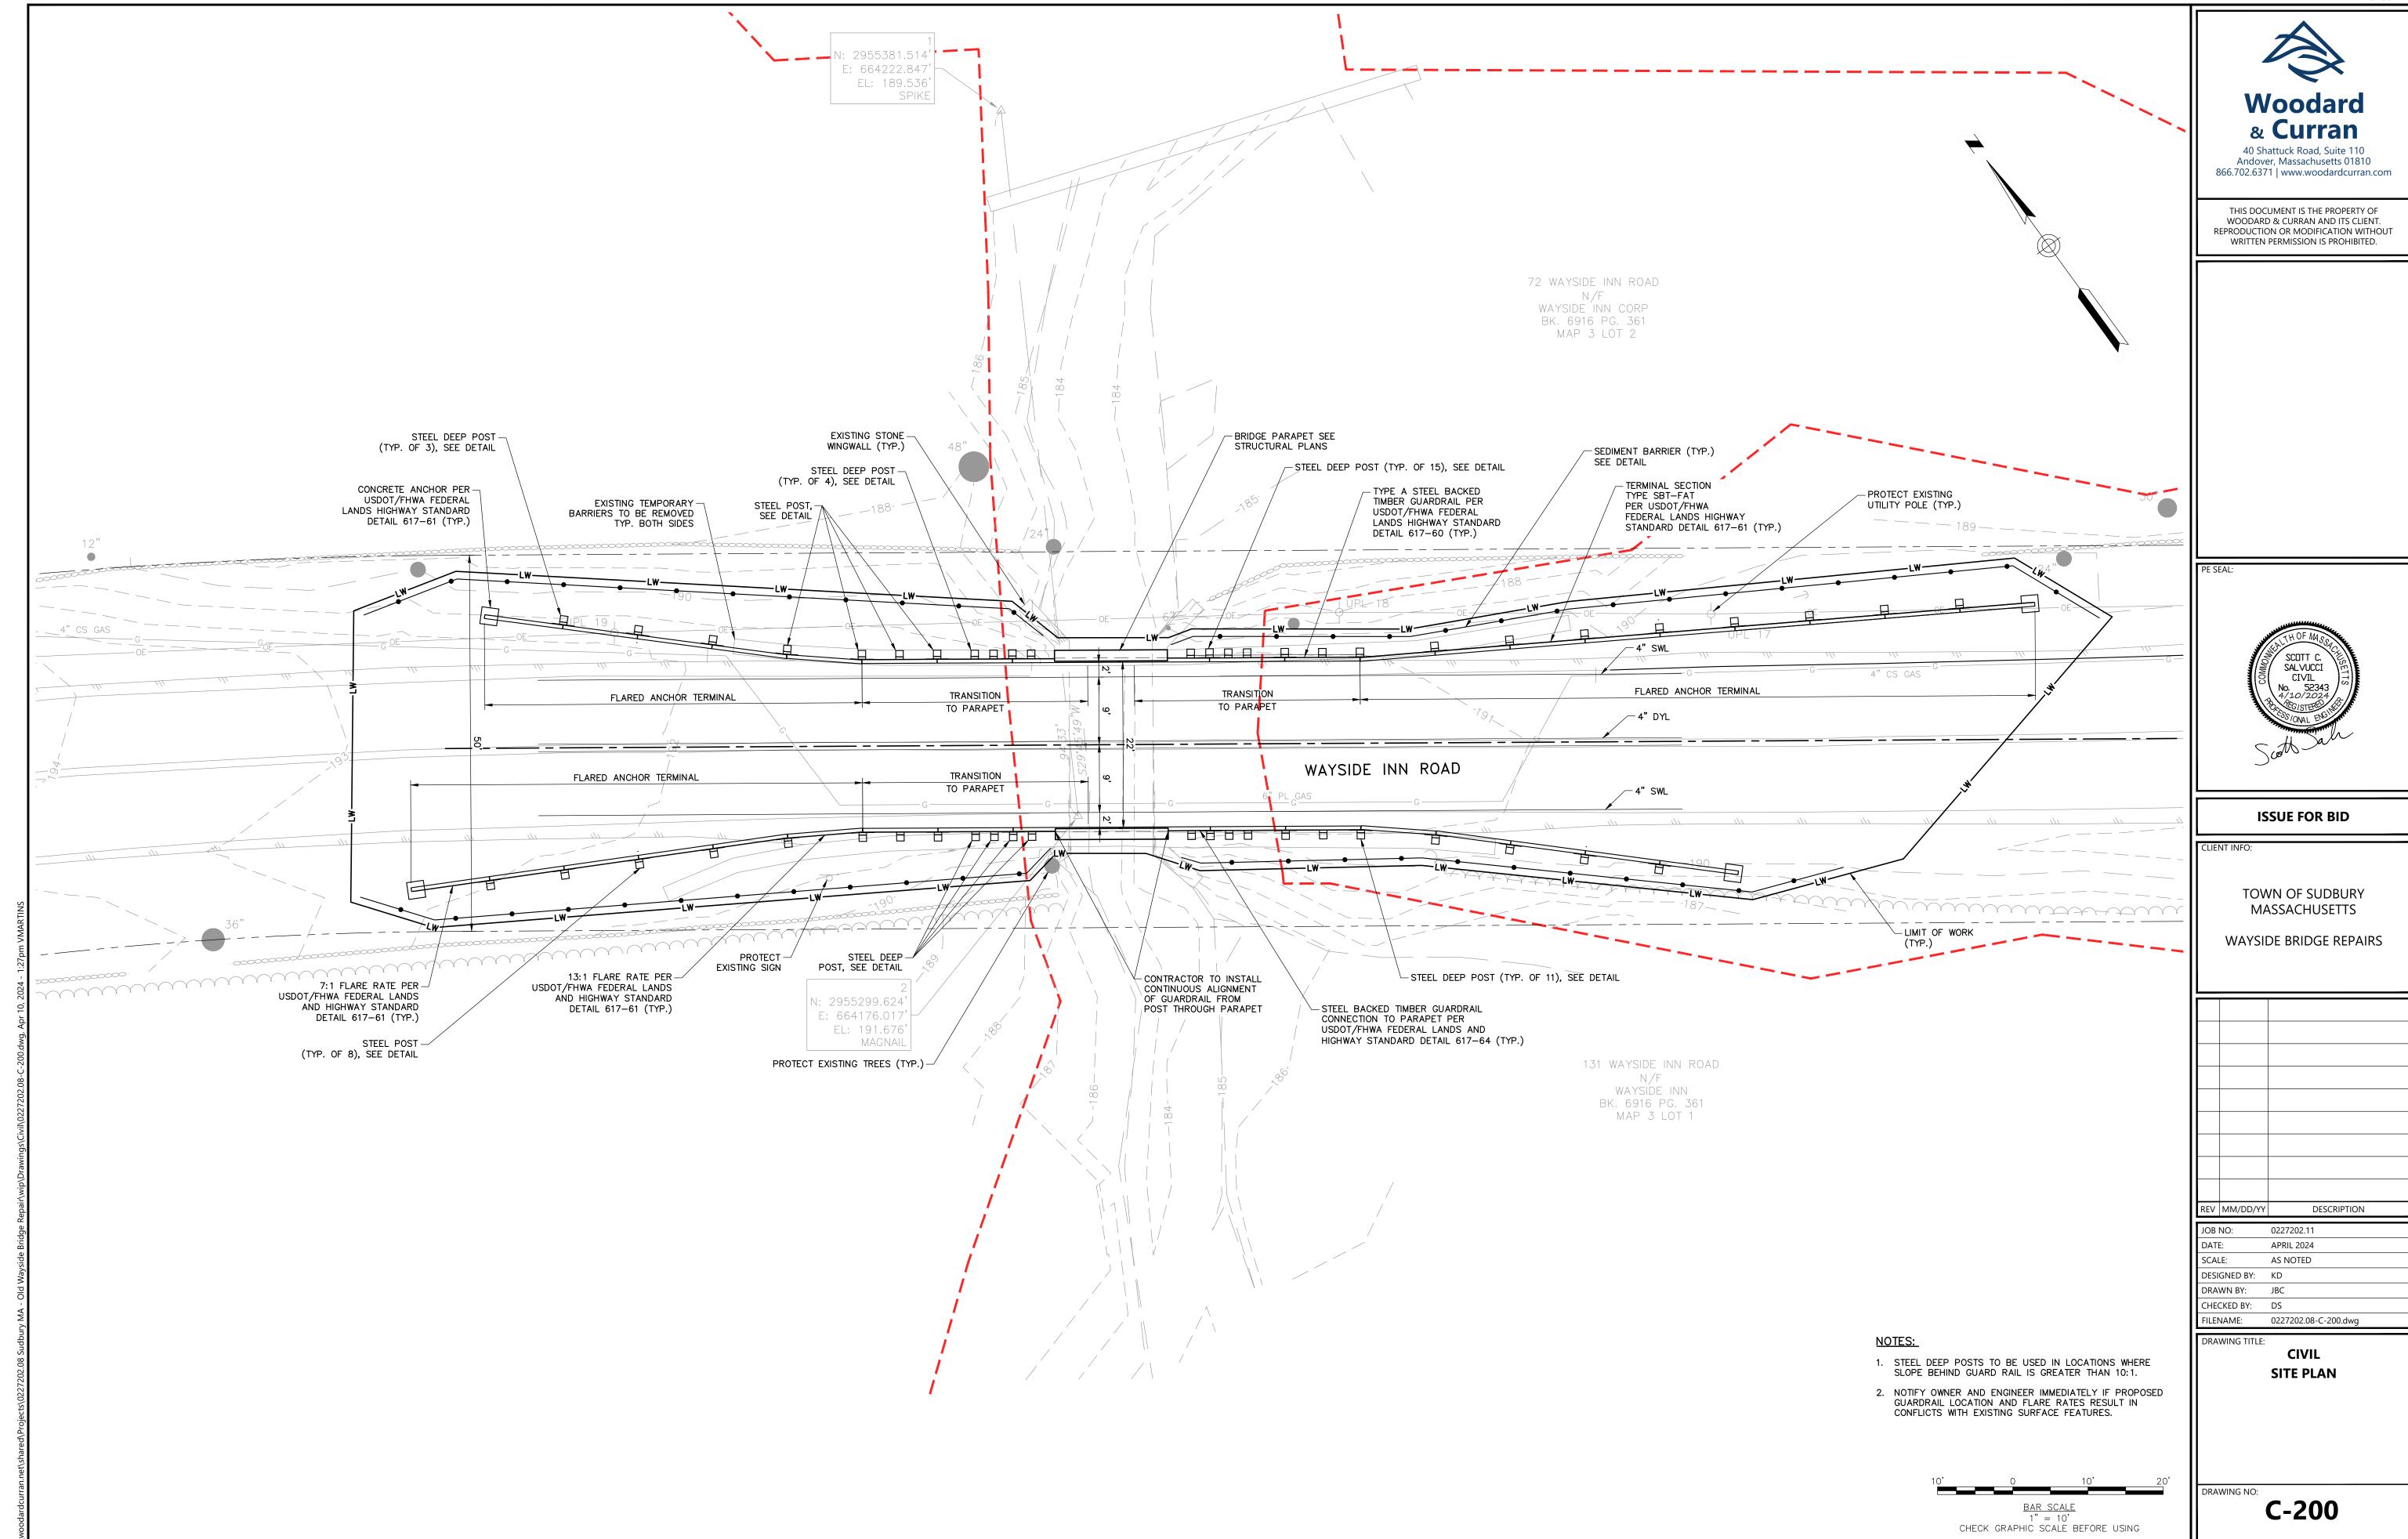


- DETAIL PER MASSDOT CONSTRUCTION STANDARD DETAILS DRAWING NUMBER 400.1.4.
- 2. DEEP STEEL POSTS SHALL ONLY BE USED WHERE INDICATED ON THE PLANS.
- 3. GUARDRAIL POSTS SHALL BE POWDER COATED BROWN.
 OWNER TO APPROVE OF COLOR PRIOR TO ORDERING POSTS.

STEEL POST DETAIL

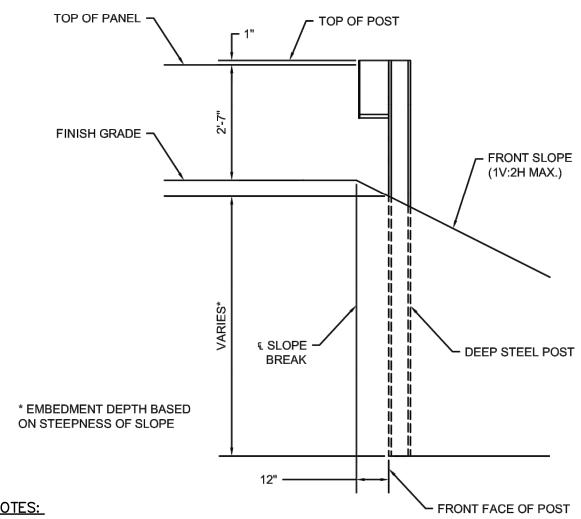

- DETAIL PER MASSDOT CONSTRUCTION DETAILS DRAWING NUMBER 400.1.5.

SLOPE BREAK CONDITION STEEL DEEP POST DETAIL

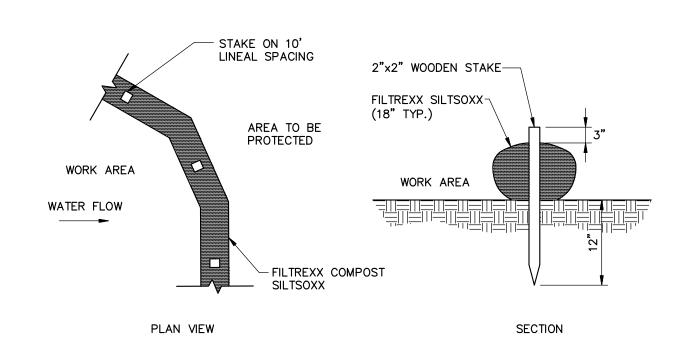

SEDIMENT BARRIER - SILTSOXX
N.T.S.

EROSION AND SEDIMENT CONTROL NOTES

Temporary Erosion Control


Measure	Dates For Use	Timing, Activity, and Location
Sedimentation Barrier	ALL	Before soil disturbance, install downhill of areas to be disturbed and around material stockpiles.
Up-slope Diversion	ALL	Before soil disturbance, install uphill of areas to be disturbed and material stockpiles.
Catch Basin Protection	ALL	Before soil or pavement disturbance, install ACF Environmental, Inc. High Flow Siltsack, Siltsaver Inlet Filter. or equal, installed per manufacturer's requirements.
Dust Control	ALL	During dry weather, apply water and calcium chloride to control dust.
Temporary Seeding	April 15 to Oct. 15	Soil stockpiles that are not covered and disturbed areas that will not be disturbed again within 14 days. If grass growth provides less than 95% soil coverage by Nov. 1, apply mulch and anchor with erosion control blanket.
Mulch	April 15 to Sept. 15	On all areas of exposed soil prior to rain events apply 100—150 lbs (2.5 bales) per 1,000 sq ft. by mechanical blower.
Winter Mulch	Sept. 16 to Oct. 31	On all areas of exposed soil prior to precipitation apply 150 to 170 lbs. mulch (4 bales) per 1,000 sq. ft. by mechanical blower. Erosion control blanket may be used as a substitute for winter mulch.
	Nov. 1 to April 14	On all areas of exposed soil, apply 150 to 170 lbs. mulch (4 bales) per 1,000 sq. ft. and anchor with netting <u>at the end of each working day.</u> Erosion control blanket may be used as a substitute for winter mulch.
Inspections	Until site is permanently stabilized	Inspect the erosion and sedimentation control measures daily, and after rainfall of half inch or greater in a 24—hour period, and maintain and repair as necessary.

Permanent Erosion Control:

Measure	Dates For Use	Timing, Activity, and Location
Pavement — Base Course — Final Course		Install only in areas shown on the plan, shortly after pavement base is brought to final grade. Install near completion of project.
Permanent Seeding	April 15 to Sept. 15	On final grade areas, within 7 days of grade preparation, prepare topsoil, followed by seed and mulch application.
Dormant Seeding	Sept. 16 to April 15	On final grade areas, with prepared topsoil. Apply seed at double the specified rate on bare soil, and follow with an application of winter mulch.
Ground Cover, Trees, Shrubs	April 15 to Nov. 1	Install with final landscaping.
Permanent Mulch	ALL	Install with final landscaping.

Regular inspections of all erosion and sedimentation controls shall be made at least weekly and prior to and following storm events. Minimum inspections shall be made as listed in the table below.

Inspected Item	Look For
Mulched Surfaces	Thin mulch or inadequate application. Wind movement.
Seeded Surfaces	Poor seed germination. Loss of mulch. Development of rivulets.
Sediment Barrier	Sediment build—up to one half the height of the barrier. Undermining of the barrier. Supporting stakes loose, toppled, or unmarked. Breaks in barrier.
Perimeter Diversion	Discharge is to stabilized area. Erosion or breaks in barrier. Supporting stakes loose, toppled or unmarked.
Catch Basin Protection	Sediment build—up and structure blockages. Slow flow/Ponding water. Breaks in fabric or voids in barrier.
Dewatering Filter	Breaks in fabric or supporting structure. Slow flow, indicating high sediment build—up.
Construction Entrance	Sedimentation of roadways. Off—site dust complaints.

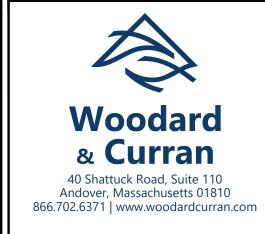

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ISSUE FOR BID

TOWN OF SUDBURY MASSACHUSETTS


WAYSIDE BRIDGE REPAIRS

REV MM/DD/YY DESCRIPTION


APRIL 2024 SCALE: AS NOTED DESIGNED BY: KD DRAWN BY: JBC FILENAME: 0227202.08-C-300.dwg

CIVIL **CIVIL DETAILS - 1**

C-300

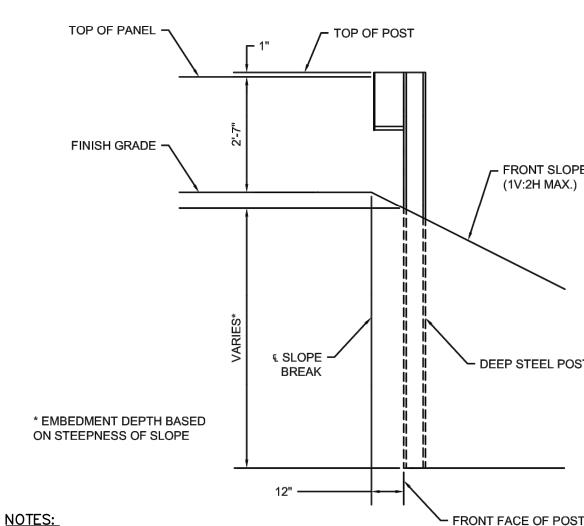

DEEP STEEL POSTS SHALL ONLY BE USED WHERE INDICATED ON THE PLANS.

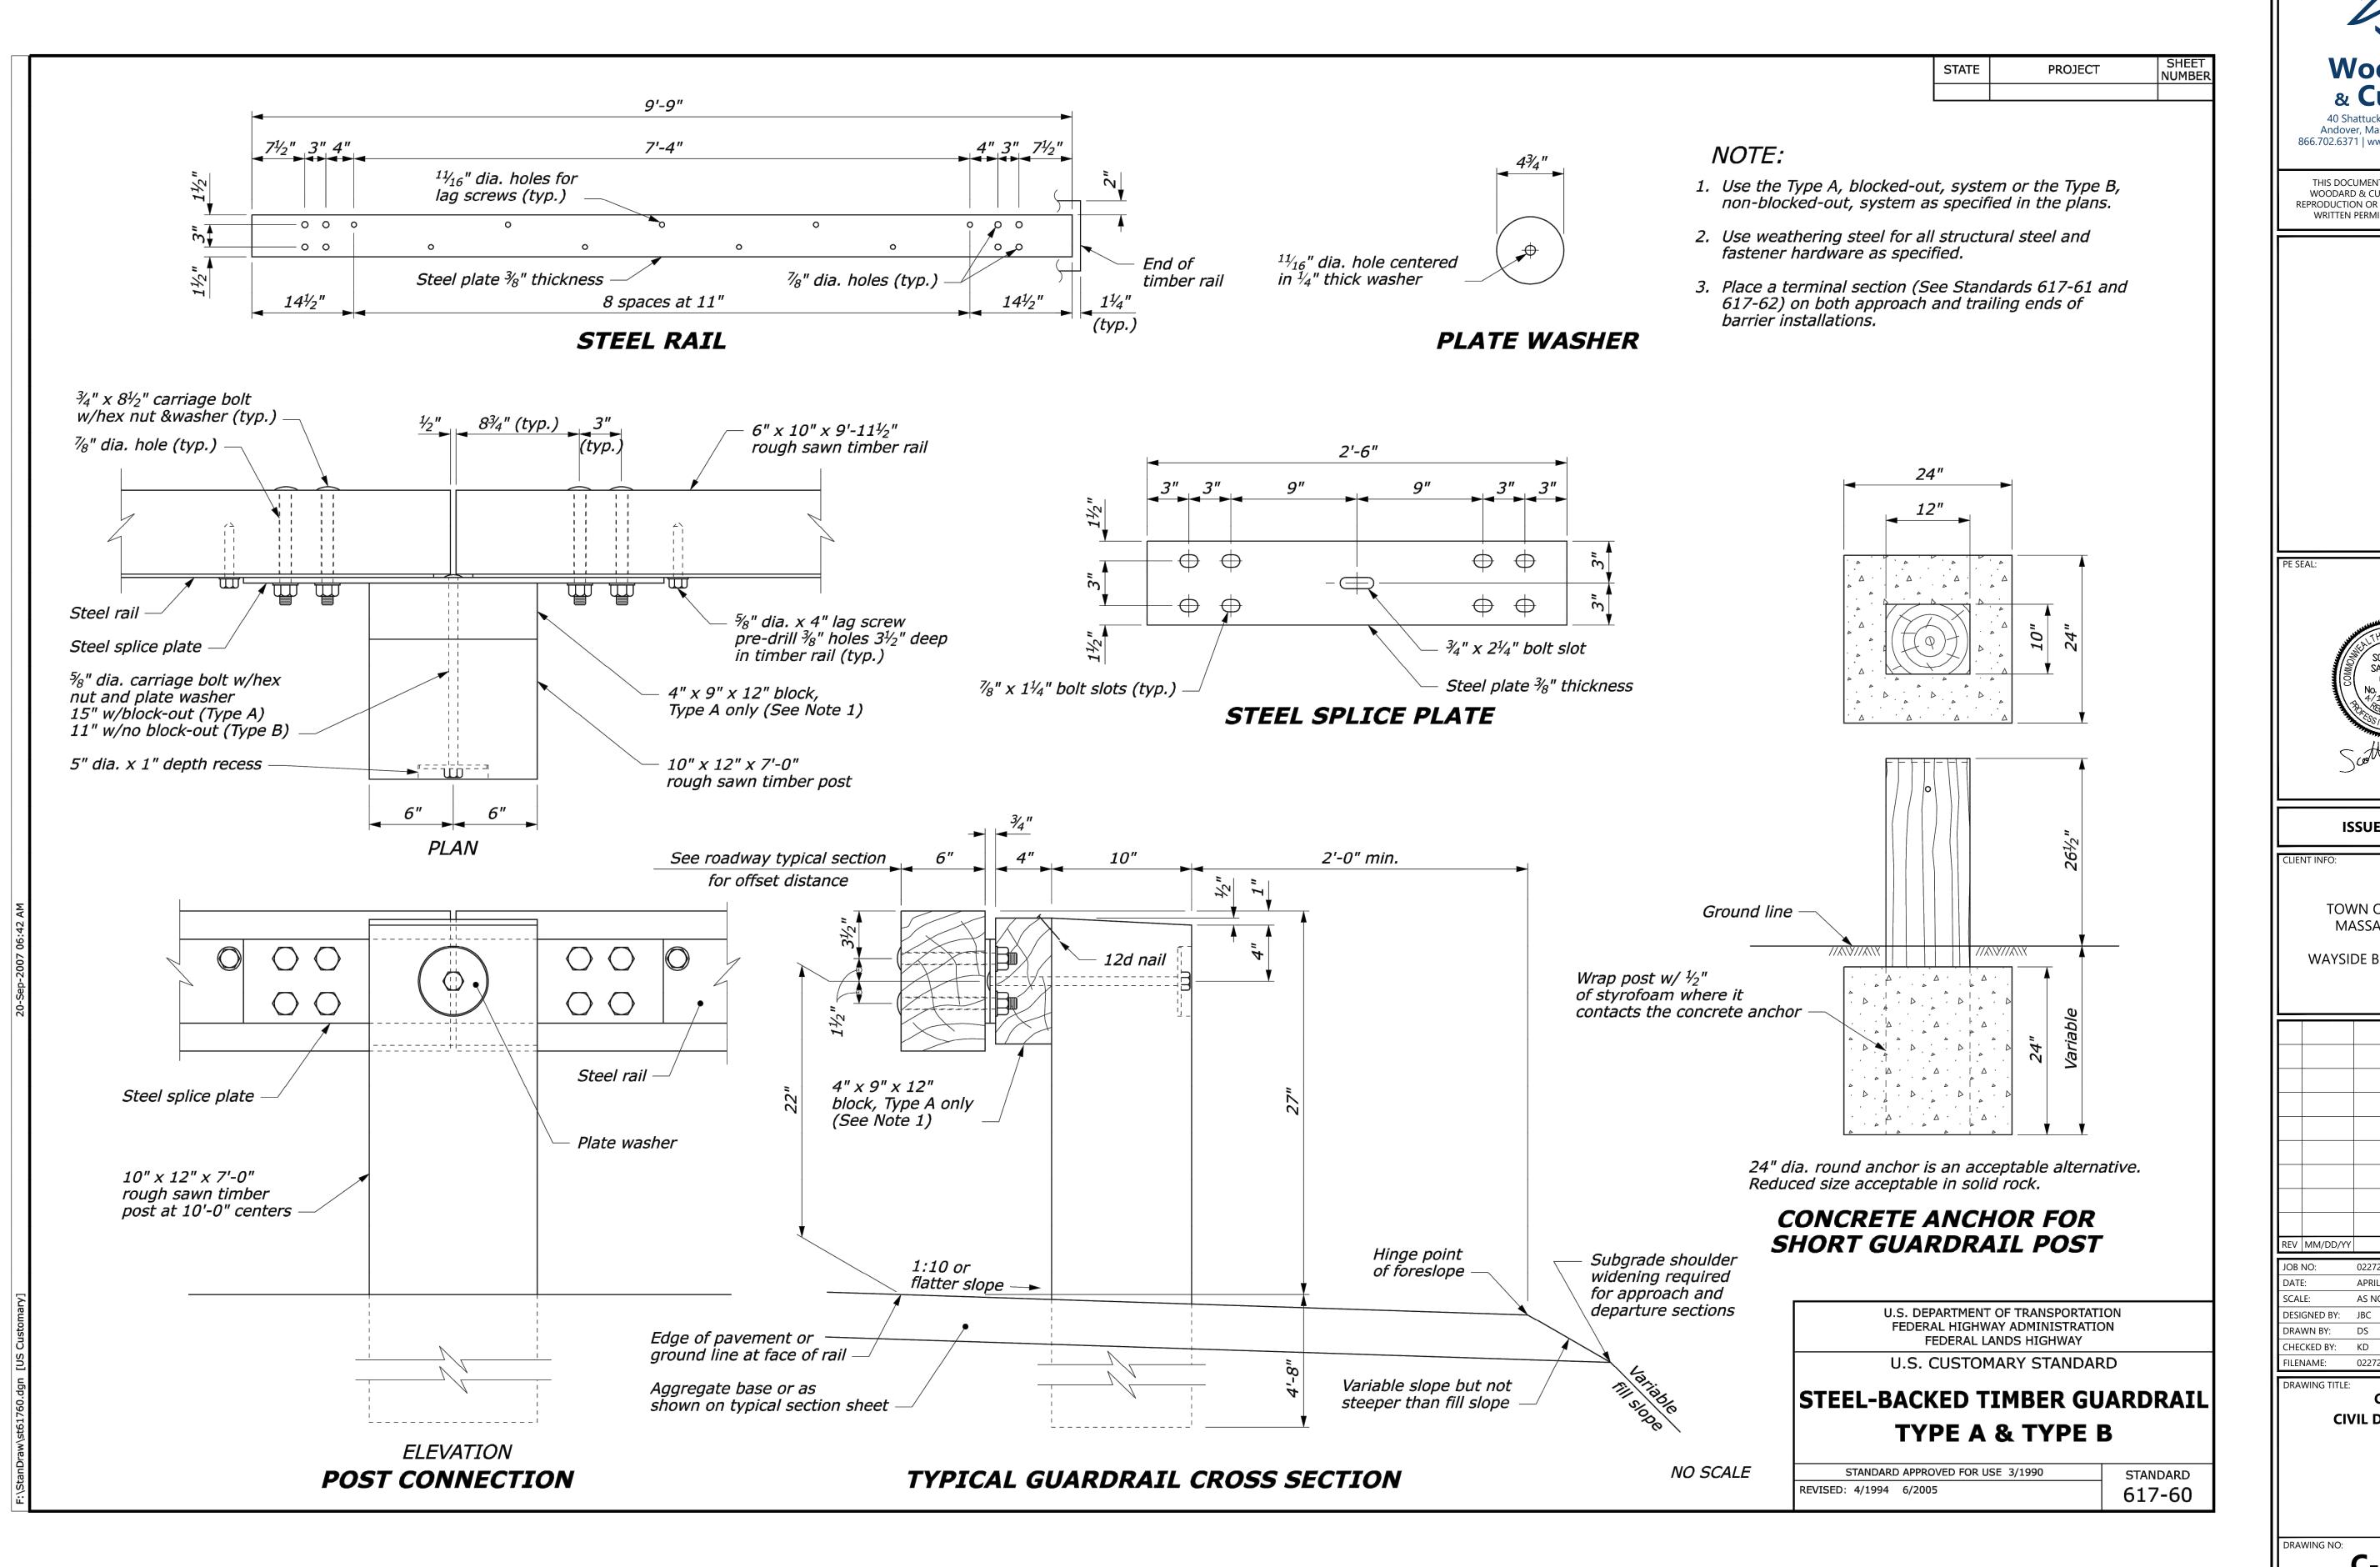

Woodard & Curran 40 Shattuck Road, Suite 110 Andover, Massachusetts 01810 866.702.6371 | www.woodardcurran.com

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SALVUCCI CIVIL

ISSUE FOR BID

TOWN OF SUDBURY **MASSACHUSETTS**

WAYSIDE BRIDGE REPAIRS

DESCRIPTION APRIL 2024 AS NOTED

0227202.08-C-300.dwg

CIVIL

CIVIL DETAILS - 2

C-301

1. **GOVERNING CODES**

1.1. MASS STATE BUILDING CODE 780 CMR NINTH EDITION
1.2. MASSDOT LRFD BRIDGE MANUAL 2013
1.3. ACI 318-14

2. <u>DESIGN LOADS AND CRITERIA</u>

2.1. BASIC DESIGN PARAMETERS
PROJECT ADDRESS:
PROJECT LOCATION:
LAT 42.357°
LONG -71.470°
GENERAL ELEVATION 188-FT

2.1. <u>DEAD LOADS</u> ACTUAL

2.2. <u>LIVE LOADS</u> IMPACT LOAD

3. DEMO OR DEMOLISH SHALL MEAN TO REMOVE AND LEGALLY DISPOSE OF ITEM(S)

10,000 LBS

MATERIAL NOTES SPECIFICATIONS

A. CONCRETE: CURB

CONCRETE

PORTLAND CEMENT

FLY ASH

WATER / CEMENTITIOUS RATIO

COMPRESSIVE STRENGTH
ENTRAINED AIR

SLUMP

ASTM C150, TYPE I OR II

ASTM C618 C OR F, 20% MIN BY WEIGHT

0.40 MAX

f'c = 5000 PSI
6% ± 1.5%

4 IN +/- 1 IN

- 1.1. USE ONE BRAND OF CEMENT THROUGHOUT PROJECT, UNLESS OTHERWISE
- ACCEPTABLE TO THE ENGINEER OF RECORD.

 1.2. WATER SHALL BE CLEAN AND FREE FROM DELETERIOUS AMOUNTS OF OIL, ACIDS, ALKALIS, ORGANIC MATERIAL, AND OTHER FOREIGN MATTER AND SHALL CONFORM
- 10 ASIM C94

 1.3. CONCRETE MIX SHALL MEET MASS DOT STANDARDS FOR INTENDED SERVICE.

2. <u>EPOXIED REINFORCING:</u>
DEFORMED BAR
EPOXY COATING

ASTM A615, GRADE 60 ASTM A775

B. CONCRETE ANCHORS

3. <u>POST_INSTALLED - ADHESIVE</u>

ANCHOR DEFORMED BAR ASTM A615, GR 60
ADHESIVE HILTI HIT—RE 500 V3
EXG CONC STRENGTH 3,000 PSI, CRACKED (ASSUMED)

ALTERATION OF EXISTING STRUCTURES

- 1. THE CONTRACTOR SHALL BE RESPONSIBLE FOR ANY TEMPORARY MODIFICATIONS AND REPLACEMENT TO EXISTING BRIDGE COMPONENTS AS REQUIRED FOR THE INSTALLATION OF THE NEW PARAPET.
- 2. CONTRACTOR SHALL PROVIDE WRITTEN PLANS DETAILING THE SEQUENCE, PROCEDURE, AND PROPOSED EQUIPMENT FOR REVIEW BY THE ENGINEER OF RECORD PRIOR TO BEGINNING THE WORK.

CONCRETE NOTES

1. CONCRETE REINFORCEMENT FABRICATION

- 1.1. REINFORCEMENT DETAILING SHALL BE DONE IN CONFORMANCE WITH ACI SP-66, CURRENT EDITION.
- 1.2. FABRICATOR SHALL TAG ALL REINFORCEMENT FOR PROPER PLACEMENT IF SHOP FABRICATED. REINFORCING SHALL BE BENT PER CRSI 10 MANUAL OF STANDARD PRACTICE.

2. CONCRETE AND REINFORCEMENT PLACEMENT

- 2.1. PERFORM CONCRETE WORK IN ACCORDANCE WITH CURRENT ACI 301 "STANDARD SPECIFICATION FOR STRUCTURAL CONCRETE" UNLESS MORE STRINGENT REQUIREMENTS ARE INDICATED.
- 2.2. CONCRETE SHALL BE FORMED AND LOCATED AS PER ACI 117 "SPECIFICATIONS FOR TOLERANCES FOR CONCRETE CONSTRUCTION AND MATERIALS AND COMMENTARY.
- 2.3. FORMS SHALL BE COATED WITH A FORM RELEASE AGENT. FORM RELEASE AGENT SHALL NOT RAISE FORM GRAIN OR STAIN CONCRETE SURFACE.

 2.4. MECHANICALLY VIBRATE ALL CONCRETE PLACEMENTS, BUT VIBRATION SHALL
- NOT BE UTILIZED TO CONVEY MATERIAL.
 2.5. WELDING OF REINFORCING BARS IS NOT PERMITTED WITHOUT A PROCEDURE
- APPROVED BY THE ENGINEER OF RECORD.


 2.6. SECURE ALL REINFORCING IN POSITION WITH CHAIRS BEFORE CONCRETE PLACEMENT. REINFORCING SHALL BE INSPECTED FOR PROPER PLACEMENT.

3. <u>CONCRETE FINISHING</u>

3.1. CHAMFER ALL EXPOSED EDGES 3/4" (TYPICAL UNLESS NOTIFIED OTHERWISE). CHAMFER VIA GRINDING IS PROHIBITED.

. CONCRETE TESTING AND INSPECTION

4.1. ALL CONCRETE SHALL BE FIELD TESTED BY AN INDEPENDENT TESTING LABORATORY AS PER ASTM SPECIFICATIONS (PAID FOR BY CONTRACTOR). FOR EACH PLACEMENT, ONE SET OF 5 STANDARD COMPRESSION TEST CYLINDERS SHALL BE TAKEN AND TESTED IN ACCORDANCE WITH ASTM C39: 1 SPECIMEN TESTED AT 7 DAYS; 3 SPECIMENS TESTED AT 28 DAYS; AND 1 SPECIMEN RETAINED IN RESERVE FOR LATER TESTING IF REQUIRED.

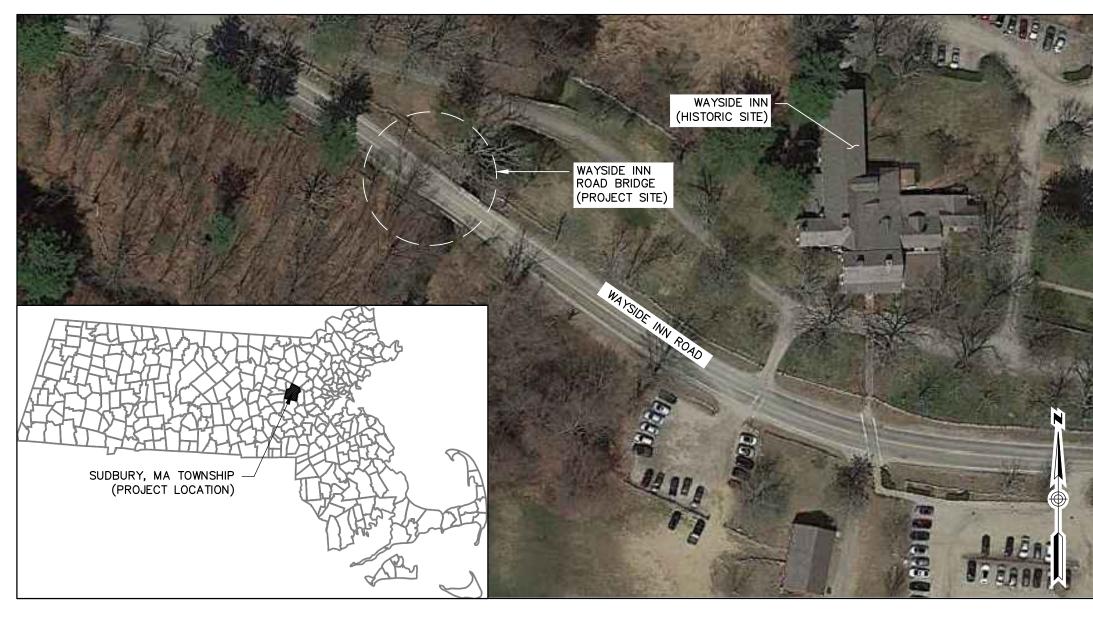

SITE PLAN: WAYSIDE INN ROAD BRIDGE SITE



PHOTO 1: EXISTING CONDITIONS - WAYSIDE BRIDGE LOOKING SOUTH

EPOXY-COATED REINFORCEMENT NOTES

1. <u>REINFORCEMENT</u>

1.1. ALL REINFORCING BARS SHALL BE DEFORMED AND SHALL CONFORM TO ASTM A 615

1.2. EPOXY—COATED REINFORCING BARS SHALL CONFORM TO ASTM A 775

1.3. WHEN REQUIRED, DAMAGES TO EPOXY COATING SHALL BE REPAIRED WITH PATCHING MATERIAL CONFORMING TO ASTM A775. REPAIR SHALL BE DONE IN ACCORDANCE WITH THE PATCHING MATERIAL MANUFACTURER'S RECOMMENDATIONS.

2. <u>FABRICATION</u>

2.1. ALL REINFORCEMENT SHALL BE BENT COLD UNLESS OTHERWISE PERMITTED BY THE ENGINEER.

3. PLACING (FIELD INSTALLATION)

- 3.1. EPOXY-COATED REINFORCING BARS SUPPORTED FROM FORMWORK SHALL REST ON COATED WIRE BAR SUPPORTS, OR ON BAR SUPPORTS MADE OF DIELECTRIC MATERIAL OR OTHER ACCEPTABLE MATERIALS. REINFORCING BARS USED AS SUPPORT BARS SHALL BE
- 3.2. EPOXY-COATED.

 3.2. EPOXY-COATED REINFORCING BARS SHALL BE FASTENED WITH NYLON-, EPOXY-, OR PLASTIC-COATED TIE WIRE OR OTHER ACCEPTABLE
- MATERIALS.

 3.3. SPLICES OF REINFORCING BARS SHALL BE MADE ONLY AS AUTHORIZED BY THE ENGINEER
- 3.4. REINFORCING BARS PARTIALLY EMBEDDED IN CONCRETE SHALL NOT BE FIELD BENT EXCEPT WHERE SHOWN ON THE DRAWINGS. WHERE REINFORCING BARS ARE FIELD BENT, COATING DAMAGE SHALL BE REPAIRED PER THESE NOTES.

 3.5. UNLESS PERMITTED BY THE ENGINEER, REINFORCING BARS SHALL BE NOT BE FIELD CUT. WHEN EPOXY—COATED REINFORCING BARS ARE
- THESE NOTES.

 3.6. EQUIPMENT FOR HANDLING EPOXY—COATED BARS SHALL HAVE PROTECTED CONTACT AREAS. BUNDLES OF COATED BARS SHALL BE LIFTED AT MULTIPLE PICK—UP POINTS TO MINIMIZE BAR—TO—BAR ABRASION FROM SAGS IN THE BUNDLES. COATED BARS OR BUNDLES OF COATED BARS SHALL NOT BE DROPPED OR DRAGGED. COATED BARS SHALL BE STORED ON PROTECTIVE CRIBBING. FADING OF THE COATING SHALL NOT BE CAUSE FOR REJECTION OF EPOXY—COATED REINFORCING BARS. COATING DAMAGE DUE TO HANDLING, SHIPMENT, AND PLACING NEED NOT BE REPAIRED IN CASES WHERE THE DAMAGED AREA IS 0.1 SQUARE INCH OR SMALLER. DAMAGED AREAS LARGER THAN 0.1 SQUARE INCH SHALL BE REPAIRED PER THESE NOTES. THE MAXIMUM AMOUNT OF DAMAGE INCLUDING REPAIRED AND UNREPAIRED AREAS SHALL NOT EXCEED 2 PERCENT OF THE SURFACE AREA OF EACH BAR.

CUT IN THE FIELD, THE ENDS OF THE BARS SHALL BE COATED WITH THE SAME MATERIAL USED FOR REPAIR OF COATING DAMAGE PER

ABBREVIATIONS

& AND

AT

PERCENT(AGE)

PUS OR MINUS

ACI AMERICAN CONCRETE INSTITUTE

ASTM AMERICAN SOCIETY OF TESTING MATERIALS

BOT BOTTOM

CLR CLEAR

CONC CONCRETE

CONT CONTINUOUS

DEMO DEMOLISH

EF EACH FACE

EMB EMBEDMENT
FT FOOT / FEET
FV FIELD VERIFY
IN INCHE(S)
LB POUND
MAX MAXIMUM
MIN MINIMUM

EXISTING

EXG

OC ON CENTER
OCEF ON CENTER EACH FACE
REF REFERENCE
TYP TYPICAL



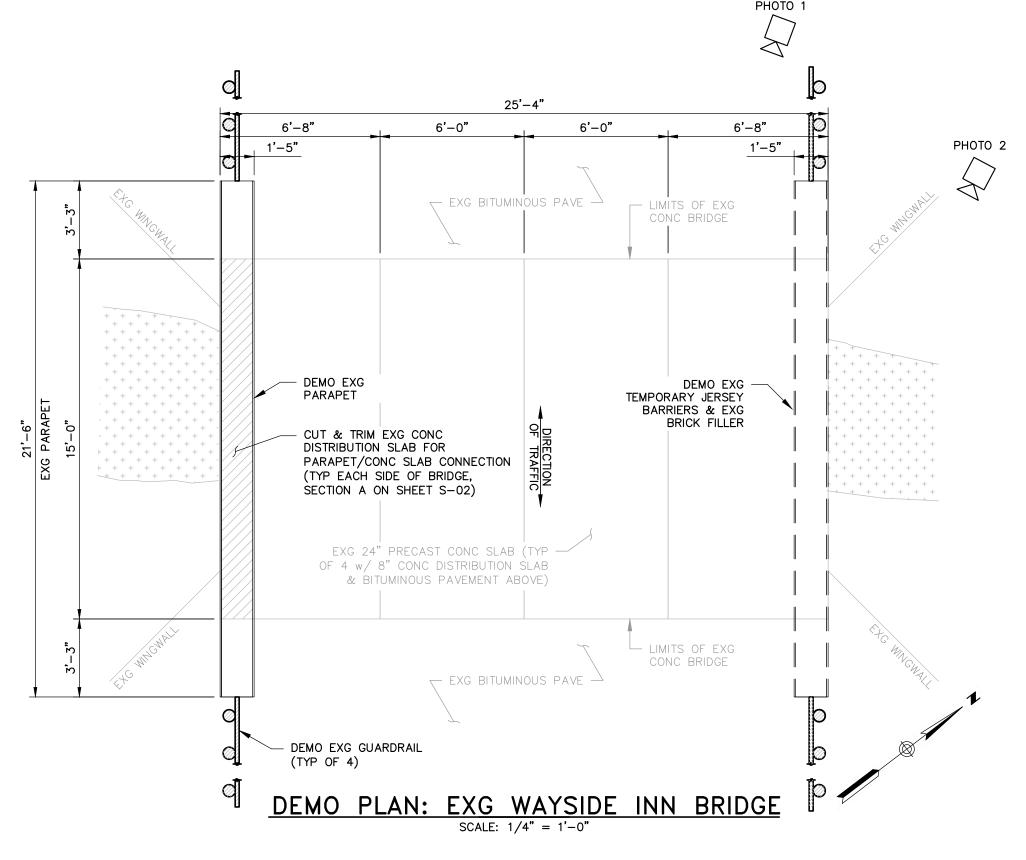




PHOTO 2: EXISTING CONDITIONS - MISSING PARAPET

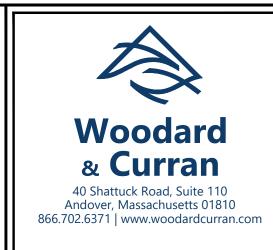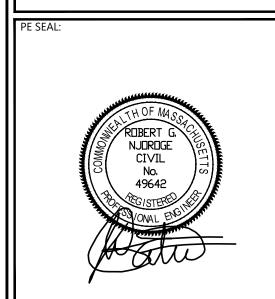

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ISSUE FOR BID

IENT INFO:

TOWN OF SUDBURY
MASSACHUSETTS

WAYSIDE BRIDGE REPAIRS

REV	MM/DD/YY	DESCRIPTION
JOB	NO:	0227202.11
DAT	E:	APRIL 2024
SCA	l F·	AS NOTED

JOB NO: 0227202.11

DATE: APRIL 2024

SCALE: AS NOTED

DESIGNED BY: CSB

DRAWN BY: CSB


CHECKED BY: TJS/JPS


FILENAME: 0227202.08_S-101.dwg

DRAWING TITLE:

STRUCTURAL
WAYSIDE INN BRIDGE REPAIRS
SITE PLAN, NOTES,
EXISTING CONDITIONS,
AND DEMOLITION PLAN

DRAWING NO:

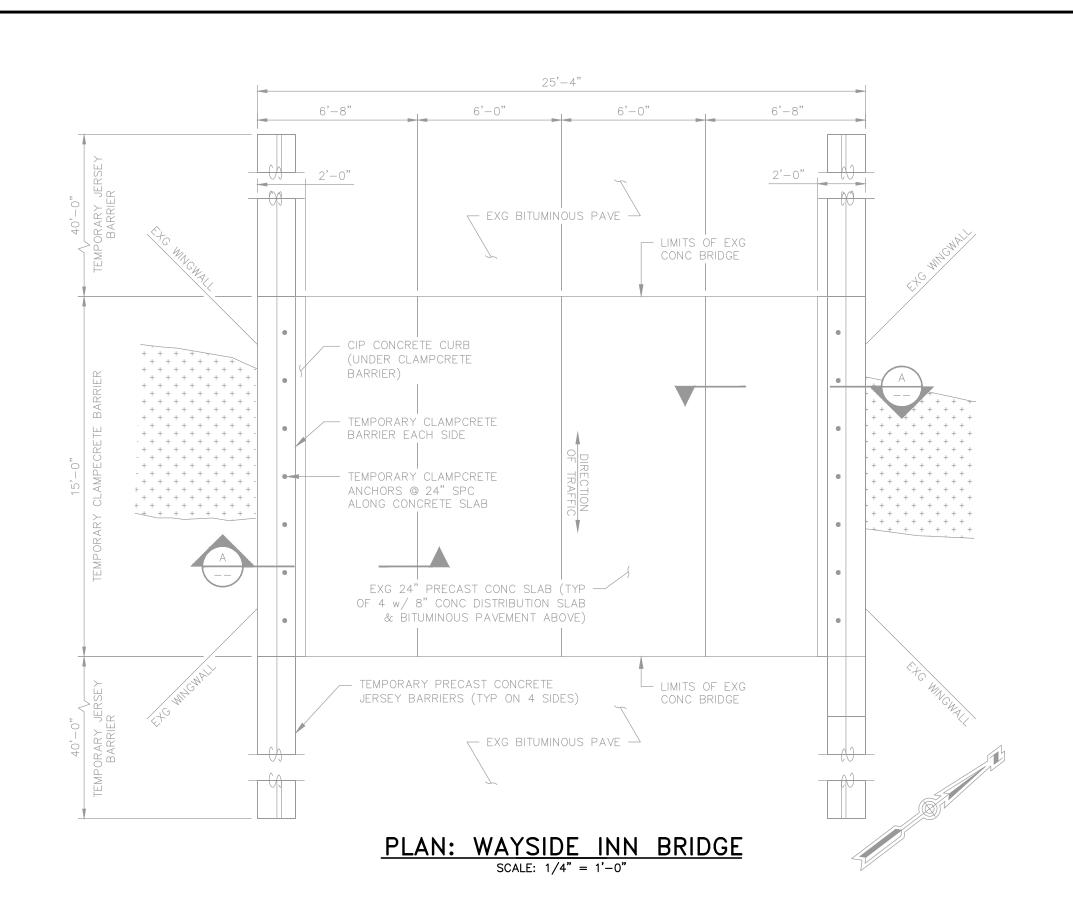

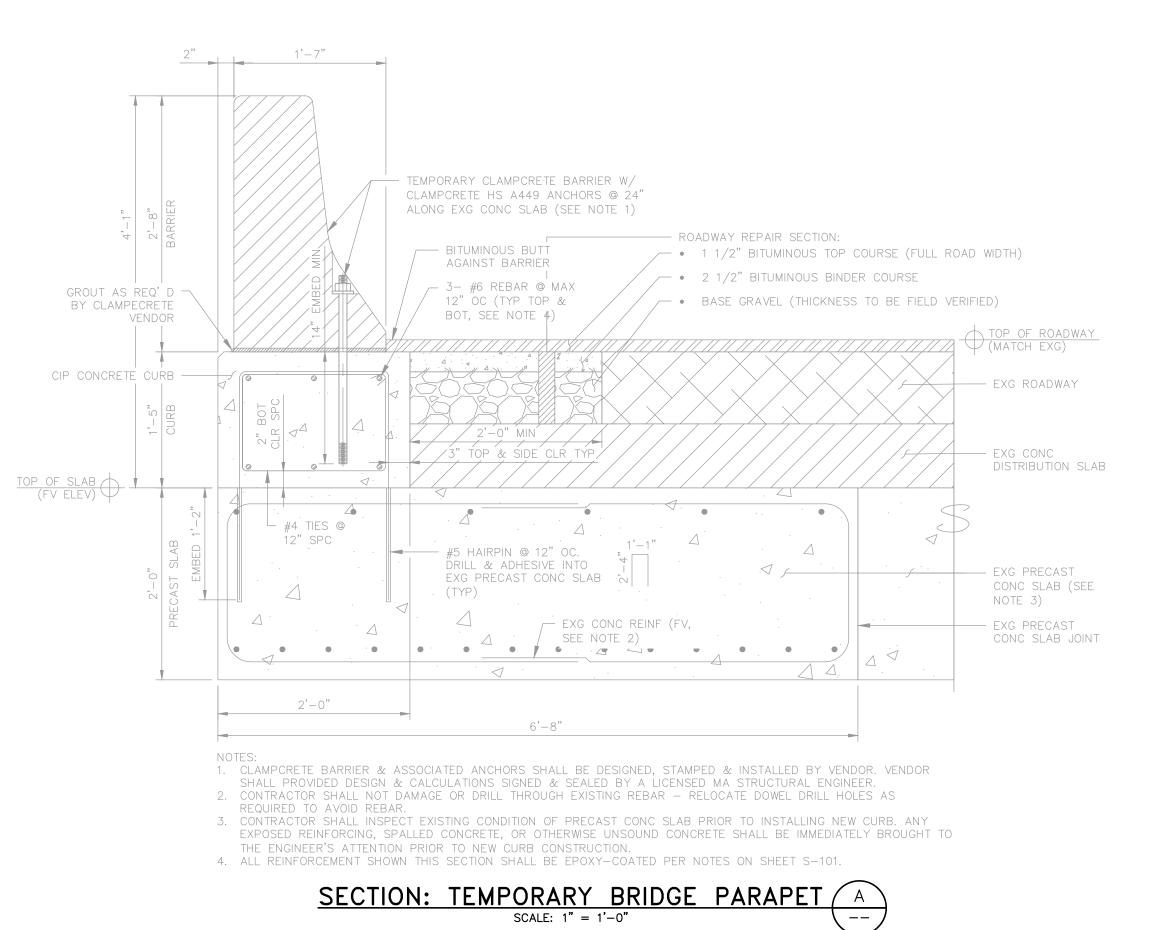


NOTE:

 NOT FOR CONSTRUCTION EXISTING CONDITIONS SHEET IS FOR INFORMATION ONLY.



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PE SE

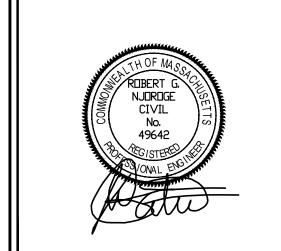

FOR INFORMATIONAL PURPOSES ONLY

CLIENT INFO:

TOWN OF SUDBURY
MASSACHUSETTS

WAYSIDE BRIDGE REPAIRS

REV MM/DD/YY DESCRIPTION

JOB NO: 0227202.11

JOB NO: 0227202.11

DATE: APRIL 2024

SCALE: AS NOTED

DESIGNED BY: CSB

DRAWN BY: CSB

CHECKED BY: TJS/JPS

FILENAME: 0227202.08_S-102.dwg


DRAWING TITLE:

STRUCTURAL
WAYSIDE INN BRIDGE REPAIRS
PROPOSED PLAN AND SECTION

DRAWING NO:

S-102

FOR INFORMATIONAL PURPOSES ONLY

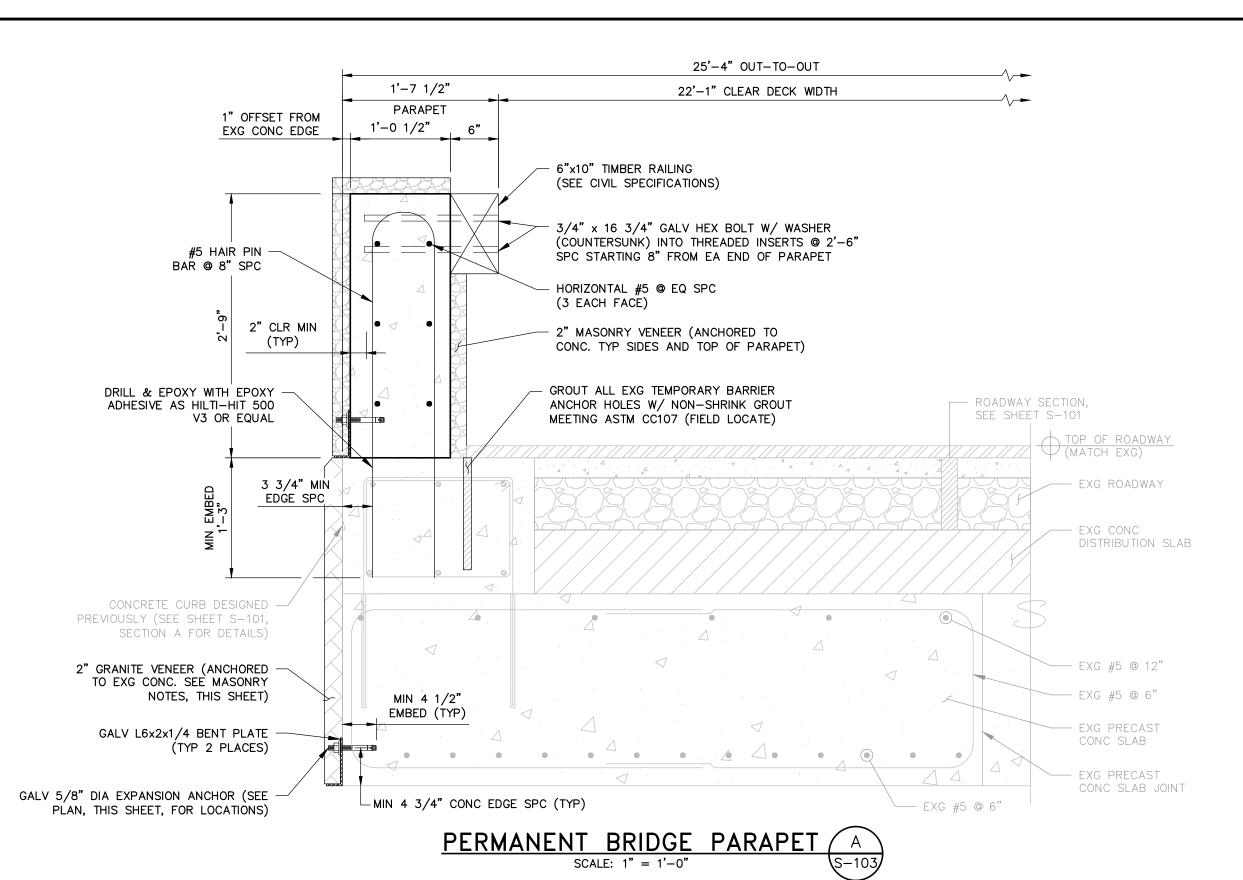

- 1. CONTRACTOR SHALL NOT DAMAGE OR DRILL THROUGH EXISTING REBAR. RELOCATE DOWELING AS REQUIRED TO
- 2. EXISTING CONCRETE ASSUMED IN GOOD CONDITION. PRIOR TO CONSTRUCTION, CONTRACTOR SHALL VERIFY CONDITION OF EXISTING CONCRETE WHERE VENEER WILL BE LOCATED. ANY EXPOSED REINFORCING, SPALLED CONCRETE, OR OTHERWISE UNSOUND CONCRETE SHALL BE IMMEDIATELY BROUGHT TO THE ENGINEER'S ATTENTION BEFORE STARTING CONSTRUCTION.

A. GENERAL STRUCTURAL NOTES:

THESE NOTES SHALL APPLY TO ALL WORK THIS SHEET, EXCEPT AS NOTED OTHERWISE. SEE SHEETS S-01 & S-02 FOR WORK PREVIOUSLY PERFORMED.

GOVERNING CODES

- 2.1. MASS STATE BUILDING CODE 780 CMR NINTH EDITION 2.2. MASSDOT LRFD BRIDGE MANUAL 2013
- 2.3. AISC STEEL CONSTRUCTION MANUAL, 14TH ED. 2.4. ACI 318-14 BUILDING CODE REQUIREMENTS FOR STRUCTURAL CONCRETE,

3. <u>DESIGN LOADS AND CRITERIA</u>

3.1. <u>BASIC DESIGN PARAMETERS</u> PROJECT ADDRESS:

SUDBURY, MA 42.357° PROJECT LOCATION: LAT LONG -71.470° 188 FT

GENERAL ELEVATION

3.1. <u>DEAD LOADS</u>

30 PSF (EQUIVALENT TO 2" GRANITE @ 180 PCF) STONE FACADE

10,000 LBS

3.2. <u>LIVE LOADS</u>

B. <u>REINFORCED CONCRETE:</u>

- PROVIDE 4,500 PSI COMPRESSIVE STRENGTH AT 28 DAYS; 3/4" NOMINAL MAXIMUM AGGREGATE SIZE; AIR CONTENT 6% ± 1.5%; W/C RATIO 0.45 MAXIMUM; SLUMP 5" MAXIMUM W/ NO REDUCER, 6" MAXIMUM W/ MID-RANGE WATER REDUCER, OR 8" MAXIMUM W/ HIGH-RANGE WATER REDUCER AFTER ALL WATER HAS BEEN ADDED. SUBMIT TEST RESULTS TO THE ENGINEER.
- 2. PRIOR TO ORDERING A CONCRETE MIX, SUBMIT A CONCRETE MIX DESIGN TO BE REVIEWED AND APPROVED BY THE ENGINEER. MIX DESIGN SHALL INCLUDE TARGET COMPRESSIVE STRENGTH, TARGET SLUMP, TARGET AIR CONTENT, SIEVE ANALYSIS, WATER REDUCER PRODUCTS (MEETING ASTM C494), AIR ADMIXTURE PRODUCTS (MEETING ASTM C260), AND A CEMENT MILL REPORT NOT OLDER THAN 90 DAYS. CEMENT SHALL BE PER ASTM C150, TYPE II AND SHALL CONTAIN LESS THAN 0.60% EQUIVALENT ALKALIS. IF THE CEMENT CONTAINS 0.60% OR GREATER EQUIVALENT ALKALIS, PROVIDE AGGREGATE ALKALI REACTIVITY TESTING PER ASTM C1260, C1293,
- ALL DESIGN IN ACCORDANCE WITH ACI 318-14 CONCRETE BUILDING CODE. ALL CONCRETE SHALL BE PROVIDED, PLACED, AND MOIST CURED (MIN 7 DAYS) AS PER ALL APPLICABLE SECTIONS OF ACI, AS APPROVED BY THE ENGINEER.
- 4. ALL CONCRETE SHALL BE FIELD TESTED BY AN INDEPENDENT TESTING LABORATORY AS PER ASTM SPECIFICATIONS (PAID FOR BY THE CONTRACTOR). FOR EACH PLACEMENT, ONE SET OF FOUR 4" DIAMETER X 8" TALL STANDARD COMPRESSION TEST CYLINDERS SHALL BE TAKEN AND TESTED IN ACCORDANCE WITH ASTM C39: 1 SPECIMEN TESTED AT 7 DAYS; 2 SPECIMENS TESTED AT 28 DAYS; AND 1 SPECIMEN RETAINED IN RESERVE FOR LATER TESTING IF REQUIRED.
- 5. PRIOR TO INSTALLING STONE VENEER, ALL EXPOSED CONCRETE SURFACES SHALL RECEIVE A GROUT-CLEANED RUBBED FINISH AND SHALL HAVE A SMOOTH AND EVEN SURFACE, FREE OF BUG HOLES, WHEN COMPLETED. FILL MORTAR SHALL CONSIST OF ONE PAR CEMENT TO 1 1/2 PARTS SAND MEETING ASTM C144 OR C404. WORK IN DIRECT HOT SUNLIGHT SHALL BE AVOIDED.

6. <u>CONCRETE ANCHORS</u>

WAYSIDE INN BRIDGE PLAN

THE FOLLOWING ANCHORS SHALL BE USED WHERE CALLED FOR IN THESE DRAWINGS.

ANCHOR SYSTEM HILTI HIT-HY 500-A W/ REBAR DOWELING

MECHANICAL ANCHORS:

ANCHOR

HILTI SS304 KWIK BOLT TZ2-CS W/WASHER

D. <u>CONCRETE REINFORCEMENT (EPOXY-COATED)</u>

- REINFORCEMENT: ASTM A615 GRADE 60 & EPOXY-COATED PER ASTM A775 ALL SPLICES CLASS B (UNO). REINFORCEMENT SHALL BE DETAILED, FABRICATED, AND PLACED AS PER ACI 315 DETAILING MANUAL.
- 2. ALL REINFORCEMENT SHALL BE BENT COLD UNLESS OTHERWISE PERMITTED BY THE

3. PLACING (FIELD INSTALLATION)

- 3.1. EPOXY-COATED REINFORCING BARS SUPPORTED FROM FORMWORK SHALL REST ON COATED WIRE BAR SUPPORTS, OR ON BAR SUPPORTS MADE OF DIELECTRIC MATERIAL OR OTHER ACCEPTABLE MATERIALS. REINFORCING BARS USED AS SUPPORT BARS SHALL BE EPOXY-COATED.
- 3.2. EPOXY-COATED REINFORCING BARS SHALL BE FASTENED WITH NYLON-, EPOXY-, OR PLASTIC-COATED TIE WIRE OR OTHER ACCEPTABLE MATERIALS.
- 3.3. SPLICES OF REINFORCING BARS SHALL BE MADE ONLY AS AUTHORIZED BY THE
- 3.4. REINFORCING BARS PARTIALLY EMBEDDED IN CONCRETE SHALL NOT BE FIELD BENT EXCEPT WHERE SHOWN ON THE DRAWINGS. WHERE REINFORCING BARS ARE FIELD BENT, COATING DAMAGE SHALL BE REPAIRED PER THESE NOTES.

3.5. UNLESS PERMITTED BY THE ENGINEER, REINFORCING BARS SHALL BE NOT BE

- FIELD CUT. WHEN EPOXY-COATED REINFORCING BARS ARE CUT IN THE FIELD, THE ENDS OF THE BARS SHALL BE COATED WITH THE SAME MATERIAL USED FOR REPAIR OF COATING DAMAGE PER THESE NOTES.
- 3.6. EQUIPMENT FOR HANDLING EPOXY-COATED BARS SHALL HAVE PROTECTED CONTACT AREAS. BUNDLES OF COATED BARS SHALL BE LIFTED AT MULTIPLE PICK-UP POINTS TO MINIMIZE BAR-TO-BAR ABRASION FROM SAGS IN THE BUNDLES. COATED BARS OR BUNDLES OF COATED BARS SHALL NOT BE DROPPED OR DRAGGED. COATED BARS SHALL BE STORED ON PROTECTIVE CRIBBING. FADING OF THE COLOR OF THE COATING SHALL NOT BE CAUSE FOR REJECTION OF EPOXY-COATED REINFORCING BARS.
- 3.7. COATING DAMAGE DUE TO HANDLING, SHIPMENT, AND PLACING NEED NOT BE REPAIRED IN CASES WHERE THE DAMAGED AREA IS 0.1 SQUARE INCH OR SMALLER, DAMAGED AREAS LARGER THAN 0.1 SQUARE INCH SHALL BE REPAIRED PER THESE NOTES. THE MAXIMUM AMOUNT OF DAMAGE INCLUDING REPAIRED AND UNREPAIRED AREAS SHALL NOT EXCEED 2 PERCENT OF THE SURFACE AREA OF
- 3.8. WHEN REQUIRED, DAMAGES EPOXY COATING SHALL BE REPAIRED WITH PATCHING MATERIAL CONFORMING TO ASTM A775. REPAIR SHALL BE DONE IN ACCORDANCE WITH THE PATCHING MATERIAL MANUFACTURER'S RECOMMENDATIONS.
- 3.9. COATING DAMAGE DUE TO HANDLING, SHIPMENT, AND PLACING NEED NOT BE REPAIRED IN CASES WHERE THE DAMAGED AREA IS 0.1 SQUARE INCH OR SMALLER. DAMAGED AREAS LARGER THAN 0.1 SQUARE INCH SHALL BE REPAIRED PER THESE NOTES. THE MAXIMUM AMOUNT OF DAMAGE INCLUDING REPAIRED AND UNREPAIRED AREAS SHALL NOT EXCEED 2 PERCENT OF THE SURFACE AREA OF EACH BAR.

E. <u>MASONRY:</u>

- VENEER: BY STONEYARD, INC OR APPROVED EQUAL. COLOR AND STYLE OF MASONRY & GRANITE VENEER SHALL BE SELECTED BY THE CLIENT. ANCHORAGE OF VENEER SHALL BE ANCHORED PER MANUFACTURERS RECOMMENDATIONS.
- 2. ALL STONE FINISHES SHALL HAVE AN AGED FINISH TO BE REVIEWED AND APPROVED BY THE HISTORIC DISTRICTS COMMISSION AT A FUTURE MEETING.
- 3. MORTAR FOR VENEER SHALL CONFORM TO ASTM C270. TYPE N, AND SHALL CONSIST OF THE FOLLOWING PROPORTIONS BY VOLUME: 1 PART TYPE N MORTAR CEMENT 2-1/4 TO 3 PARTS AGGREGATE; OR 1 PART PORTLAND CEMENT, 1/2 TO 1-1/4 PARTS HYDRATED LIME, 2-1/4 TO 3 TIMES THE SUM OF THE CEMENT AND LIME VOLUMES, PARTS AGGREGATE
- 4. MORTAR PIGMENT: MORTAR SHALL BE CHEMICALLY PURE INORGANIC OXIDES IN COMPOUNDS SUITABLY PREPARED FOR USE IN MASONRY MORTAR. COLORS SHALL BE SELECTED BY THE CLIENT.

F. <u>STRUCTURAL STEEL:</u>

- STEEL SHALL COMPLY WITH THE AMERICAN INSTITUTE OF STEEL CONSTRUCTION AISC 360-10 SPECIFICATION FOR STRUCTURAL STEEL BUILDINGS, AISC 303-10 CODE OF STANDARD PRACTICE FOR STEEL BUILDINGS AND BRIDGES AND THE 14TH EDITION OF STEEL CONSTRUCTION MANUAL. ALL STEEL MEMBERS, BOLTS, AND CONNECTIONS SHALL BE DESIGNED TO LOAD AND RESISTANCE FACTOR DESIGN (LRFD).
- 2. STEEL SHALL CONFORM TO ASTM A36 FOR ROLLED SHAPES & PLATES.
- POST-INSTALLED ANCHORS: EXPANSIONS BOLTS ARE PERMITTED WHERE SPECIFICALLY INDICATED ON DRAWINGS AND IN COMPLIANCE WITH PROJECT SPECIFICATION.
- 4. FIELD CUTTING OR DRILLING IN STRUCTURAL MEMBERS IS PROHIBITED, UNLESS PREVIOUSLY APPROVED BY THE STRUCTURAL STRUCTURAL ENGINEER-OF-RECORD.

G. <u>STRUCTURAL STEEL GALVANIZING</u>

- ALL STRUCTURAL STEEL, INCLUDING BOLTS AND CONNECTION ITEMS, SHALL BE
- ACCORDANCE WITH ASTM A123 OR ASTM A153, IN MOLTEN ZINC, PRODUCING A CONTINUOUS COATING OF UNIFORM THICKNESS OF WEIGHT REQUIRED BY THE REFERENCED SPECIFICATIONS.

2. ALL ITEMS SPECIFIED AS GALVANIZED SHALL BE COATED BY THE HOT-DIP PROCESS IN

- 3. GALVANIZING PROCESS SHALL INCLUDE NOT LESS THAN FOUR IMMERSIONS IN COPPER SULFATE IN CONFORMANCE WITH ASTM A239. MINIMUM ACCEPTABLE WEIGHT OF COATING SHALL BE 1.25 OUNCES PER SQUARE FOOT OF SURFACE AS PER ASTM A90
- 4. GALVANIZED ITEMS SHALL BE TAGGED TO INCLUDE THE NAME OF GALVANIZER, THE WEIGHT OF THE COATING, AND APPLICABLE ASTM COMPLIANCE.
- 5. AT LOCATIONS WHERE GALVANIZED STEEL IS FIELD CUT AND AT OTHER LOCATIONS WHERE GALVANIZED COATING IS REMOVED, THE STEEL SURFACE SHALL BE TOUCHED UP WITH A ZINC RICH PAINT MEETING ASTM A780 AND CONTAINING A MINIMUM OF 65% ZINC. THE MINIMUM ACCEPTABLE WEIGHT OF COATING SHALL BE 1.25 OUNCES PER SQUARE FOOT OF SURFACE AS PER ASTM A90.
- IF GALVANIZED STEEL IS TO BE PAINTED, THE GALVANIZED STEEL SHALL NOT BE QUENCHED. IT SHALL BE PHOSPHATIZED, AND PREPARED FOR PAINTING PER ASTM D6386. IT SHALL BE PRIME PAINTED, COMPATIBLE WITH THE FINISH PAINTS SPECIFIED.

F. EXISTING CONDITIONS:


- 4. IT IS THE RESPONSIBILITY OF THE CONTRACTOR TO VERIFY ALL EXISTING CONDITIONS AND DIMENSIONS AS THEY RELATE TO NEW CONSTRUCTION. REPORT TO THE ENGINEER-OF-RECORD ALL OBSERVATIONS AND ANY DISCREPANCIES BEFORE PROCEEDING WITH WORK.
- WHERE DETAILS FOR SPECIFIC CONDITIONS ARE NOT SHOWN ON THESE PLANS, USE DETAILS FOR THE MOST NEARLY SIMILAR CONDITIONS SHOWN ON THE STRUCTURAL DRAWINGS AS DETERMINED BY THE STRUCTURAL ENGINEER. REPORT ANY COORDINATION ISSUES IMMEDIATELY TO THE ENGINEER.
- 6. IT IS THE RESPONSIBILITY OF THE CONTRACTOR TO PROVIDE FOR A SAFE AND EFFICIENT METHOD OF SHORING AND/OR BRACING FOR THE STRUCTURE DURING ALL CONSTRUCTION PHASES. SUBMIT AN OUTLINE OF PROPOSED PROCEDURES BEFORE CONSTRUCTION COMMENCES.
- STRUCTURAL MEMBERS SHALL NOT BE MODIFIED IN THE FIELD WITHOUT WRITTEN APPROVAL FROM THE STRUCTURAL ENGINEER. IN THE EVENT OF A CONSTRUCTION OR FABRICATION ERROR, THE CONTRACTOR SHALL PREPARE A SKETCH WITH A PROPOSED REPAIR, AND SUBMIT IT TO THE ENGINEER FOR APPROVAL PRIOR TO PERFORMING ANY
- VERIFY ALL FIELD DIMENSIONS, LOCATIONS, AND GEOMETRY OF EXISTING STRUCTURES PRIOR TO CONSTRUCTION. ALL EXISTING DIMENSIONS ARE APPROXIMATE. NOTIFY THE ENGINEER IMMEDIATELY OF ANY DISCREPANCY BETWEEN THE FIELD CONDITIONS AND THE CONTRACT DRAWINGS.
- THE CONTRACTOR SHALL TAKE ALL NECESSARY MEASURES TO PROTECT THE EXISTING BUILDING ELEMENTS TO REMAIN DURING DEMOLITION. DO NOT CUT OR ALTER ANY OF THE EXISTING STRUCTURAL OR ARCHITECTURAL ELEMENTS TO REMAIN WITHOUT PRIOR WRITTEN APPROVAL FROM THE ENGINEER. PROVIDE PROTECTION FOR EXISTING WALLS, COLUMNS, BRACES, AND OTHER BUILDING ELEMENTS TO REMAIN FROM FALLING DEBRIS. ANY DAMAGE TO EXISTING ELEMENTS TO REMAIN SHALL BE REPAIRED BY THE CONTRACTOR AT THEIR OWN EXPENSE.

ABBREVIATIONS

& @ % ± ACI ASTM	AND AT PERCENT(AGE) PLUS OR MINUS AMERICAN CONCRETE INSTITUTE AMERICAN SOCIETY OF TESTING MATERIALS	MAX MECH MIN OC OD OCEW	MAXIMUM MECHANICAL MINIMUM ON CENTER OUTSIDE DIAMETER ON CENTER EACH WAY
вот	воттом	PL PLF	PLATE
CIP CLR CONC	CAST-IN-PLACE CLEAR CONCRETE	PSF PSI	POUND(S) PER LINEAR FOOT POUND(S) PER SQUARE FOOT POUND(S) PER SQUARE INCH
DIA	DIAMETER	REF	REFERENCE
DWGS	DRAWINGS	SEOR SS	STRUCTURAL ENGINEER OF RECORD STAINLESS STEEL
EL EMBED EXG	ELEVATION EMBEDMENT EXISTING	T&B TYP	TOP AND BOTTOM TYPICAL
FT FV	FOOT / FEET FIELD VERIFY	UNO	UNLESS NOTIFIED OTHERWISE
FL	FIELD LOCATE	W/	WITH
IN	INCH(ES)		

Woodard 40 Shattuck Road, Suite 110 Andover, Massachusetts 01810 866.702.6371 | www.woodardcurran.com

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ISSUE FOR BID

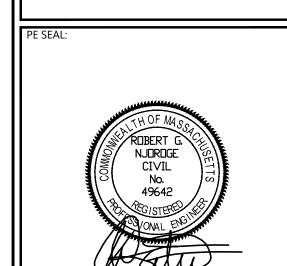TOWN OF SUDBURY **MASSACHUSETTS**

WAYSIDE BRIDGE REPAIRS

EV MM/DD/YY DESCRIPTION 0227202.11 APRIL 2024 AS NOTED CALE.

DESIGNED BY: CSB DRAWN BY: CSB HECKED BY: TJS/JPS II ENIAME. 0227202.08 S-103.dwa DRAWING TITLE:

STRUCTURAL WAYSIDE INN BRIDGE REPAIR

PLAN & SECTION

TOWN OF SUDBURY, MA

PUBLIC WORKS DEPARTMENT

WAYSIDE BRIDGE REPAIRS

ISSUE FOR BID
APRIL 2024










SITE LOCATION MAP

SOURCE: USGS TOPO QUADRANGLE

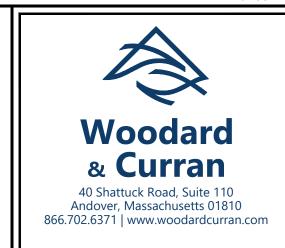

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PE SEAL:

SCUTT C.
SALVUCCI
CIVIL
No. 52343
4/10/2024

***EGISTER

SSONAL ENGINEERING

RESTANCE

ISSUE FOR BID

CLIENT INFO:

TOWN OF SUDBURY MASSACHUSETTS

WAYSIDE BRIDGE REPAIRS

REV MM/DD/YY DESCRIPTION

JOB NO: 0227202.11

DATE: APRIL 2024

SCALE: NONE

DESIGNED BY: KD

DRAWN BY: JBC

CHECKED BY: DS

FILENAME: 0227202.08-G-000.dwg

GENERAL COVER SHEET

DRAWING NO:

- 1. EXISTING CONDITIONS ARE BASED ON A SURVEY PERFORMED BY CHAPPELL ENGINEERING ASSOCIATES, LLC. 201 BOSTON POST ROAD WEST - SUITE 101 MARLBOROUGH, MA 01752. PLAN TITLED, "EXISTING CONDITIONS SURVEY WAYSIDE INN ROAD, SUDBURY, MASSACHUSETTS.", DATED JULY 21, 2021.
- 2. THE HORIZONTAL DATUM DEPICTED ON THE MAPS HEREON IS BASED ON THE MASSACHUSETTS STATE PLANE COORDINATE SYSTEM, MAINLAND ZONE, REFERENCED TO THE NORTH AMERICAN DATUM OF 1983. THE VERTICAL DATUM IS BASED ON THE NORTH AMERICAN VERTICAL DATUM OF 1988 (NAVD 88).
- 3. ANY PROPERTY AND RIGHT OF WAY LOCATIONS THAT MAY BE SHOWN HEREIN ARE APPROXIMATE AND DO NOT REPRESENT A PROPERTY BOUNDARY SURVEY.
- 4. WOODARD & CURRAN ASSUMES NO RESPONSIBILITY FOR DAMAGES INCURRED AS A RESULT OF UTILITIES OMITTED OR INACCURATELY SHOWN.
- 5. COORDINATE CONSTRUCTION ACTIVITY WITH UTILITY COMPANIES, EMERGENCY SERVICES AND TOWN. CONTRACTOR SHALL NOTIFY ALL UTILITIES PRIOR TO COMMENCING WORK, ALLOWING SUFFICIENT TIME TO LOCATE AND MARK THE LOCATION OF BURIED UTILITIES. CONTRACTOR SHALL CONTACT "DIG SAFE", TELEPHONE 811, PRIOR TO EXCAVATION.
- 6. RESTORE ALL AREAS DISTURBED BY CONTRACTOR'S OPERATIONS TO ORIGINAL FINISH (GRAVEL, PAVEMENT, GRASS, ETC.) UNLESS NOTED OTHERWISE ON THE PLANS. RESTORATION OF PAVED SURFACES, GRAVEL SURFACES, DRIVEWAYS, AND LAWNS DAMAGED BY CONSTRUCTION ACTIVITIES SHALL BE PERFORMED AT NO ADDITIONAL COST TO OWNER. ANY CURB DAMAGED BY CONSTRUCTION ACTIVITIES SHALL BE REPLACED IN KIND AND SHALL CONFORM TO TOWN OF SUDBURY AND MASSACHUSETTS DOT SPECIFICATIONS AT NO ADDITIONAL COST TO OWNER.
- 7. PROPERLY PROTECT AND DO NOT DISTURB PROPERTY IRONS AND MONUMENTS. IF DISTURBED, THE PROPERTY MONUMENT SHALL BE RESET AT THE CONTRACTOR'S EXPENSE BY A LICENSED LAND SURVEYOR ACCEPTABLE TO THE TOWN.
- 8. EXISTING FACILITIES (I.E. TREES, JERSEY BARRIERS, STONE, ETC.) SHALL BE REMOVED AND PROTECTED DURING CONSTRUCTION. THE TOWN RETAINS RIGHT TO KEEP ANY AND ALL REMOVED FACILITIES. CONTRACTOR SHALL DISPOSE OF ANY REMOVED FACILITY AT THE REQUEST OF THE TOWN AT NO ADDITIONAL COST TO OWNER.
- 9. ALL TREES NOT NOTED TO BE REMOVED OR RELOCATED SHALL BE PROTECTED BY CONTRACTOR DURING CONSTRUCTION.
- 10. DO NOT PARK, IMPEDE ACCESS TO, OR STORE EQUIPMENT BEYOND LIMIT OF WORK, UNLESS PERMISSION HAS BEEN GRANTED IN WRITING BY TOWN AND/OR LAND OWNER.
- 11. RESTRICT ACCESS TO SITE THROUGH THE USE OF APPROPRIATE SIGNAGE, BARRIERS, FENCES, ETC. SITE SHALL BE LEFT WITH APPROPRIATE SAFETY MEASURES IN PLACE DURING NON-WORKING HOURS. SITE SAFETY IS THE RESPONSIBILITY OF CONTRACTOR, DURING BOTH WORKING AND NON-WORKING
- 12. CONTRACTOR IS RESPONSIBLE FOR OBTAINING ALL NECESSARY CONSTRUCTION PERMITS INCLUDING "PERMIT TO CONSTRUCT WITHIN A PUBLIC WAY" FROM THE TOWN. PERMIT APPLICATIONS SHALL BE SUBMITTED WITH ADEQUATE TIME SO AS NOT TO DELAY CONSTRUCTION.
- 13. ALL WORK ASSOCIATED WITH THE PROJECT SHALL BE COMPLETED IN ACCORDANCE WITH THE TOWN OF SUDBURY BYLAW AND LOCAL REGULATIONS AND MASSACHUSETTS DOT STANDARD SPECIFICATIONS.
- 14. UPON COMPLETION OF CONSTRUCTION, A COMPLETE SET OF "RECORD" DRAWINGS SHALL BE SUBMITTED TO THE TOWN ENGINEER. THESE DRAWINGS SHALL BE SUBMITTED IN BOTH DIGITAL AND HARD COPY FORMAT AS DEFINED IN THE SPECIFICATIONS PRIOR TO PAYMENT OF FINAL RETAINAGE.
- 15. PROTECTION OF EXISTING UTILITIES DURING CONSTRUCTION SHALL BE PROVIDED AT NO ADDITIONAL
- 16. CONTRACTOR SHALL BE RESPONSIBLE FOR SWEEPING WAYSIDE INN ROAD EVERY FRIDAY AND AS NECESSARY DURING THE DURATION OF THE WORK.
- 17. PRIOR TO CONSTRUCTION, CONTRACTOR SHALL ATTEND A PRE-CONSTRUCTION MEETING HELD AT THE PROJECT SITE WITH THE CONTRACTOR, ENGINEER, AND OWNER TO REVIEW THE CONSTRUCTION SCHEDULE AND SEQUENCING, STOCKPILE LOCATIONS AND CRITICAL ASPECTS OF THE PROJECT.
- 18. ALL DISTURBED UPLAND AREAS SHALL BE BROUGHT TO FINAL GRADE AND SHALL BE PERMANENTLY STABILIZED WITHIN 30 DAYS AFTER DISTURBANCE. BARE GROUND AND DISTURBED AREAS THAT CANNOT BE PERMANENTLY VEGETATED WITHIN 30 DAYS SHALL BE TEMPORARY STABILIZED BY AN APPROVED
- 19. CONTRACTOR SHALL DEMARCATE CONSTRUCTION EQUIPMENT AND MATERIAL STORAGE AREAS PRIOR TO CONSTRUCTION.
- 20. THE CONSTRUCTION SITE SHALL BE MAINTAINED IN CLEAN CONDITIONS AT ALL TIMES AND CONSTRUCTION REFUSE AND DEBRIS SHALL BE DISPOSED OF PROMPTLY AND IN A LEGAL MANNER.
- 21. STORING, SERVICING, OR CLEANING OF TRUCKS OR EQUIPMENT SHALL BE PERFORMED IN AN UPLAND AREA AT A HORIZONTAL DISTANCE GREATER THAN 100 FEET FROM THE WATERBURY AND ASSOCIATED RESOURCE AREAS.

EROSION CONTROL NOTES

- 22. EROSION CONTROL DEVICES SHALL REMAIN IN PLACE, UNTIL ALL DISTURBED SURFACES HAVE BEEN STABILIZED WITH FINAL VEGETATION COVER OR THE OWNER HAS AUTHORIZED THEIR REMOVAL.
- 23. EROSION CONTROL MEASURES AND BARRIERS SHALL BE MONITORED DAILY AND MAINTAINED, OR REINFORCED AS NECESSARY TO ENSURE AND PREVENT EROSION AND SILTATION OF SOILS TO WETLAND RESOURCE AREAS. ADDITIONAL FILTER FABRIC AND STRAW WATTLES SHALL BE STORED ON SITE FOR EMERGENCY USE.
- 24. DURING ALL PHASES OF CONSTRUCTION, ALL DISTURBED OR EXPOSED AREAS OUTSIDE THE ROADWAY SHALL BE BROUGHT TO FINISHED GRADE AND EITHER A) LOAMED AND SEEDED FOR PERMANENT STABILIZATION, IN ACCORDANCE WITH U.S. SOIL CONSERVATION SERVICE PROCEDURES, OR B) STABILIZED IN ANOTHER WAY APPROVED BY THE COMMISSION. AREAS THAT CANNOT BE PERMANENTLY STABILIZED WITHIN 30 DAYS OF DISTURBANCE SHALL BE STABILIZED WITH HAY, STRAW, MULCH OR ANY OTHER PROTECTIVE COVERING AND/OR METHOD APPROVED BY THE U.S. DEPARTMENT OF AGRICULTURE SOIL CONSERVATION SERVICE OR BY OTHER TEMPORARY MEASURES ACCEPTABLE TO THE COMMISSION.
- 25. AN ADEQUATE STOCKPILE OF EROSION AND SEDIMENTATION CONTROL MATERIALS SHALL BE ON SITE AT ALL TIMES FOR EMERGENCY OR ROUTINE REPLACEMENT.
- 26. ANY DAMAGE CAUSED AS A DIRECT RESULT OF CONSTRUCTION TO THE RESOURCE AREAS SHALL BE REPAIRED, RESTORED AND/OR REPLACED. SEDIMENTATION OR EROSION SHALL BE CONSIDERED DAMAGE TO THE RESOURCE AREAS. IF SEDIMENTATION REACHES THESE AREAS, THE CONSERVATION COMMISSION SHALL BE CONTACTED AND A PLAN FOR THE PROPOSED RESTORATION SHALL BE SUBMITTED FOR
- 27. THE SILT FENCE AND STRAW BALES MUST BE INSPECTED PRIOR TO THE START OF ANY WORK OR A \$100 PER DAY FINE WILL BE LEVIED ON THE CONTRACTOR.

ABBREVIATIONS

GRAN.

HDPE

HYD

INV.

N.T.S.

LLS

DESCRIPTION

PROP.

MASSDEP

AND

GAS SERVICE

GALVANIZED

HIGH DENSITY POLYETHYLENE

HIGH DENSITY POLYPROPYLENE

MASSACHUSETTS DEPARTMENT OF

GRANITE

HYDRANT

INVERT

LINEAR FEET

NOT TO SCALE

PLUS OR MINUS

OVERHEAD

PROPOSED

OVERHEAD ELECTRIC

LICENSED LAND SURVEYOR

A.G.	ABOVE GROUND	
BIT B/W BVW	BITUMINOUS BETWEEN BORDERING VEGETATED WETLAND	SHEET INDEX
СВ	CATCH BASIN	GENERAL
CI CMP	CAST IRON CORRUGATED METAL PIPE	G-000 COVER SHEET
CONC	CONCRETE	G-001 GENERAL NOTES, LEGEND, AND ABBREVIATIONS
D DI	STORM DRAIN DUCTILE IRON	CIVIL
DIA. DMH	DIAMETER DRAIN MANHOLE	C-100 EXISTING CONDITIONS
DOT	DEPARTMENT OF TRANSPORTATION	C-200 SITE PLAN
DTL. DYL	DETAIL DOUBLE YELLOW LINE	C-300 CIVIL DETAILS - 1
E	UNDERGROUND ELECTRICAL	C-301 CIVIL DETAILS - 2
EL. E.O.P. EXIST.	ELEVATION EDGE OF PAVEMENT EXISTING	STRUCTURAL
FF	FINISH FLOOR	S-101 WAYSIDE INN BRIDGE REPAIRS SITE PLAN, NOTES, EXISTING CONDITIONS, AND DEMOLITION PLAN
FT	FOOT/FEET	S-102 WAYSIDE INN BRIDGE REPAIRS PROPOSED PLAN AND SECTION
G	GAS MAIN	S-103 WAYSIDE INN BRIDGE REPAIR PLAN & SECTION

RESOURCE AREA LEGEND

	ENVIRONMENTAL PROTECTION	BORDERING LAND SUBJECT TO FLOODING
MADOT	MASSACHUSETTS DEPARTMENT OF	(100 YEAR FLOOD ZONE, DEFINED BY FEMA)
	TRANSPORTATION	
MAX.	MAXIMUM	
MIN.	MINIMUM	
MON	MONUMENT	<u>NOTE</u> :
N.I.C. NO.	NOT IN CONTRACT NUMBER	A RESOURCE AREA DELINEATION WAS NOT CONDUCTED AS PART OF THIS PROJECT.
NO. NR	NO REFUSAL	

LINE TYPES & HATCHES


PT. PVC	POINT POLYVINYL CHLORIDE	DESCRIPTION	<u>EXISTING</u>	<u>PROPOSED</u>
R.O.W.	RIGHT-OF-WAY	CONTOUR (1' INTERVAL)		
RCP	REINFORCED CONCRETE PIPE	CONTOUR (INDEX)		
REINF. REQ'D	REINFORCED REQUIRED	EDGE OF PAVEMENT		
RPP	RIBBED PLASTIC PIPE	OVERHEAD ELECTRIC	OE	
S	SLOPE (FT./FT.)	UNDERGROUND GAS	G	
S SMH	SEWER SEWER MANHOLE	RIGHT OF WAY/ PROPERTY LI	INE	
SCH STA.	SCHEDULE STATION	GUARDRAIL		
SWL	SINGLE WHITE LINE	LIMIT OF WORK		LW
TOWN	TOWN OF SUDBURY	SEDIMENT BARRIER		
TYP.	TYPICAL	SAWCUT		
UNO	UNLESS NOTED OTHERWISE	STONE WALL	·	
UP	UTILITY POLE	DOUBLE YELLOW LINE		
VC VI	VITRIFIED CLAY	SINGLE WHITE LINE		
		- · · · · · · · · · · · · · · · · · · ·		

CENTERLINE

SYMBOLS

WITH

DESCRIPTION	<u>EXISTING</u>	<u>PROPOSED</u>
PK NAIL		
UTILITY POLE	ø	
TREE/STUMP		
SIGN	- 0-	
STEEL POST		-
CONCRETE ANCHOR		
BRIDGE PARAPIT		
STEEL BACKED TIMBER GAURDRAIL		
TEMPORARY BARRIER		

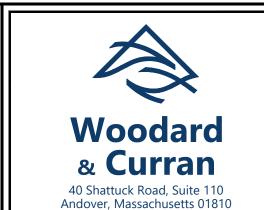

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ISSUE FOR BID

TOWN OF SUDBURY **MASSACHUSETTS**


WAYSIDE BRIDGE REPAIRS


REV MM/DD/YY DESCRIPTION 0227202.11

APRIL 2024 SCALE: NONE DESIGNED BY: KD DRAWN BY: CHECKED BY: DS II FNAMF 0227202.08-G-001.dwa

DRAWING TITLE: **GENERAL**


GENERAL NOTES, LEGEND, AND ABBREVIATIONS

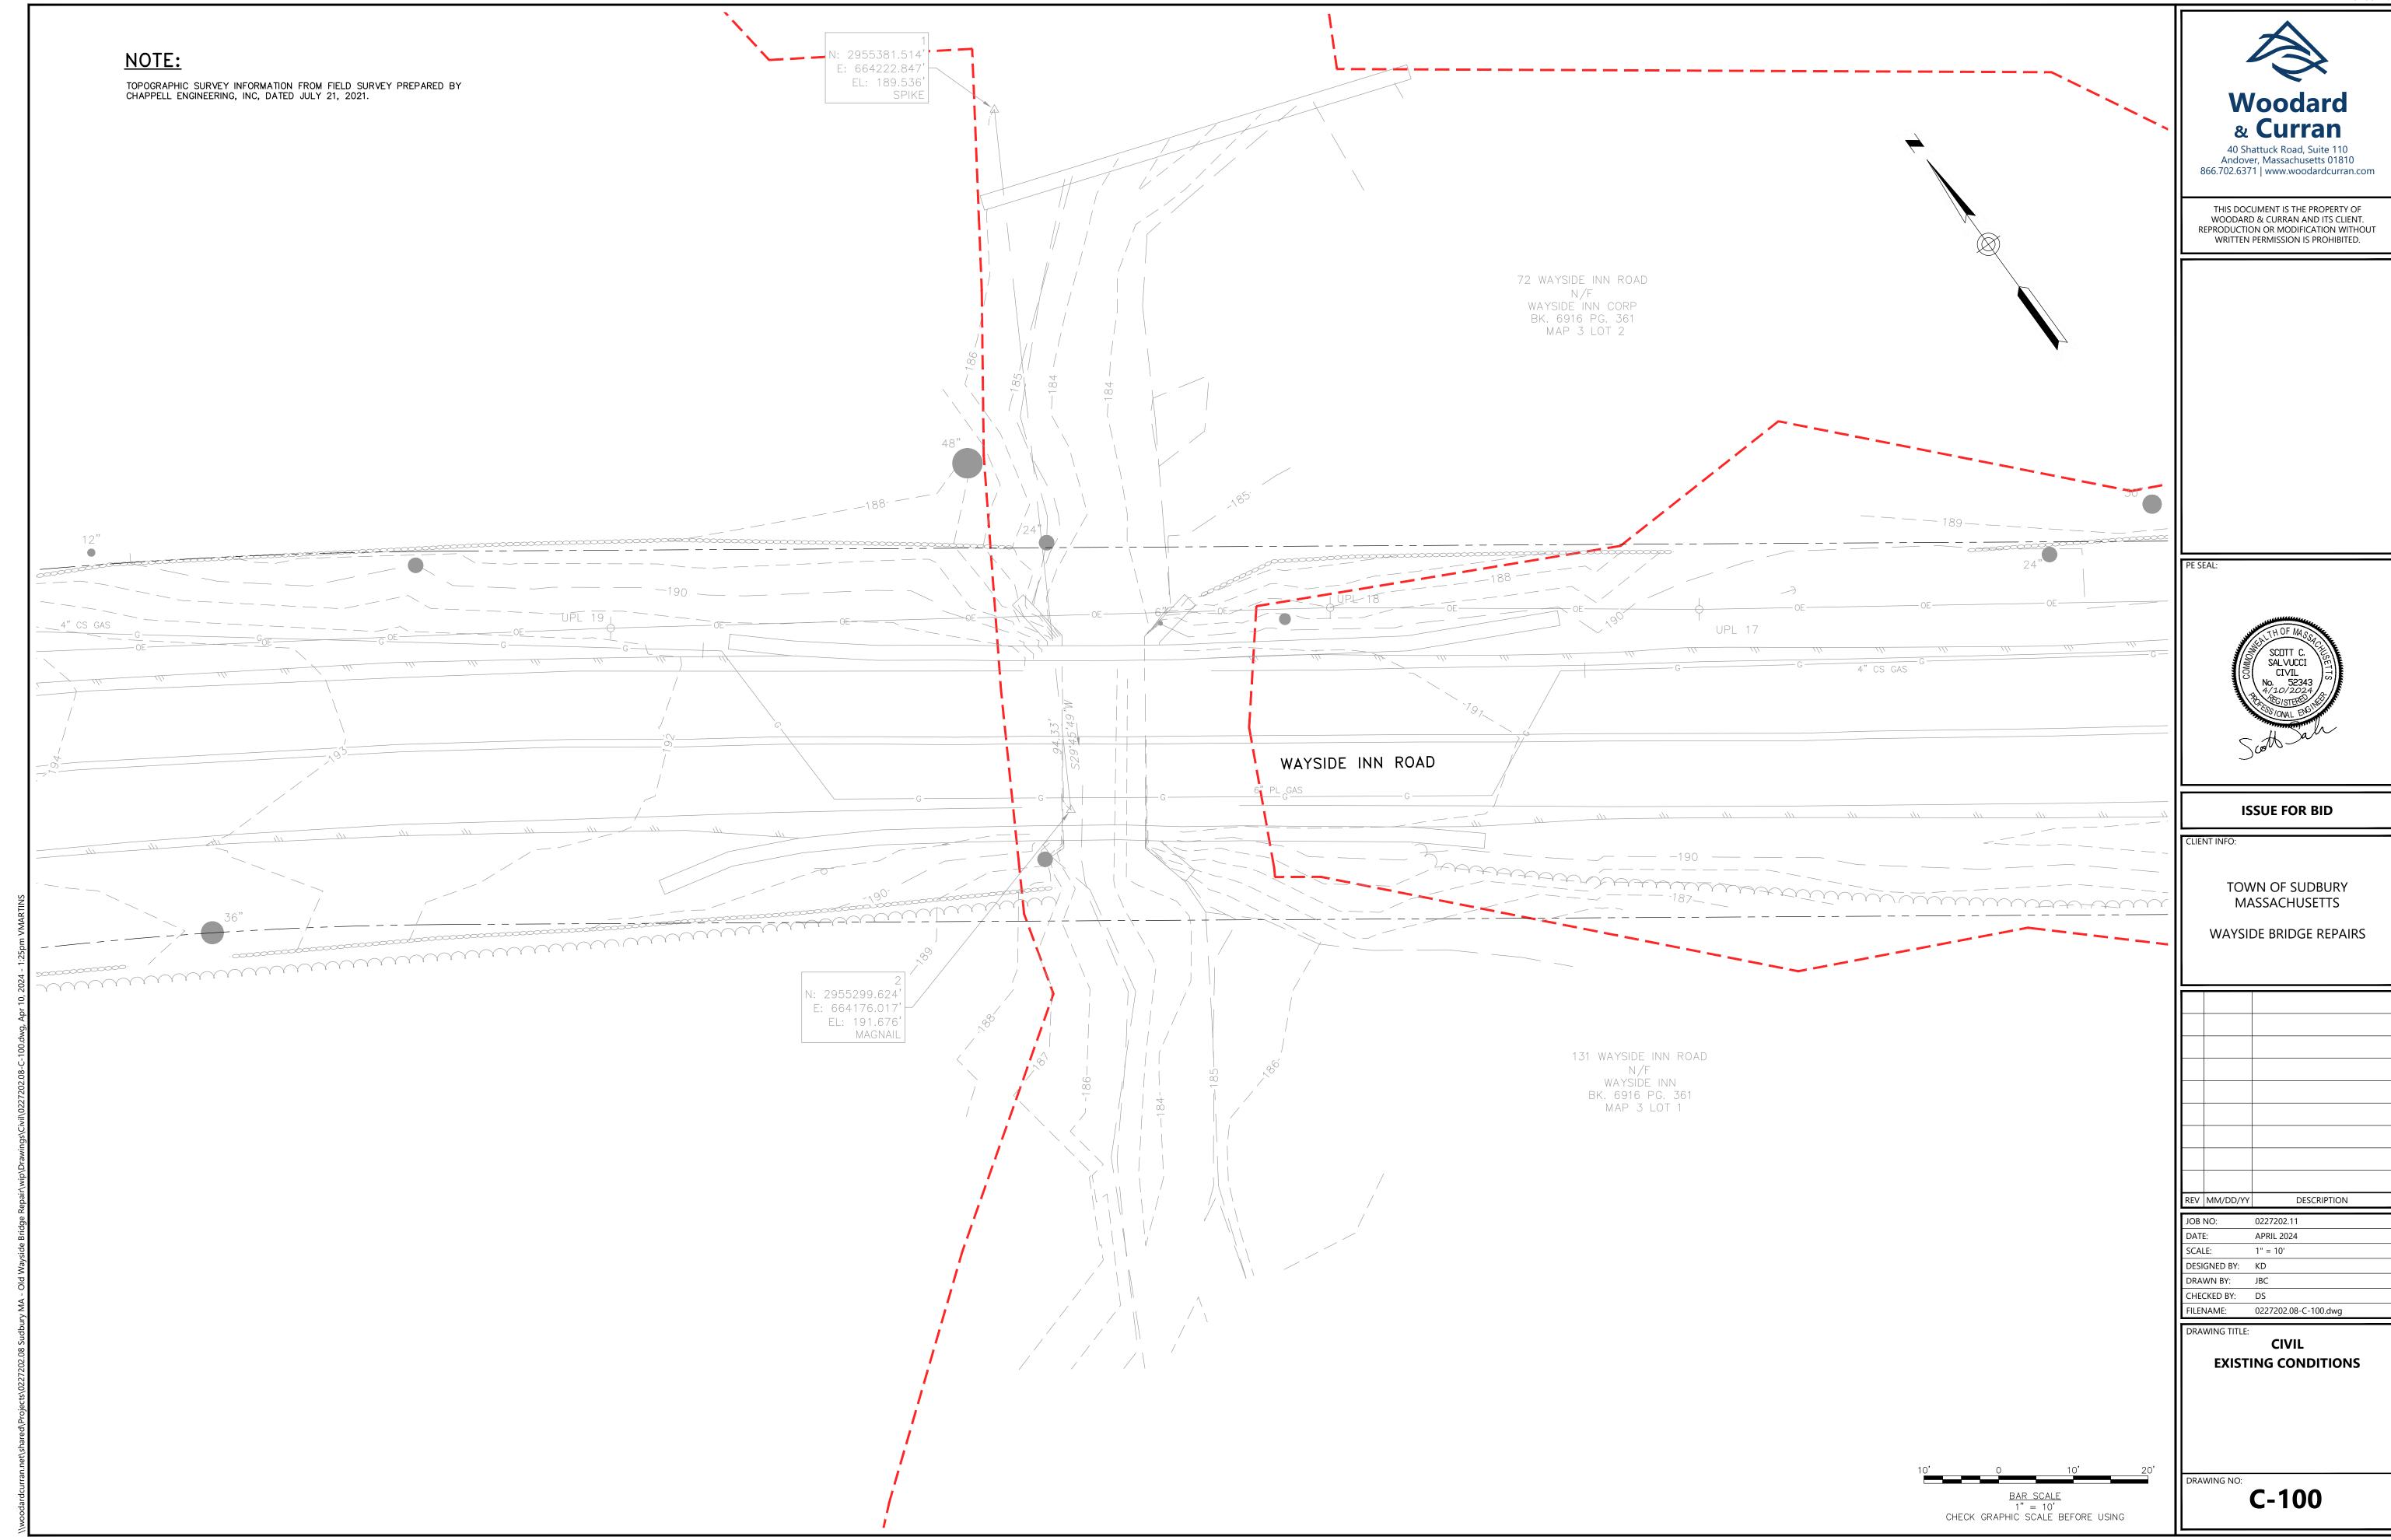

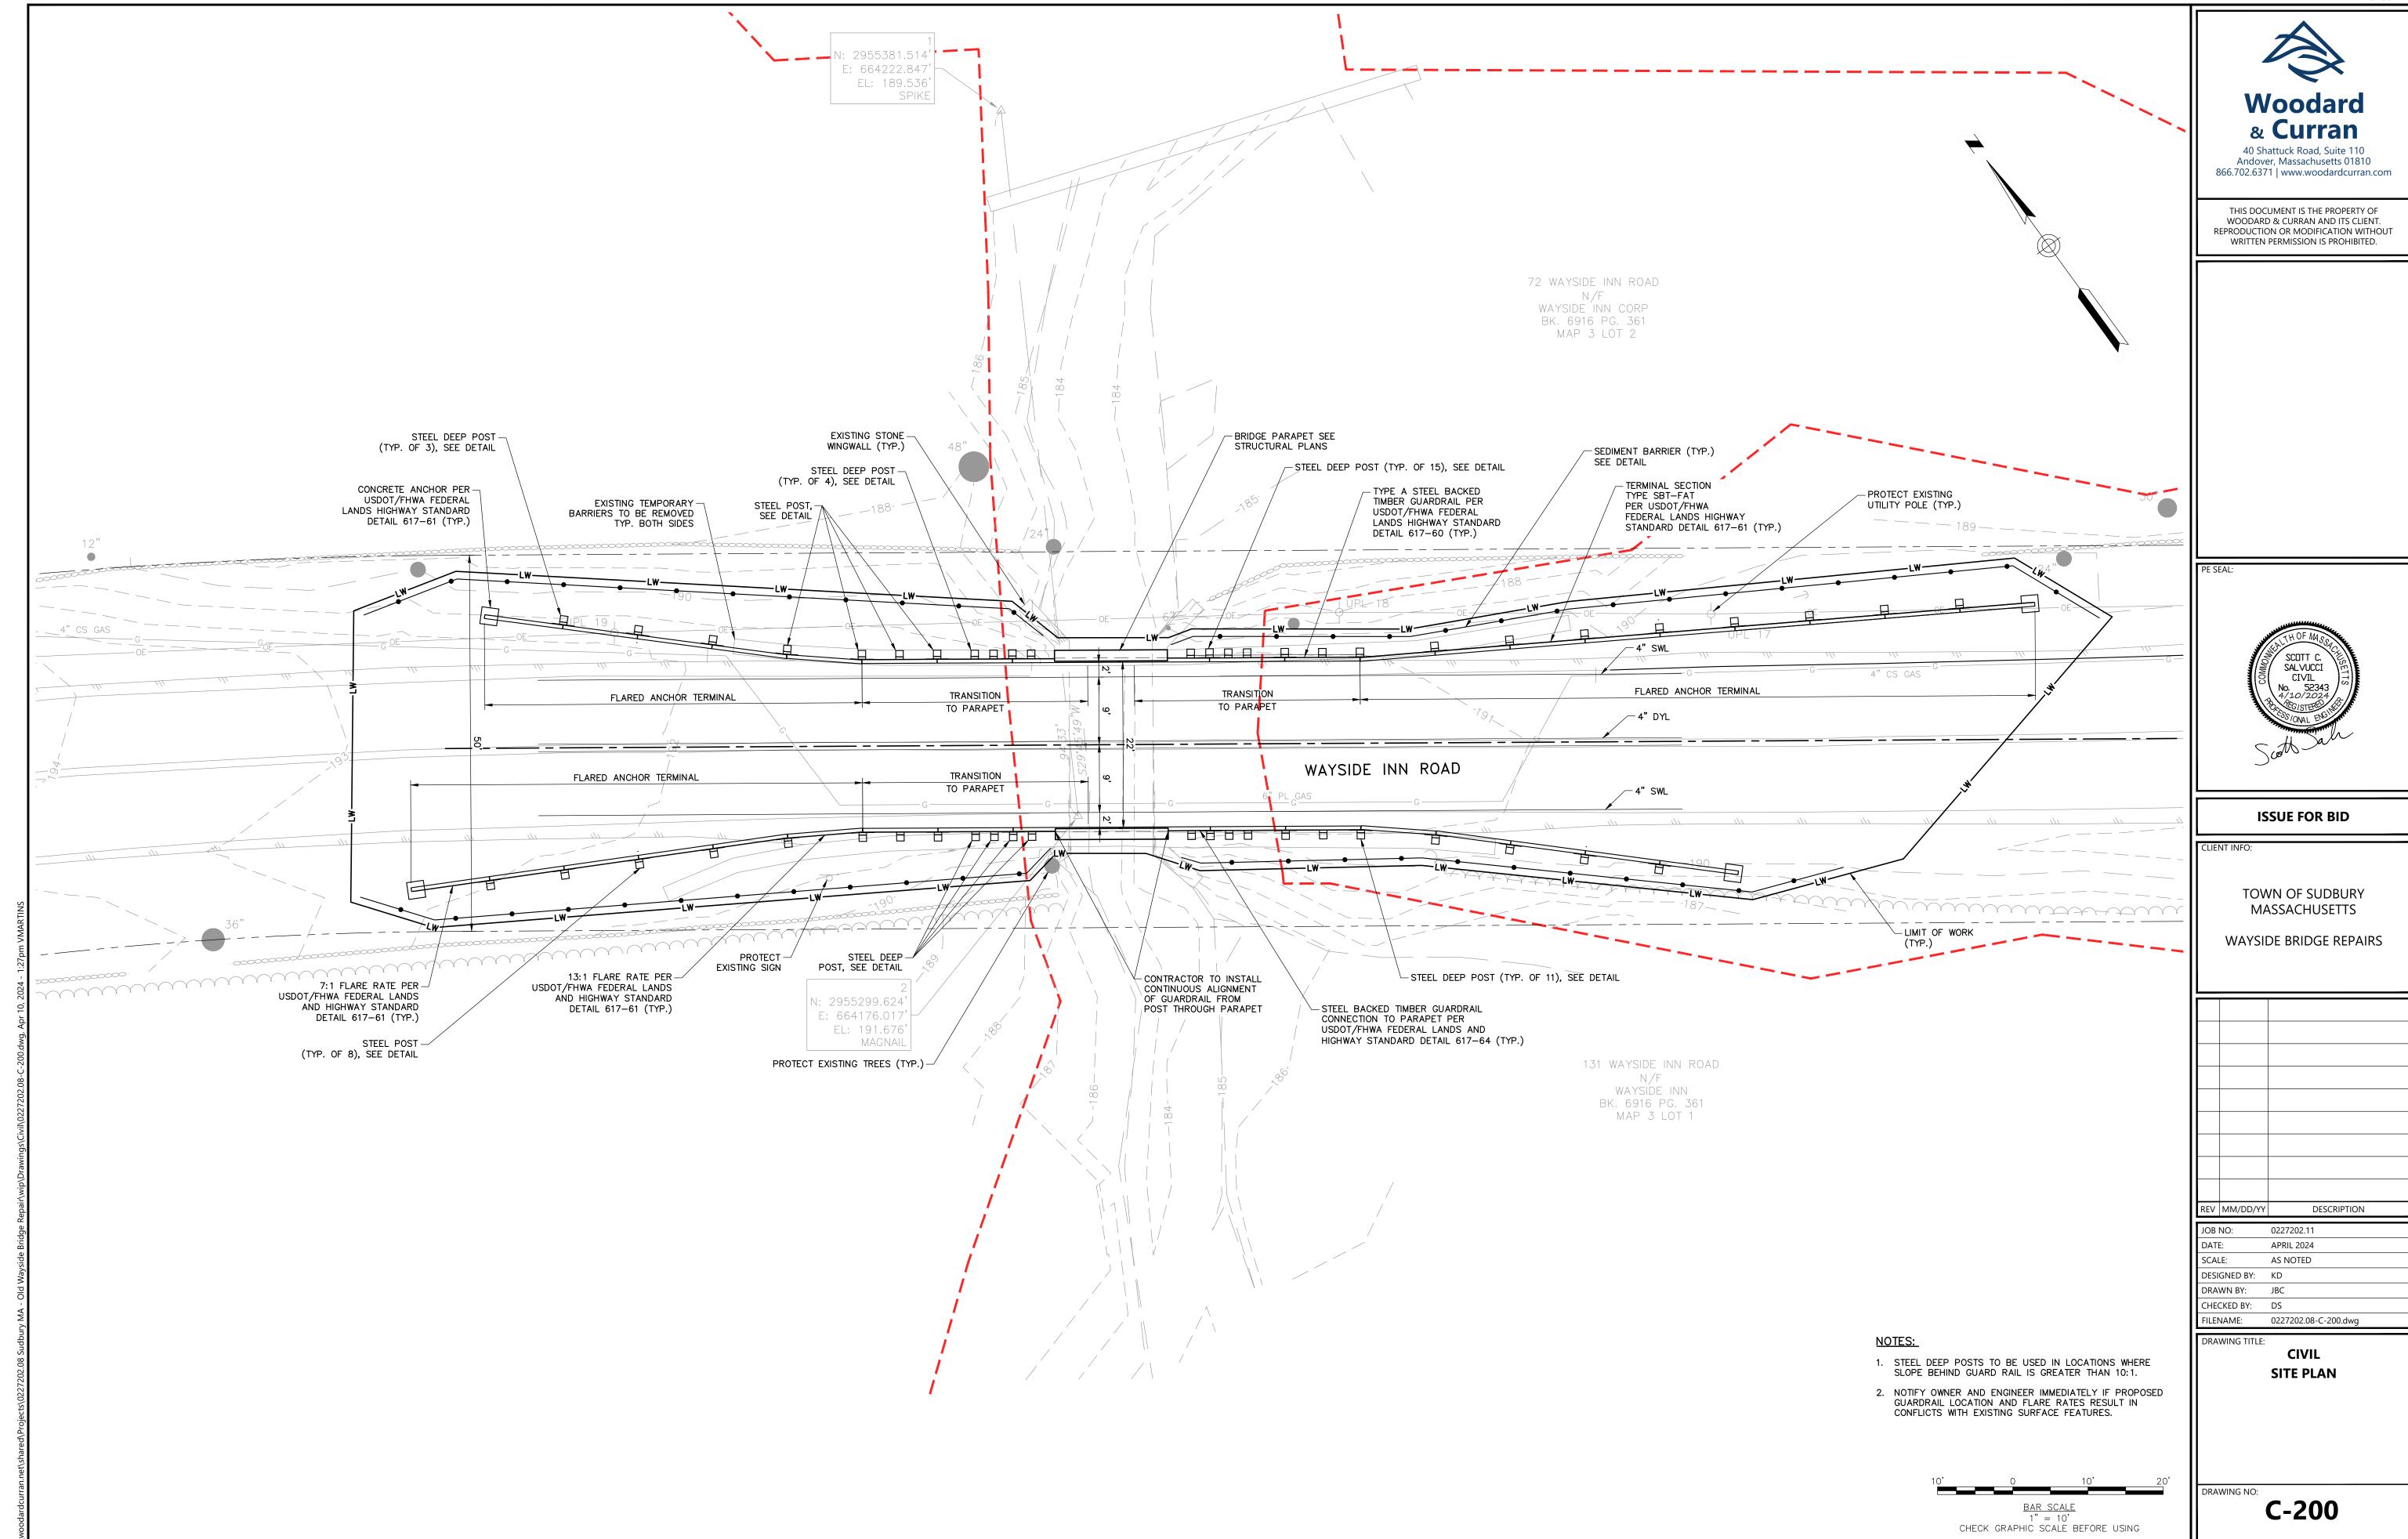


- DETAIL PER MASSDOT CONSTRUCTION STANDARD DETAILS DRAWING NUMBER 400.1.4.
- 2. DEEP STEEL POSTS SHALL ONLY BE USED WHERE INDICATED ON THE PLANS.
- 3. GUARDRAIL POSTS SHALL BE POWDER COATED BROWN.
 OWNER TO APPROVE OF COLOR PRIOR TO ORDERING POSTS.

STEEL POST DETAIL

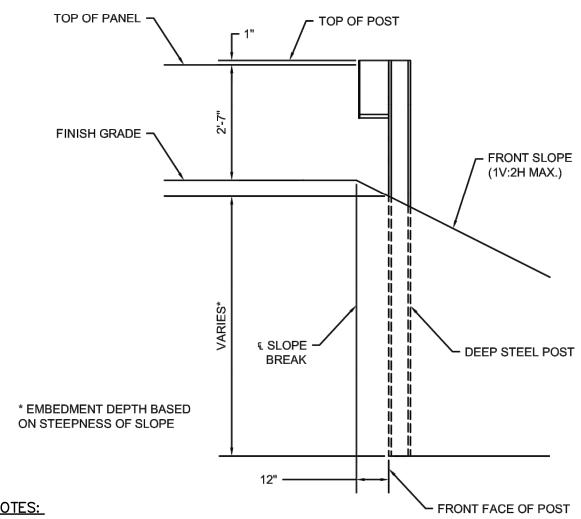

- DETAIL PER MASSDOT CONSTRUCTION DETAILS DRAWING NUMBER 400.1.5.

SLOPE BREAK CONDITION STEEL DEEP POST DETAIL

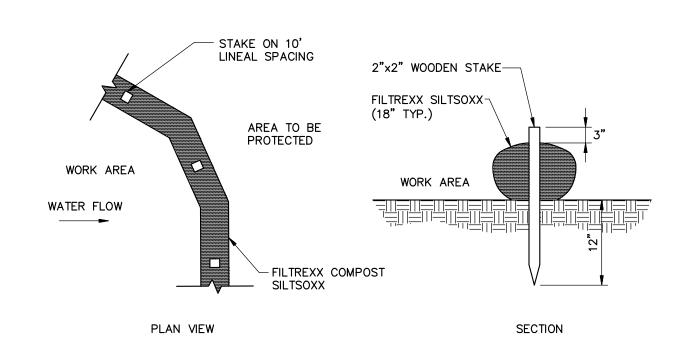

SEDIMENT BARRIER - SILTSOXX
N.T.S.

EROSION AND SEDIMENT CONTROL NOTES

Temporary Erosion Control


Measure	Dates For Use	Timing, Activity, and Location
Sedimentation Barrier	ALL	Before soil disturbance, install downhill of areas to be disturbed and around material stockpiles.
Up-slope Diversion	ALL	Before soil disturbance, install uphill of areas to be disturbed and material stockpiles.
Catch Basin Protection	ALL	Before soil or pavement disturbance, install ACF Environmental, Inc. High Flow Siltsack, Siltsaver Inlet Filter. or equal, installed per manufacturer's requirements.
Dust Control	ALL	During dry weather, apply water and calcium chloride to control dust.
Temporary Seeding	April 15 to Oct. 15	Soil stockpiles that are not covered and disturbed areas that will not be disturbed again within 14 days. If grass growth provides less than 95% soil coverage by Nov. 1, apply mulch and anchor with erosion control blanket.
Mulch	April 15 to Sept. 15	On all areas of exposed soil prior to rain events apply 100—150 lbs (2.5 bales) per 1,000 sq ft. by mechanical blower.
Winter Mulch	Sept. 16 to Oct. 31	On all areas of exposed soil prior to precipitation apply 150 to 170 lbs. mulch (4 bales) per 1,000 sq. ft. by mechanical blower. Erosion control blanket may be used as a substitute for winter mulch.
	Nov. 1 to April 14	On all areas of exposed soil, apply 150 to 170 lbs. mulch (4 bales) per 1,000 sq. ft. and anchor with netting <u>at the end of each working day.</u> Erosion control blanket may be used as a substitute for winter mulch.
Inspections	Until site is permanently stabilized	Inspect the erosion and sedimentation control measures daily, and after rainfall of half inch or greater in a 24—hour period, and maintain and repair as necessary.

Permanent Erosion Control:

Measure	Dates For Use	Timing, Activity, and Location
Pavement — Base Course — Final Course		Install only in areas shown on the plan, shortly after pavement base is brought to final grade. Install near completion of project.
Permanent Seeding	April 15 to Sept. 15	On final grade areas, within 7 days of grade preparation, prepare topsoil, followed by seed and mulch application.
Dormant Seeding	Sept. 16 to April 15	On final grade areas, with prepared topsoil. Apply seed at double the specified rate on bare soil, and follow with an application of winter mulch.
Ground Cover, Trees, Shrubs	April 15 to Nov. 1	Install with final landscaping.
Permanent Mulch	ALL	Install with final landscaping.

Regular inspections of all erosion and sedimentation controls shall be made at least weekly and prior to and following storm events. Minimum inspections shall be made as listed in the table below.

Inspected Item	Look For
Mulched Surfaces	Thin mulch or inadequate application. Wind movement.
Seeded Surfaces	Poor seed germination. Loss of mulch. Development of rivulets.
Sediment Barrier	Sediment build—up to one half the height of the barrier. Undermining of the barrier. Supporting stakes loose, toppled, or unmarked. Breaks in barrier.
Perimeter Diversion	Discharge is to stabilized area. Erosion or breaks in barrier. Supporting stakes loose, toppled or unmarked.
Catch Basin Protection	Sediment build—up and structure blockages. Slow flow/Ponding water. Breaks in fabric or voids in barrier.
Dewatering Filter	Breaks in fabric or supporting structure. Slow flow, indicating high sediment build—up.
Construction Entrance	Sedimentation of roadways. Off—site dust complaints.

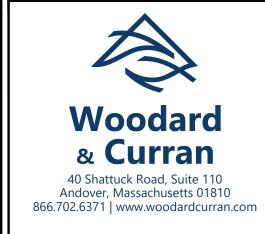

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ISSUE FOR BID

TOWN OF SUDBURY MASSACHUSETTS


WAYSIDE BRIDGE REPAIRS

REV MM/DD/YY DESCRIPTION


APRIL 2024 SCALE: AS NOTED DESIGNED BY: KD DRAWN BY: JBC FILENAME: 0227202.08-C-300.dwg

CIVIL **CIVIL DETAILS - 1**

C-300

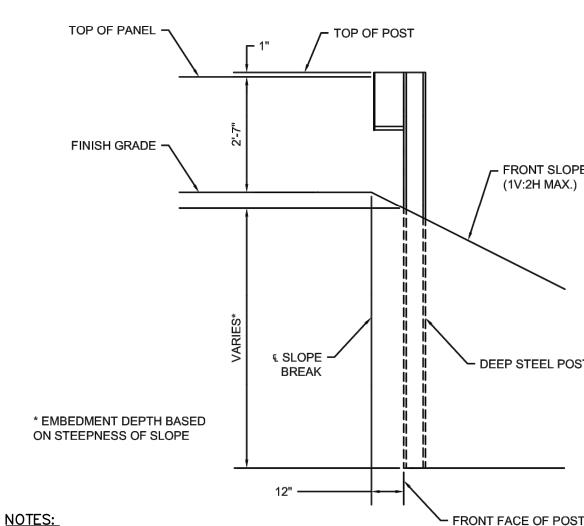

DEEP STEEL POSTS SHALL ONLY BE USED WHERE INDICATED ON THE PLANS.

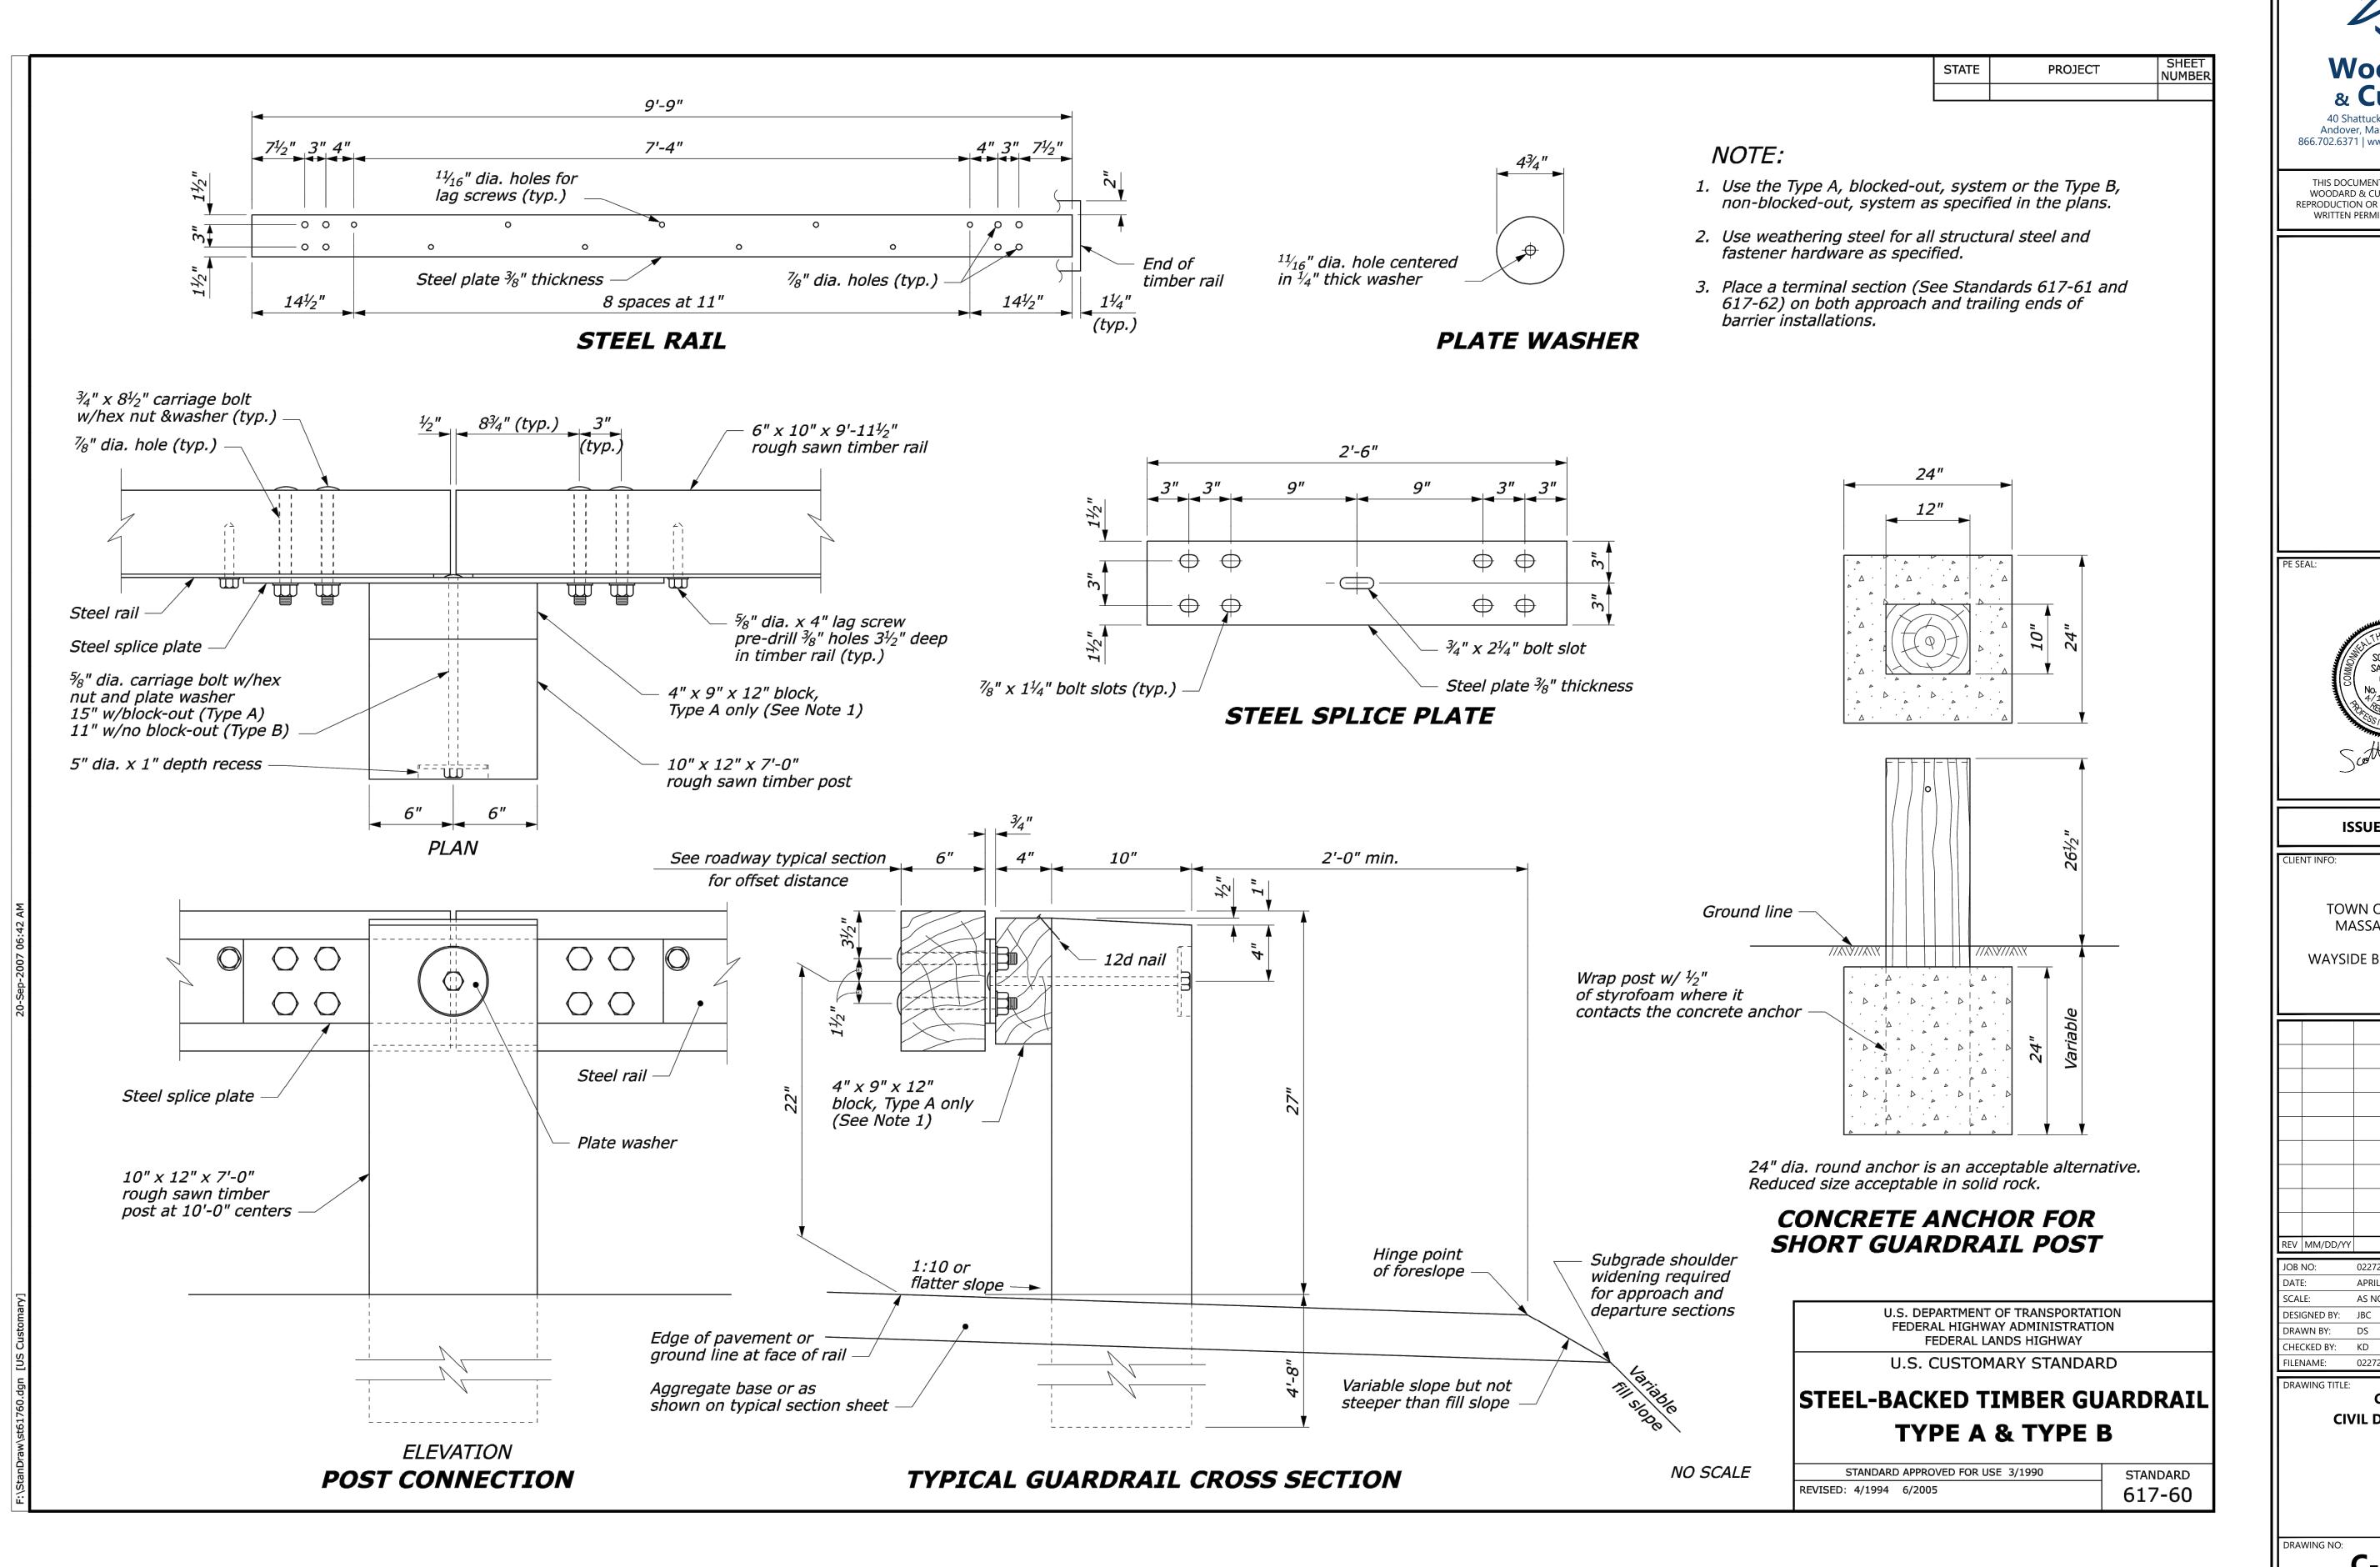

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SALVUCCI CIVIL

ISSUE FOR BID

TOWN OF SUDBURY **MASSACHUSETTS**

WAYSIDE BRIDGE REPAIRS

DESCRIPTION APRIL 2024 AS NOTED

0227202.08-C-300.dwg

CIVIL

CIVIL DETAILS - 2

C-301

1. **GOVERNING CODES**

1.1. MASS STATE BUILDING CODE 780 CMR NINTH EDITION
1.2. MASSDOT LRFD BRIDGE MANUAL 2013
1.3. ACI 318-14

2. <u>DESIGN LOADS AND CRITERIA</u>

2.1. BASIC DESIGN PARAMETERS
PROJECT ADDRESS:
PROJECT LOCATION:
LAT 42.357°
LONG -71.470°
GENERAL ELEVATION 188-FT

2.1. <u>DEAD LOADS</u> ACTUAL

2.2. <u>LIVE LOADS</u> IMPACT LOAD

3. DEMO OR DEMOLISH SHALL MEAN TO REMOVE AND LEGALLY DISPOSE OF ITEM(S)

10,000 LBS

MATERIAL NOTES SPECIFICATIONS

A. CONCRETE: CURB

CONCRETE

PORTLAND CEMENT

FLY ASH

WATER / CEMENTITIOUS RATIO

COMPRESSIVE STRENGTH
ENTRAINED AIR

SLUMP

ASTM C150, TYPE I OR II

ASTM C618 C OR F, 20% MIN BY WEIGHT

0.40 MAX

f'c = 5000 PSI
6% ± 1.5%

4 IN +/- 1 IN

- 1.1. USE ONE BRAND OF CEMENT THROUGHOUT PROJECT, UNLESS OTHERWISE
- ACCEPTABLE TO THE ENGINEER OF RECORD.

 1.2. WATER SHALL BE CLEAN AND FREE FROM DELETERIOUS AMOUNTS OF OIL, ACIDS, ALKALIS, ORGANIC MATERIAL, AND OTHER FOREIGN MATTER AND SHALL CONFORM
- 10 ASIM C94

 1.3. CONCRETE MIX SHALL MEET MASS DOT STANDARDS FOR INTENDED SERVICE.

2. <u>EPOXIED REINFORCING:</u>
DEFORMED BAR
EPOXY COATING

ASTM A615, GRADE 60 ASTM A775

B. CONCRETE ANCHORS

3. <u>POST_INSTALLED - ADHESIVE</u>

ANCHOR DEFORMED BAR ASTM A615, GR 60
ADHESIVE HILTI HIT—RE 500 V3
EXG CONC STRENGTH 3,000 PSI, CRACKED (ASSUMED)

ALTERATION OF EXISTING STRUCTURES

- 1. THE CONTRACTOR SHALL BE RESPONSIBLE FOR ANY TEMPORARY MODIFICATIONS AND REPLACEMENT TO EXISTING BRIDGE COMPONENTS AS REQUIRED FOR THE INSTALLATION OF THE NEW PARAPET.
- 2. CONTRACTOR SHALL PROVIDE WRITTEN PLANS DETAILING THE SEQUENCE, PROCEDURE, AND PROPOSED EQUIPMENT FOR REVIEW BY THE ENGINEER OF RECORD PRIOR TO BEGINNING THE WORK.

CONCRETE NOTES

1. CONCRETE REINFORCEMENT FABRICATION

- 1.1. REINFORCEMENT DETAILING SHALL BE DONE IN CONFORMANCE WITH ACI SP-66, CURRENT EDITION.
- 1.2. FABRICATOR SHALL TAG ALL REINFORCEMENT FOR PROPER PLACEMENT IF SHOP FABRICATED. REINFORCING SHALL BE BENT PER CRSI 10 MANUAL OF STANDARD PRACTICE.

2. CONCRETE AND REINFORCEMENT PLACEMENT

- 2.1. PERFORM CONCRETE WORK IN ACCORDANCE WITH CURRENT ACI 301 "STANDARD SPECIFICATION FOR STRUCTURAL CONCRETE" UNLESS MORE STRINGENT REQUIREMENTS ARE INDICATED.
- 2.2. CONCRETE SHALL BE FORMED AND LOCATED AS PER ACI 117 "SPECIFICATIONS FOR TOLERANCES FOR CONCRETE CONSTRUCTION AND MATERIALS AND COMMENTARY.
- 2.3. FORMS SHALL BE COATED WITH A FORM RELEASE AGENT. FORM RELEASE AGENT SHALL NOT RAISE FORM GRAIN OR STAIN CONCRETE SURFACE.

 2.4. MECHANICALLY VIBRATE ALL CONCRETE PLACEMENTS, BUT VIBRATION SHALL
- NOT BE UTILIZED TO CONVEY MATERIAL.
 2.5. WELDING OF REINFORCING BARS IS NOT PERMITTED WITHOUT A PROCEDURE
- APPROVED BY THE ENGINEER OF RECORD.


 2.6. SECURE ALL REINFORCING IN POSITION WITH CHAIRS BEFORE CONCRETE PLACEMENT. REINFORCING SHALL BE INSPECTED FOR PROPER PLACEMENT.

3. <u>CONCRETE FINISHING</u>

3.1. CHAMFER ALL EXPOSED EDGES 3/4" (TYPICAL UNLESS NOTIFIED OTHERWISE). CHAMFER VIA GRINDING IS PROHIBITED.

. CONCRETE TESTING AND INSPECTION

4.1. ALL CONCRETE SHALL BE FIELD TESTED BY AN INDEPENDENT TESTING LABORATORY AS PER ASTM SPECIFICATIONS (PAID FOR BY CONTRACTOR). FOR EACH PLACEMENT, ONE SET OF 5 STANDARD COMPRESSION TEST CYLINDERS SHALL BE TAKEN AND TESTED IN ACCORDANCE WITH ASTM C39: 1 SPECIMEN TESTED AT 7 DAYS; 3 SPECIMENS TESTED AT 28 DAYS; AND 1 SPECIMEN RETAINED IN RESERVE FOR LATER TESTING IF REQUIRED.

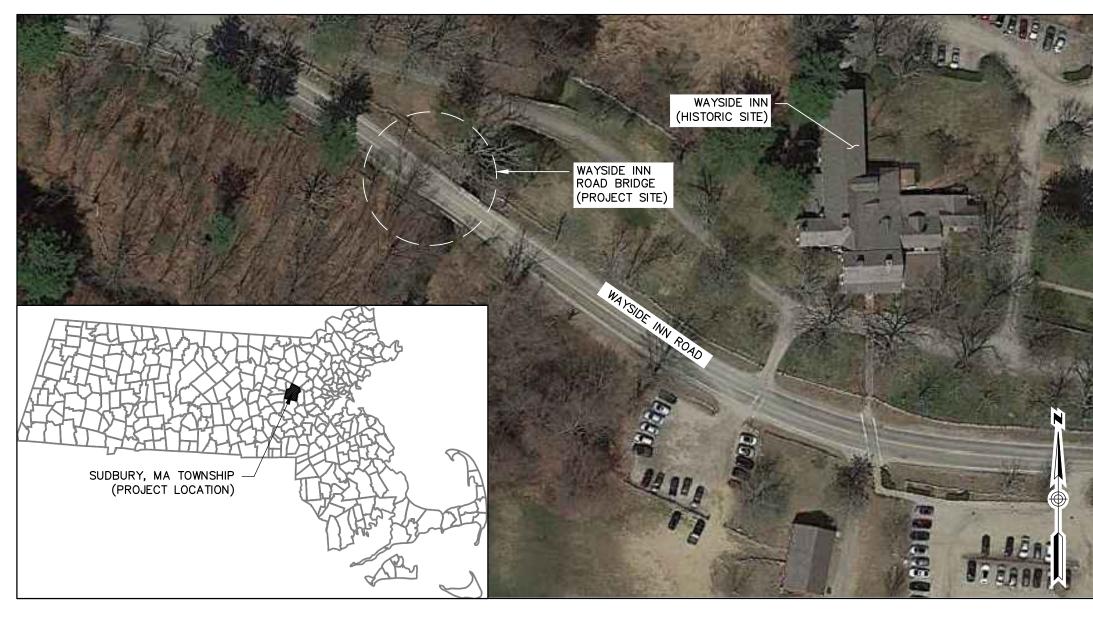

SITE PLAN: WAYSIDE INN ROAD BRIDGE SITE



PHOTO 1: EXISTING CONDITIONS - WAYSIDE BRIDGE LOOKING SOUTH

EPOXY-COATED REINFORCEMENT NOTES

1. <u>REINFORCEMENT</u>

1.1. ALL REINFORCING BARS SHALL BE DEFORMED AND SHALL CONFORM TO ASTM A 615

1.2. EPOXY-COATED REINFORCING BARS SHALL CONFORM TO ASTM A 7751.3. WHEN REQUIRED, DAMAGES TO EPOXY COATING SHALL BE REPAIRED WITH PATCHING MATERIAL CONFORMING TO ASTM A775. REPAIR SHALL BE DONE IN ACCORDANCE WITH THE PATCHING MATERIAL MANUFACTURER'S RECOMMENDATIONS.

2. <u>FABRICATION</u>

2.1. ALL REINFORCEMENT SHALL BE BENT COLD UNLESS OTHERWISE PERMITTED BY THE ENGINEER.

3. PLACING (FIELD INSTALLATION)

- 3.1. EPOXY—COATED REINFORCING BARS SUPPORTED FROM FORMWORK SHALL REST ON COATED WIRE BAR SUPPORTS, OR ON BAR SUPPORTS MADE OF DIELECTRIC MATERIAL OR OTHER ACCEPTABLE MATERIALS. REINFORCING BARS USED AS SUPPORT BARS SHALL BE
- 3.2. EPOXY-COATED.

 3.2. EPOXY-COATED REINFORCING BARS SHALL BE FASTENED WITH NYLON-, EPOXY-, OR PLASTIC-COATED TIE WIRE OR OTHER ACCEPTABLE
- MATERIALS.

 3.3. SPLICES OF REINFORCING BARS SHALL BE MADE ONLY AS AUTHORIZED BY THE ENGINEER
- 3.4. REINFORCING BARS PARTIALLY EMBEDDED IN CONCRETE SHALL NOT BE FIELD BENT EXCEPT WHERE SHOWN ON THE DRAWINGS. WHERE
- REINFORCING BARS ARE FIELD BENT, COATING DAMAGE SHALL BE REPAIRED PER THESE NOTES.

 3.5. UNLESS PERMITTED BY THE ENGINEER, REINFORCING BARS SHALL BE NOT BE FIELD CUT. WHEN EPOXY—COATED REINFORCING BARS ARE CUT IN THE FIELD, THE ENDS OF THE BARS SHALL BE COATED WITH THE SAME MATERIAL USED FOR REPAIR OF COATING DAMAGE PER
- THESE NOTES.

 3.6. EQUIPMENT FOR HANDLING EPOXY—COATED BARS SHALL HAVE PROTECTED CONTACT AREAS. BUNDLES OF COATED BARS SHALL BE LIFTED AT MULTIPLE PICK—UP POINTS TO MINIMIZE BAR—TO—BAR ABRASION FROM SAGS IN THE BUNDLES. COATED BARS OR BUNDLES OF COATED BARS SHALL NOT BE DROPPED OR DRAGGED. COATED BARS SHALL BE STORED ON PROTECTIVE CRIBBING. FADING OF THE COATING SHALL NOT BE CAUSE FOR REJECTION OF EPOXY—COATED REINFORCING BARS. COATING DAMAGE DUE TO HANDLING, SHIPMENT, AND PLACING NEED NOT BE REPAIRED IN CASES WHERE THE DAMAGED AREA IS 0.1 SQUARE INCH OR SMALLER. DAMAGED AREAS LARGER THAN 0.1 SQUARE INCH SHALL BE REPAIRED PER THESE NOTES. THE MAXIMUM AMOUNT OF DAMAGE INCLUDING REPAIRED AND UNREPAIRED AREAS SHALL NOT EXCEED 2 PERCENT OF THE SURFACE AREA OF EACH BAR.

ABBREVIATIONS

& AND

AT

PERCENT(AGE)

PLUS OR MINUS

ACI AMERICAN CONCRETE INSTITUTE

ASTM AMERICAN SOCIETY OF TESTING MATERIALS

BOT BOTTOM

CLR CLEAR

CONC CONCRETE

CONT CONTINUOUS

DEMO DEMOLISH

EF EACH FACE

EXG EXISTING

FV FIELD VERIFY
IN INCHE(S)
LB POUND
MAX MAXIMUM
MIN MINIMUM
OC ON CENTER
OCEF ON CENTER EACH FACE
REF REFERENCE

TYPICAL

EMBEDMENT

FOOT / FEET



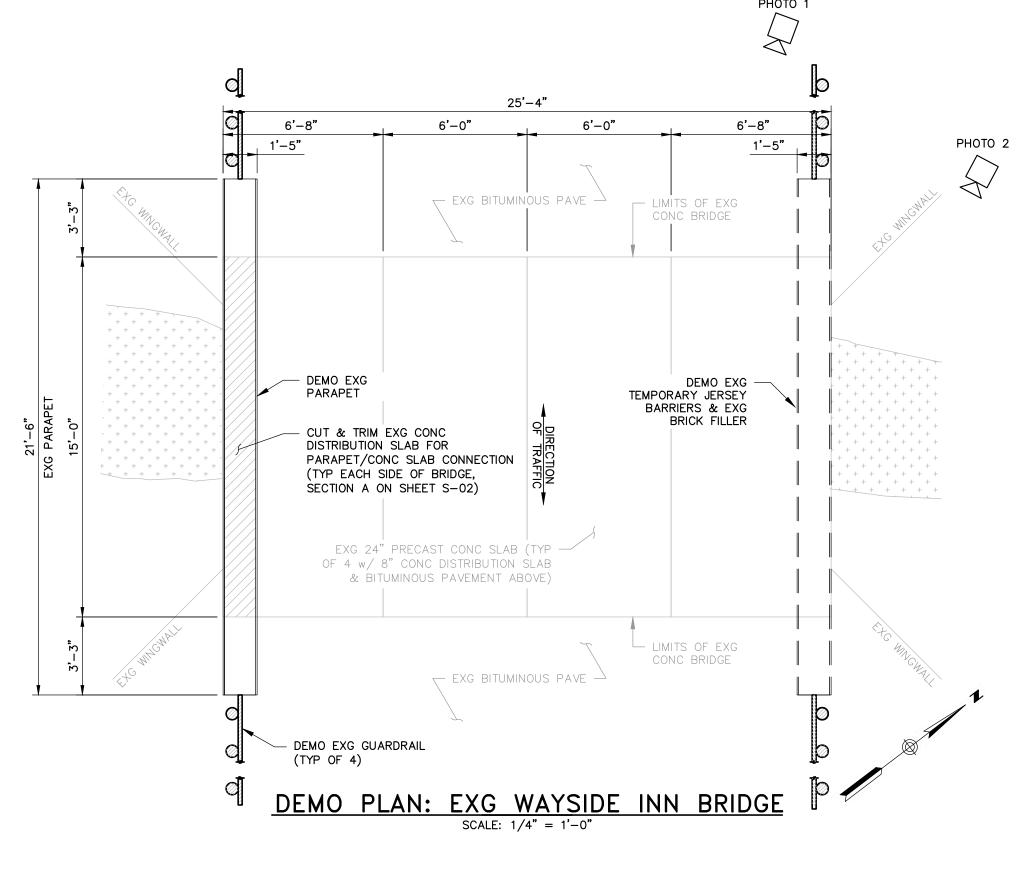




PHOTO 2: EXISTING CONDITIONS - MISSING PARAPET

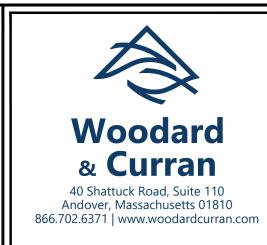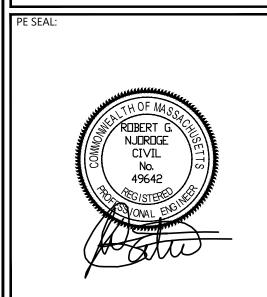

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ISSUE FOR BID

IENT INFO:

TOWN OF SUDBURY
MASSACHUSETTS

WAYSIDE BRIDGE REPAIRS

REV MM/DD/YY	DESCRIPTION
JOB NO:	0227202.11
DATE:	APRIL 2024
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JOB NO: 0227202.11

DATE: APRIL 2024

SCALE: AS NOTED

DESIGNED BY: CSB

DRAWN BY: CSB


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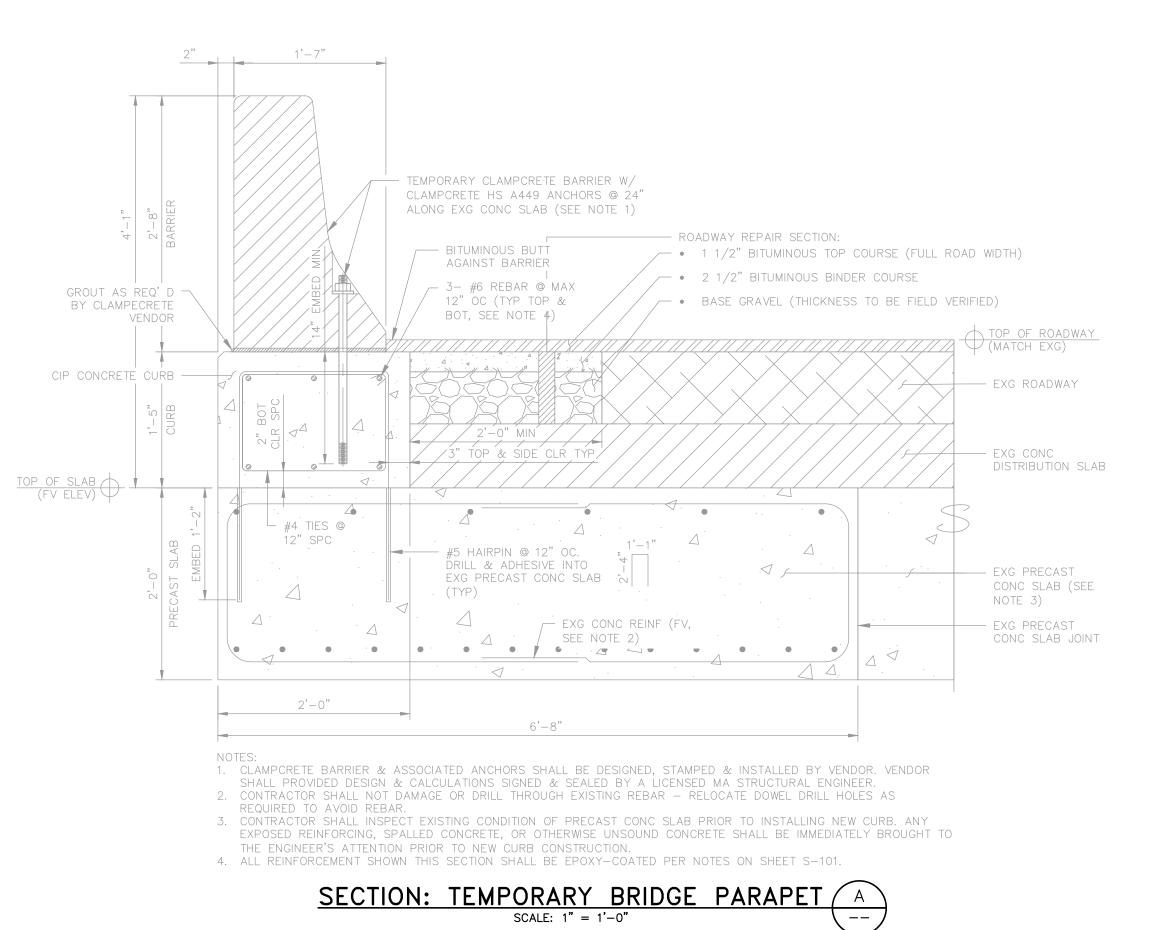
FILENAME: 0227202.08_S-101.dwg

DRAWING TITLE:

STRUCTURAL
WAYSIDE INN BRIDGE REPAIRS
SITE PLAN, NOTES,
EXISTING CONDITIONS,
AND DEMOLITION PLAN

DRAWING NO:



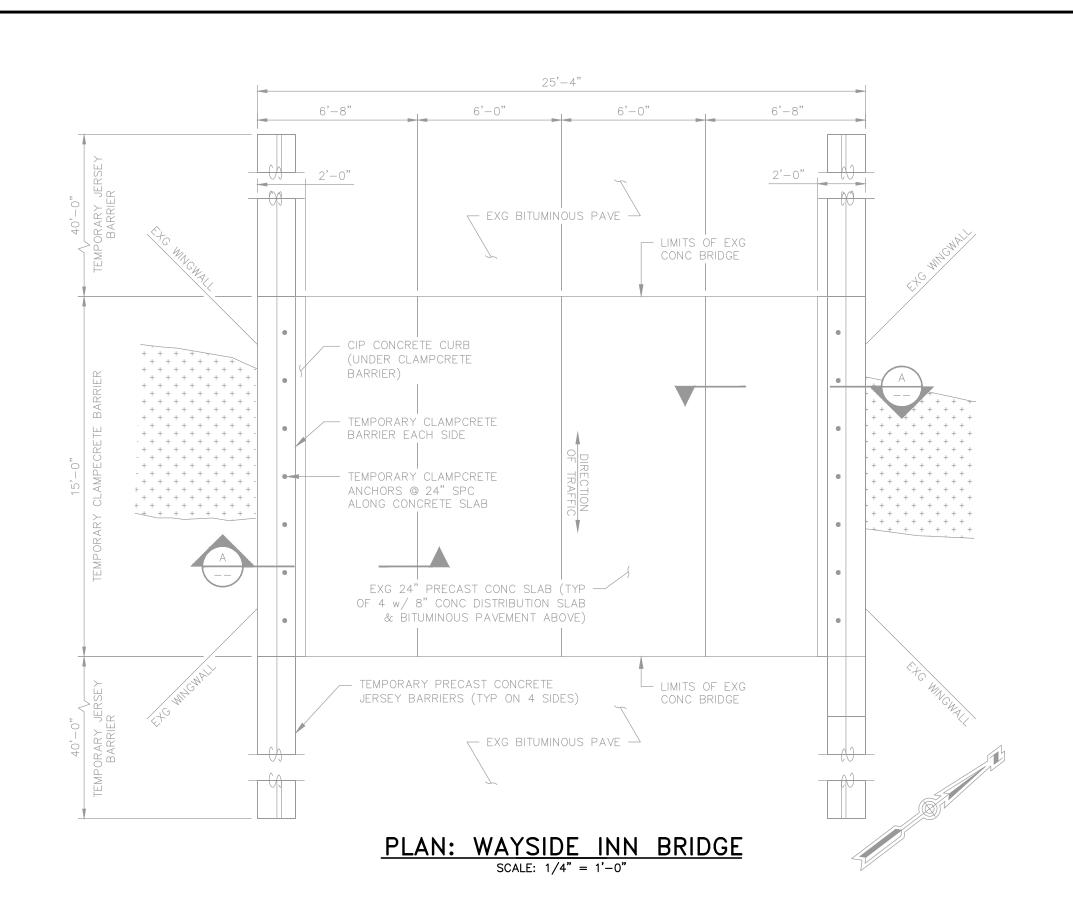


NOTE:

 NOT FOR CONSTRUCTION EXISTING CONDITIONS SHEET IS FOR INFORMATION ONLY.



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CLIENT INFO:

TOWN OF SUDBURY
MASSACHUSETTS

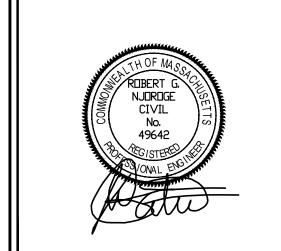WAYSIDE BRIDGE REPAIRS

REV MM/DD/YY DESCRIPTION

JOB NO: 0227202.11

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DATE: APRIL 2024

SCALE: AS NOTED

DESIGNED BY: CSB

DRAWN BY: CSB

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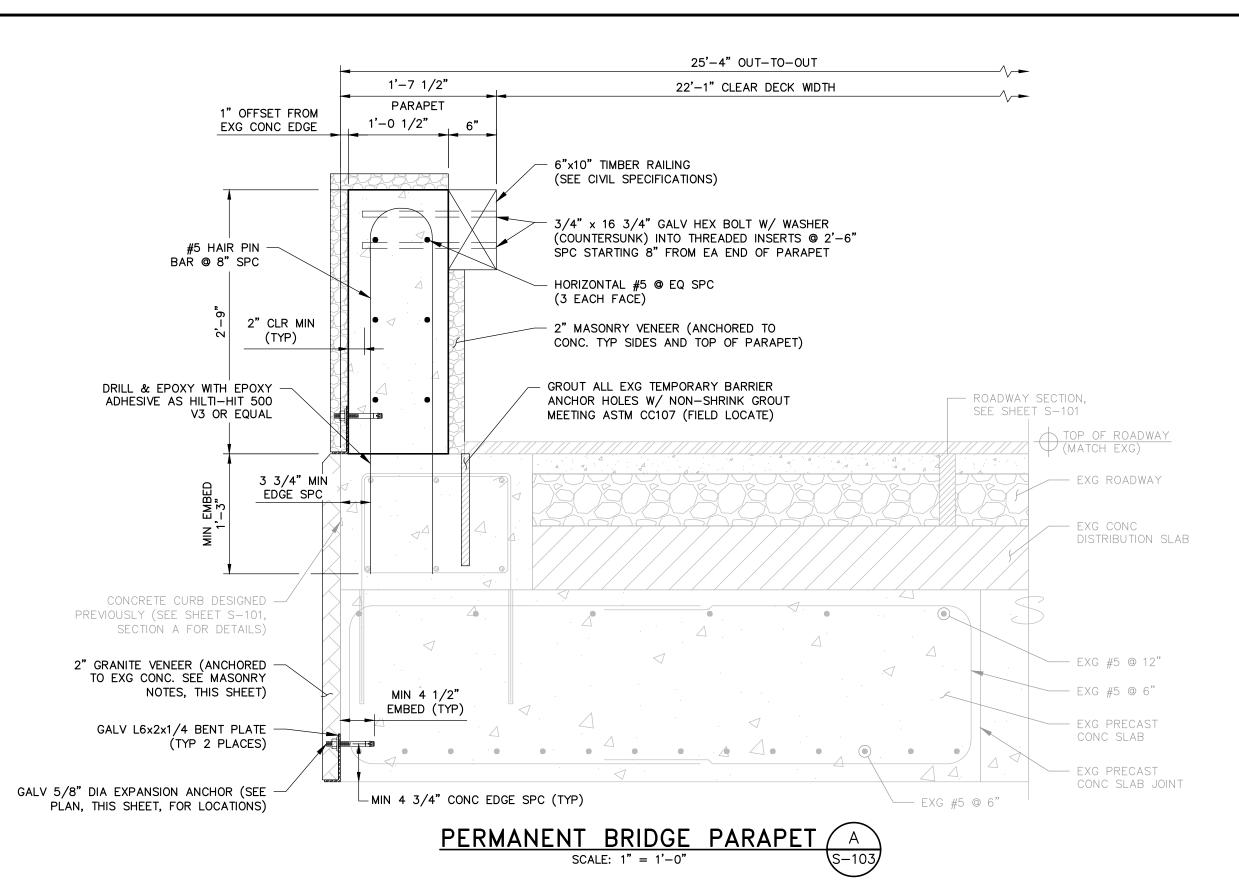
DRAWING TITLE:

STRUCTURAL
WAYSIDE INN BRIDGE REPAIRS
PROPOSED PLAN AND SECTION

DRAWING NO:

S-102

FOR INFORMATIONAL PURPOSES ONLY



- 1. CONTRACTOR SHALL NOT DAMAGE OR DRILL THROUGH EXISTING REBAR. RELOCATE DOWELING AS REQUIRED TO
- 2. EXISTING CONCRETE ASSUMED IN GOOD CONDITION. PRIOR TO CONSTRUCTION, CONTRACTOR SHALL VERIFY CONDITION OF EXISTING CONCRETE WHERE VENEER WILL BE LOCATED. ANY EXPOSED REINFORCING, SPALLED CONCRETE, OR OTHERWISE UNSOUND CONCRETE SHALL BE IMMEDIATELY BROUGHT TO THE ENGINEER'S ATTENTION BEFORE STARTING CONSTRUCTION.

A. GENERAL STRUCTURAL NOTES:

THESE NOTES SHALL APPLY TO ALL WORK THIS SHEET, EXCEPT AS NOTED OTHERWISE. SEE SHEETS S-01 & S-02 FOR WORK PREVIOUSLY PERFORMED.

GOVERNING CODES

- 2.1. MASS STATE BUILDING CODE 780 CMR NINTH EDITION 2.2. MASSDOT LRFD BRIDGE MANUAL 2013
- 2.3. AISC STEEL CONSTRUCTION MANUAL, 14TH ED. 2.4. ACI 318-14 BUILDING CODE REQUIREMENTS FOR STRUCTURAL CONCRETE,

188 FT

3. <u>DESIGN LOADS AND CRITERIA</u>

3.1. <u>BASIC DESIGN PARAMETERS</u> PROJECT ADDRESS: SUDBURY, MA 42.357° PROJECT LOCATION: LAT LONG -71.470°

GENERAL ELEVATION

3.1. <u>DEAD LOADS</u>

30 PSF (EQUIVALENT TO 2" GRANITE @ 180 PCF) STONE FACADE

10,000 LBS

3.2. <u>LIVE LOADS</u>

B. <u>REINFORCED CONCRETE:</u>

- PROVIDE 4,500 PSI COMPRESSIVE STRENGTH AT 28 DAYS; 3/4" NOMINAL MAXIMUM AGGREGATE SIZE; AIR CONTENT 6% ± 1.5%; W/C RATIO 0.45 MAXIMUM; SLUMP 5" MAXIMUM W/ NO REDUCER, 6" MAXIMUM W/ MID-RANGE WATER REDUCER, OR 8" MAXIMUM W/ HIGH-RANGE WATER REDUCER AFTER ALL WATER HAS BEEN ADDED. SUBMIT TEST RESULTS TO THE ENGINEER.
- 2. PRIOR TO ORDERING A CONCRETE MIX, SUBMIT A CONCRETE MIX DESIGN TO BE REVIEWED AND APPROVED BY THE ENGINEER. MIX DESIGN SHALL INCLUDE TARGET COMPRESSIVE STRENGTH, TARGET SLUMP, TARGET AIR CONTENT, SIEVE ANALYSIS, WATER REDUCER PRODUCTS (MEETING ASTM C494), AIR ADMIXTURE PRODUCTS (MEETING ASTM C260), AND A CEMENT MILL REPORT NOT OLDER THAN 90 DAYS. CEMENT SHALL BE PER ASTM C150, TYPE II AND SHALL CONTAIN LESS THAN 0.60% EQUIVALENT ALKALIS. IF THE CEMENT CONTAINS 0.60% OR GREATER EQUIVALENT ALKALIS, PROVIDE AGGREGATE ALKALI REACTIVITY TESTING PER ASTM C1260, C1293,
- ALL DESIGN IN ACCORDANCE WITH ACI 318-14 CONCRETE BUILDING CODE. ALL CONCRETE SHALL BE PROVIDED, PLACED, AND MOIST CURED (MIN 7 DAYS) AS PER ALL APPLICABLE SECTIONS OF ACI, AS APPROVED BY THE ENGINEER.
- 4. ALL CONCRETE SHALL BE FIELD TESTED BY AN INDEPENDENT TESTING LABORATORY AS PER ASTM SPECIFICATIONS (PAID FOR BY THE CONTRACTOR). FOR EACH PLACEMENT, ONE SET OF FOUR 4" DIAMETER X 8" TALL STANDARD COMPRESSION TEST CYLINDERS SHALL BE TAKEN AND TESTED IN ACCORDANCE WITH ASTM C39: 1 SPECIMEN TESTED AT 7 DAYS; 2 SPECIMENS TESTED AT 28 DAYS; AND 1 SPECIMEN RETAINED IN RESERVE FOR LATER TESTING IF REQUIRED.
- 5. PRIOR TO INSTALLING STONE VENEER, ALL EXPOSED CONCRETE SURFACES SHALL RECEIVE A GROUT-CLEANED RUBBED FINISH AND SHALL HAVE A SMOOTH AND EVEN SURFACE, FREE OF BUG HOLES, WHEN COMPLETED. FILL MORTAR SHALL CONSIST OF ONE PAR CEMENT TO 1 1/2 PARTS SAND MEETING ASTM C144 OR C404. WORK IN DIRECT HOT SUNLIGHT SHALL BE AVOIDED.

6. <u>CONCRETE ANCHORS</u>

WAYSIDE INN BRIDGE PLAN

THE FOLLOWING ANCHORS SHALL BE USED WHERE CALLED FOR IN THESE DRAWINGS.

ANCHOR SYSTEM HILTI HIT-HY 500-A W/ REBAR DOWELING

MECHANICAL ANCHORS: HILTI SS304 KWIK BOLT TZ2-CS W/WASHER ANCHOR

D. <u>CONCRETE REINFORCEMENT (EPOXY-COATED)</u>

- REINFORCEMENT: ASTM A615 GRADE 60 & EPOXY-COATED PER ASTM A775 ALL SPLICES CLASS B (UNO). REINFORCEMENT SHALL BE DETAILED, FABRICATED, AND PLACED AS PER ACI 315 DETAILING MANUAL.
- 2. ALL REINFORCEMENT SHALL BE BENT COLD UNLESS OTHERWISE PERMITTED BY THE

3. PLACING (FIELD INSTALLATION)

- 3.1. EPOXY-COATED REINFORCING BARS SUPPORTED FROM FORMWORK SHALL REST ON COATED WIRE BAR SUPPORTS, OR ON BAR SUPPORTS MADE OF DIELECTRIC MATERIAL OR OTHER ACCEPTABLE MATERIALS. REINFORCING BARS USED AS SUPPORT BARS SHALL BE EPOXY-COATED.
- 3.2. EPOXY-COATED REINFORCING BARS SHALL BE FASTENED WITH NYLON-, EPOXY-, OR PLASTIC-COATED TIE WIRE OR OTHER ACCEPTABLE MATERIALS.
- 3.3. SPLICES OF REINFORCING BARS SHALL BE MADE ONLY AS AUTHORIZED BY THE
- 3.4. REINFORCING BARS PARTIALLY EMBEDDED IN CONCRETE SHALL NOT BE FIELD BENT EXCEPT WHERE SHOWN ON THE DRAWINGS. WHERE REINFORCING BARS ARE FIELD BENT, COATING DAMAGE SHALL BE REPAIRED PER THESE NOTES.
- 3.5. UNLESS PERMITTED BY THE ENGINEER, REINFORCING BARS SHALL BE NOT BE FIELD CUT. WHEN EPOXY-COATED REINFORCING BARS ARE CUT IN THE FIELD, THE ENDS OF THE BARS SHALL BE COATED WITH THE SAME MATERIAL USED FOR REPAIR OF COATING DAMAGE PER THESE NOTES.
- 3.6. EQUIPMENT FOR HANDLING EPOXY-COATED BARS SHALL HAVE PROTECTED CONTACT AREAS. BUNDLES OF COATED BARS SHALL BE LIFTED AT MULTIPLE PICK-UP POINTS TO MINIMIZE BAR-TO-BAR ABRASION FROM SAGS IN THE BUNDLES. COATED BARS OR BUNDLES OF COATED BARS SHALL NOT BE DROPPED OR DRAGGED. COATED BARS SHALL BE STORED ON PROTECTIVE CRIBBING. FADING OF THE COLOR OF THE COATING SHALL NOT BE CAUSE FOR REJECTION OF EPOXY-COATED REINFORCING BARS.
- 3.7. COATING DAMAGE DUE TO HANDLING, SHIPMENT, AND PLACING NEED NOT BE REPAIRED IN CASES WHERE THE DAMAGED AREA IS 0.1 SQUARE INCH OR SMALLER, DAMAGED AREAS LARGER THAN 0.1 SQUARE INCH SHALL BE REPAIRED PER THESE NOTES. THE MAXIMUM AMOUNT OF DAMAGE INCLUDING REPAIRED AND UNREPAIRED AREAS SHALL NOT EXCEED 2 PERCENT OF THE SURFACE AREA OF
- 3.8. WHEN REQUIRED, DAMAGES EPOXY COATING SHALL BE REPAIRED WITH PATCHING MATERIAL CONFORMING TO ASTM A775. REPAIR SHALL BE DONE IN ACCORDANCE WITH THE PATCHING MATERIAL MANUFACTURER'S RECOMMENDATIONS.
- 3.9. COATING DAMAGE DUE TO HANDLING, SHIPMENT, AND PLACING NEED NOT BE REPAIRED IN CASES WHERE THE DAMAGED AREA IS 0.1 SQUARE INCH OR SMALLER. DAMAGED AREAS LARGER THAN 0.1 SQUARE INCH SHALL BE REPAIRED PER THESE NOTES. THE MAXIMUM AMOUNT OF DAMAGE INCLUDING REPAIRED AND UNREPAIRED AREAS SHALL NOT EXCEED 2 PERCENT OF THE SURFACE AREA OF EACH BAR.

E. <u>MASONRY:</u>

- VENEER: BY STONEYARD, INC OR APPROVED EQUAL. COLOR AND STYLE OF MASONRY & GRANITE VENEER SHALL BE SELECTED BY THE CLIENT. ANCHORAGE OF VENEER SHALL BE ANCHORED PER MANUFACTURERS RECOMMENDATIONS.
- 2. ALL STONE FINISHES SHALL HAVE AN AGED FINISH TO BE REVIEWED AND APPROVED BY THE HISTORIC DISTRICTS COMMISSION AT A FUTURE MEETING.
- 3. MORTAR FOR VENEER SHALL CONFORM TO ASTM C270. TYPE N, AND SHALL CONSIST OF THE FOLLOWING PROPORTIONS BY VOLUME: 1 PART TYPE N MORTAR CEMENT 2-1/4 TO 3 PARTS AGGREGATE; OR 1 PART PORTLAND CEMENT, 1/2 TO 1-1/4 PARTS HYDRATED LIME, 2-1/4 TO 3 TIMES THE SUM OF THE CEMENT AND LIME VOLUMES, PARTS AGGREGATE
- 4. MORTAR PIGMENT: MORTAR SHALL BE CHEMICALLY PURE INORGANIC OXIDES IN COMPOUNDS SUITABLY PREPARED FOR USE IN MASONRY MORTAR. COLORS SHALL BE SELECTED BY THE CLIENT.

F. <u>STRUCTURAL STEEL:</u>

- STEEL SHALL COMPLY WITH THE AMERICAN INSTITUTE OF STEEL CONSTRUCTION AISC 360-10 SPECIFICATION FOR STRUCTURAL STEEL BUILDINGS, AISC 303-10 CODE OF STANDARD PRACTICE FOR STEEL BUILDINGS AND BRIDGES AND THE 14TH EDITION OF STEEL CONSTRUCTION MANUAL. ALL STEEL MEMBERS, BOLTS, AND CONNECTIONS SHALL BE DESIGNED TO LOAD AND RESISTANCE FACTOR DESIGN (LRFD).
- 2. STEEL SHALL CONFORM TO ASTM A36 FOR ROLLED SHAPES & PLATES.
- POST-INSTALLED ANCHORS: EXPANSIONS BOLTS ARE PERMITTED WHERE SPECIFICALLY INDICATED ON DRAWINGS AND IN COMPLIANCE WITH PROJECT SPECIFICATION.
- 4. FIELD CUTTING OR DRILLING IN STRUCTURAL MEMBERS IS PROHIBITED, UNLESS PREVIOUSLY APPROVED BY THE STRUCTURAL STRUCTURAL ENGINEER-OF-RECORD.

G. <u>STRUCTURAL STEEL GALVANIZING</u>

- ALL STRUCTURAL STEEL, INCLUDING BOLTS AND CONNECTION ITEMS, SHALL BE
- ACCORDANCE WITH ASTM A123 OR ASTM A153, IN MOLTEN ZINC, PRODUCING A CONTINUOUS COATING OF UNIFORM THICKNESS OF WEIGHT REQUIRED BY THE REFERENCED SPECIFICATIONS.

2. ALL ITEMS SPECIFIED AS GALVANIZED SHALL BE COATED BY THE HOT-DIP PROCESS IN

- 3. GALVANIZING PROCESS SHALL INCLUDE NOT LESS THAN FOUR IMMERSIONS IN COPPER SULFATE IN CONFORMANCE WITH ASTM A239. MINIMUM ACCEPTABLE WEIGHT OF COATING SHALL BE 1.25 OUNCES PER SQUARE FOOT OF SURFACE AS PER ASTM A90
- 4. GALVANIZED ITEMS SHALL BE TAGGED TO INCLUDE THE NAME OF GALVANIZER, THE WEIGHT OF THE COATING, AND APPLICABLE ASTM COMPLIANCE.
- 5. AT LOCATIONS WHERE GALVANIZED STEEL IS FIELD CUT AND AT OTHER LOCATIONS WHERE GALVANIZED COATING IS REMOVED, THE STEEL SURFACE SHALL BE TOUCHED UP WITH A ZINC RICH PAINT MEETING ASTM A780 AND CONTAINING A MINIMUM OF 65% ZINC. THE MINIMUM ACCEPTABLE WEIGHT OF COATING SHALL BE 1.25 OUNCES PER SQUARE FOOT OF SURFACE AS PER ASTM A90.
- IF GALVANIZED STEEL IS TO BE PAINTED, THE GALVANIZED STEEL SHALL NOT BE QUENCHED. IT SHALL BE PHOSPHATIZED, AND PREPARED FOR PAINTING PER ASTM D6386. IT SHALL BE PRIME PAINTED, COMPATIBLE WITH THE FINISH PAINTS SPECIFIED.

F. EXISTING CONDITIONS:

- 4. IT IS THE RESPONSIBILITY OF THE CONTRACTOR TO VERIFY ALL EXISTING CONDITIONS AND DIMENSIONS AS THEY RELATE TO NEW CONSTRUCTION. REPORT TO THE ENGINEER-OF-RECORD ALL OBSERVATIONS AND ANY DISCREPANCIES BEFORE PROCEEDING WITH WORK.
- WHERE DETAILS FOR SPECIFIC CONDITIONS ARE NOT SHOWN ON THESE PLANS, USE DETAILS FOR THE MOST NEARLY SIMILAR CONDITIONS SHOWN ON THE STRUCTURAL DRAWINGS AS DETERMINED BY THE STRUCTURAL ENGINEER. REPORT ANY COORDINATION ISSUES IMMEDIATELY TO THE ENGINEER.
- 6. IT IS THE RESPONSIBILITY OF THE CONTRACTOR TO PROVIDE FOR A SAFE AND EFFICIENT METHOD OF SHORING AND/OR BRACING FOR THE STRUCTURE DURING ALL CONSTRUCTION PHASES. SUBMIT AN OUTLINE OF PROPOSED PROCEDURES BEFORE CONSTRUCTION COMMENCES.
- STRUCTURAL MEMBERS SHALL NOT BE MODIFIED IN THE FIELD WITHOUT WRITTEN APPROVAL FROM THE STRUCTURAL ENGINEER. IN THE EVENT OF A CONSTRUCTION OR FABRICATION ERROR, THE CONTRACTOR SHALL PREPARE A SKETCH WITH A PROPOSED REPAIR, AND SUBMIT IT TO THE ENGINEER FOR APPROVAL PRIOR TO PERFORMING ANY
- VERIFY ALL FIELD DIMENSIONS, LOCATIONS, AND GEOMETRY OF EXISTING STRUCTURES PRIOR TO CONSTRUCTION. ALL EXISTING DIMENSIONS ARE APPROXIMATE. NOTIFY THE ENGINEER IMMEDIATELY OF ANY DISCREPANCY BETWEEN THE FIELD CONDITIONS AND THE CONTRACT DRAWINGS.
 - THE CONTRACTOR SHALL TAKE ALL NECESSARY MEASURES TO PROTECT THE EXISTING BUILDING ELEMENTS TO REMAIN DURING DEMOLITION. DO NOT CUT OR ALTER ANY OF THE EXISTING STRUCTURAL OR ARCHITECTURAL ELEMENTS TO REMAIN WITHOUT PRIOR WRITTEN APPROVAL FROM THE ENGINEER. PROVIDE PROTECTION FOR EXISTING WALLS, COLUMNS, BRACES, AND OTHER BUILDING ELEMENTS TO REMAIN FROM FALLING DEBRIS. ANY DAMAGE TO EXISTING ELEMENTS TO REMAIN SHALL BE REPAIRED BY THE CONTRACTOR AT THEIR OWN EXPENSE.

ABBREVIATIONS


& @ % ±	AND AT PERCENT(AGE) PLUS OR MINUS	MAX MECH MIN	MAXIMUM MECHANICAL MINIMUM
ACI ASTM	AMERICAN CONCRETE INSTITUTE AMERICAN SOCIETY OF TESTING MATERIALS	OC OD OCEW	ON CENTER OUTSIDE DIAMETER ON CENTER EACH WAY
вот	воттом	PL PLF	PLATE POUND(S) PER LINEAR FOOT
CIP CLR CONC	CAST-IN-PLACE CLEAR CONCRETE	PSF PSI	POUND(S) PER SQUARE FOOT POUND(S) PER SQUARE INCH
DIA	DIAMETER	REF	REFERENCE
DWGS	DRAWINGS	SEOR SS	STRUCTURAL ENGINEER OF RECORD STAINLESS STEEL
EL EMBED	ELEVATION EMBEDMENT		
EXG	EXISTING	T&B TYP	TOP AND BOTTOM TYPICAL
FT	FOOT / FEET	UNO	UNLESS NOTIFIED OTHERWISE
FV FL	FIELD VERIFY FIELD LOCATE	W/	WITH
IN	INCH(ES)		

Woodard 40 Shattuck Road, Suite 110 Andover, Massachusetts 01810 866.702.6371 | www.woodardcurran.com

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ISSUE FOR BID

TOWN OF SUDBURY **MASSACHUSETTS**

WAYSIDE BRIDGE REPAIRS

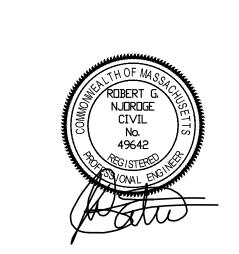EV MM/DD/YY DESCRIPTION 0227202.11 APRIL 2024

AS NOTED CALE. DESIGNED BY: CSB DRAWN BY: CSB HECKED BY: TJS/JPS II ENIAME. 0227202.08 S-103.dwa

DRAWING TITLE: STRUCTURAL

WAYSIDE INN BRIDGE REPAIR PLAN & SECTION