ASSESSORS: MAP E09, LOT 420 **ZONING:** RESIDENTIAL A REFERENCES: DEED BOOK 65642, PAGE 201 PLAN 705 OF 1964 PLAN 388 OF 1984 RECORD OWNER: XIN JIA & YU HUANG 51 WOODMERE DRIVE SUDBURY, MA 01776

GENERAL NOTES: BUFFER ZONE RESTORATION PLAN (628 S.F.)

WERE NOT PART OF THIS SURVEY. THE LOCATION OF UNDERGROUND

3) THIS TOPOGRAPHIC SURVEY WAS PREPARED TO MEET NATIONAL

AND A 2 FOOT CONTOUR INTERVAL VERTICALLY. ANY

4) THE PURPOSE OF THIS PLAN IS TO DEPICT THE LIMIT OF

5) LAWN DEBRIS AT EDGE OF WETLANDS SHALL BE REMOVED.

MAP ACCURACY STANDARDS AT A SCALE OF 1"=20' HORIZONTALLY

REPRODUCTIONS OR RE-SCALING MAY EFFECT THE MAP ACCURACY.

WETLANDS ON-SITE AND THE TOPOGRAPHY FROM THE REAR OF THE

6) ALL EROSION AND SEDIMENTATION CONTROLS SHALL BE INSTALLED

7) ANY MATERIAL STOCKPILES OR OTHER DISTURBED AREAS THAT

REMAIN DISTURBED FOR OVER 30 DAYS SHALL BE TEMPORARILY

OWNER AND CONTRACTOR, THERE IS NO SUMP PUMP IN THE

8) TWO 4" HDPE PIPES ARE FOUND NEAR FLAGS 105 AND 108. PER

BASEMENT. PIPES MAY BE GRAVITY OUTLETS FROM EXTERIOR FRENCH

GENERAL BUFFER ZONE RESTORATION NOTES:

9) THE SUDBURY CONSERVATION COMMISSION SHALL BE NOTIFIED NO

10) A QUALIFIED RESTORATION ECOLOGIST SHALL OVERSEE ALL WORK

SUITABLE SUBSTITUTE SPECIES MAY BE CONSIDERED, HOWEVER PLANT SELECTION SHALL BE LIMITED TO NATIVE SPECIES SUITABLE TO THE GROWING CONDITIONS OF THE SITE. ANY PROPOSED DEVIATION FROM THIS PLAN MUST BE SUBMITTED TO THE CONSERVATION COMMISSION

11) IN THE EVENT THAT SPECIFIED PLANTINGS ARE UNAVAILABLE,

1=65.04' R=325.00'

CONSTRUCTION
MATERIAL STOCKPILE

FREDERICK T.4 CHERYLL HASS (DEED BOOK 70019. PAGE

LOCATION

PROPOSED DEWATERING BASIN

(IF REQUIRED) -

UP-9 BM #1

CBDH(F)

LESS THAN ONE (1) WEEK IN ADVANCE OF THE INITIATION OF ANY

DRAIN. CARE TO BE USED DURING MITIGATION PLANTING IN THOSE

STORAGE TANKS, IF ANY, ARE UNKNOWN.

HOUSE TO SAID LIMIT OF WETLANDS.

PRIOR TO ANY CONSTRUCTION ACTIVITY.

STABILIZED WITH GRASS, MATS, OR NETTING.

PERFORMED BY LANDSCAPE CONTRACTOR.

FOR REVIEW AND APPROVAL PRIOR TO EXECUTION.

TREE REMOVAL WORK.

1) ELEVATIONS SHOWN HEREON ARE ON AN ASSUMED DATUM. 12) CONTRACTOR SHALL INSTALL STAKED FIBER ROLL SEDIMENT CONTROLS ALONG THE EDGE OF WETLAND BELOW ALL PROPOSED WETLAND RESTORATION WORK. 2) UNDERGROUND UTILITIES EXIST. THE LOCATION OF SAID UTILITIES

> 13) CONTRACTOR SHALL REMOVAL ALL NON-NATIVE VEGETATION FROM THE WETLAND REPLICATION AREA.

14) FOLLOWING REMOVAL OF NON-NATIVE SPECIES, CONTRACTOR SHALL INSTALL NATIVE PLANTS IN ACCORDANCE WITH THE FOLLOWING PLANTING SCHEDULE:

SHRUB SPECIES A. FIVE (5) BLACK CHOKEBERRY (ARONIA MELANOCARPA, FAC)

B. FIVE (5) SWEET PEPPERBUSH (CLETHRA ALNIFOLIA, FAC) C. FIVE (5) HIGHBUSH BLUEBERRY (VACCINIUM CORYMBOSUM, FACW)

D. FIVE (5) EASTERN SHADBUSH (AMELANCHIER CANADENSIS, FAC)

HERBACEOUS PLANTS

WOODMERE

E. FIFTY (50) WILD BERGAMOT (MONARDA FISTULOSA, FACU)

F. FIFTY (50) NORTHERN CRANE'S-BILL (GERANIUM BICKNELLII, FACU)

G. FIFTY (50) COMMON GOLDEN ALEXANDERS (ZIZIA AUREA, FAC) H. FIFTY (50) EASTERN HAY-SCENTED FERN (DENNSTAEDTIA PUNCTILOBULA, UPL) I. FIFTY (50) NEW YORK FERN (PARATHELYPTERIS NOVEBORACENSIS, FAC)

ALL SHRUBS SHALL BE NO LESS THAN 3' IN HEIGHT AT PLANTING. SHRUBS SHALL BE INSTALLED AT 6' OFF CENTERS. ALL HERBACEOUS PLANTS SHALL BE EITHER 2" PLUGS OR POT SIZE #1 AT PLANTING.

15) FOLLOWING INSTALLATION OF PLANTS, CONTRACTOR SHALL BROADCAST SEED THE RESTORATION AREA WITH A BLEND OF 5LBS NEW ENGLAND FROSION CONTROL/RESTORATION MIX FOR DRY SITE AND 2LBS OF NEW ENGLAND SHOWY WILDFLOWER MIX AVAILABLE FROM NEW ENGLAND WETLAND PLANTS, INC.

16) FOLLOWING BROADCAST SEEDING, CONTRACTOR SHALL TOP DRESS THE RESTORATION AREA WITH A THIN UNIFORM LAYER OF WEED FREE STRAW MULCH. STRAW MULCH WILL PROVIDE SOME TEMPORARY GROUND STABILIZATION AND RETAIN MOISTURE TO AID IN SEED GERMINATION.

(50' WIDE - PUBLIC)

CONC

DRIVEWAY

DRIVE

280.75' S77'59'20"E

BUFFER ZONE -

RESTORATION

AREA

187.32' N71'39'20"W

JOHN & CARRIE E. BENNETT

DEED BOOK 53685, PAGE 423

LINE OF

SEDIMENT

CONTROL

PREVIOUS

LEGEND 3"-4" REMAINS EXPOSED INSTALL STAKE PERPENDICULAR TO ----- SURFACE CONTOUR SLOPE FACE EVERY 10' EDGE OF PAVEMENT (MIN.). 12" MIN. OVERLAP 12" MIN. DIA. FILTER SOCK IN BÉTWEEN PIECES OF EDGE OF LAWN SET IN A 2"-3" DEEP FILTER SOCK. TRENCH-EDGE OF WOODED AREA EXISTING UTILITY POLE WITH DESIGNATION & OVERHEAD WIRES LIMIT OF BORDERING VEGETATED WETLAND WITH FLAG NUMBER LIMIT OF 100-FOOT WETLAND BUFFER ZONE WATTLE EROSION CONTROL LINE □ CBDH DRILL HOLE IN CONCRETE BOUND BITUMINOUS 12"± CONC CONCRETE RET RETAINING INSTALL WITH 18" EXISTING EX

NOTES:

1. SOCK SIZE DEPICTED IS FOR GENERAL USE. GREATER

- 2. COMPOST MATERIAL MAY BE DISPERSED ON SITE AT THE DISCRETION OF THE APPROVING AUTHORITY
- PRIOR TO SETTING THE SOCK REMOVE LOOSE LITTER, BRANCHES AND OTHER MATERIAL THAT MAY PREVENT THE SOCK FROM DIRECT CONTACT WITH SOIL.



OR 24", 1"X1" WOOD STAKES

-DRIVE STAKE UNTIL

CONSTRUCTION

SITE ADDRESS:

PREPARED FOR:

80 Central Street Saugus, Massachusetts 01906

WOODMERE

DRIVE

Sudbury, Massachusetts 01776

RICE


HANCOCK ASSOCIATES

Civil Engineers

Land Surveyors

Environmental Consultants

315 Elm Street, Marlborough, MA 01752 Voice (508) 460-1111, Fax (508) 460-1121 www.hancockassociates.com

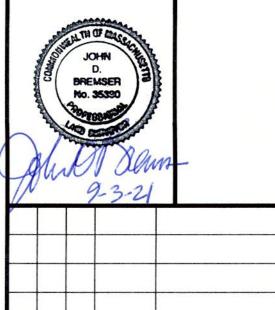

2 LMT JDB | 9/3/21 | REVISE SEDIMENT CONTROL JTL JDB 8/18/21 ADD DEWATERING INFORMATIO

NO. BY APP DATE ISSUE/REVISION DESCRIPTION

8/2/21 DRAWN BY 1" = 20' CHECK BY:

PROPOSED PLOT PLAN


PLOT DATE: Sep 03, 2021 8:48 am DWG: 25132-noi.dwg

SCALE: 1" = 20'

40

PPP LAYOUT: PPP (NOI) SHEET: 1 OF 1

25132 PROJECT NO .:

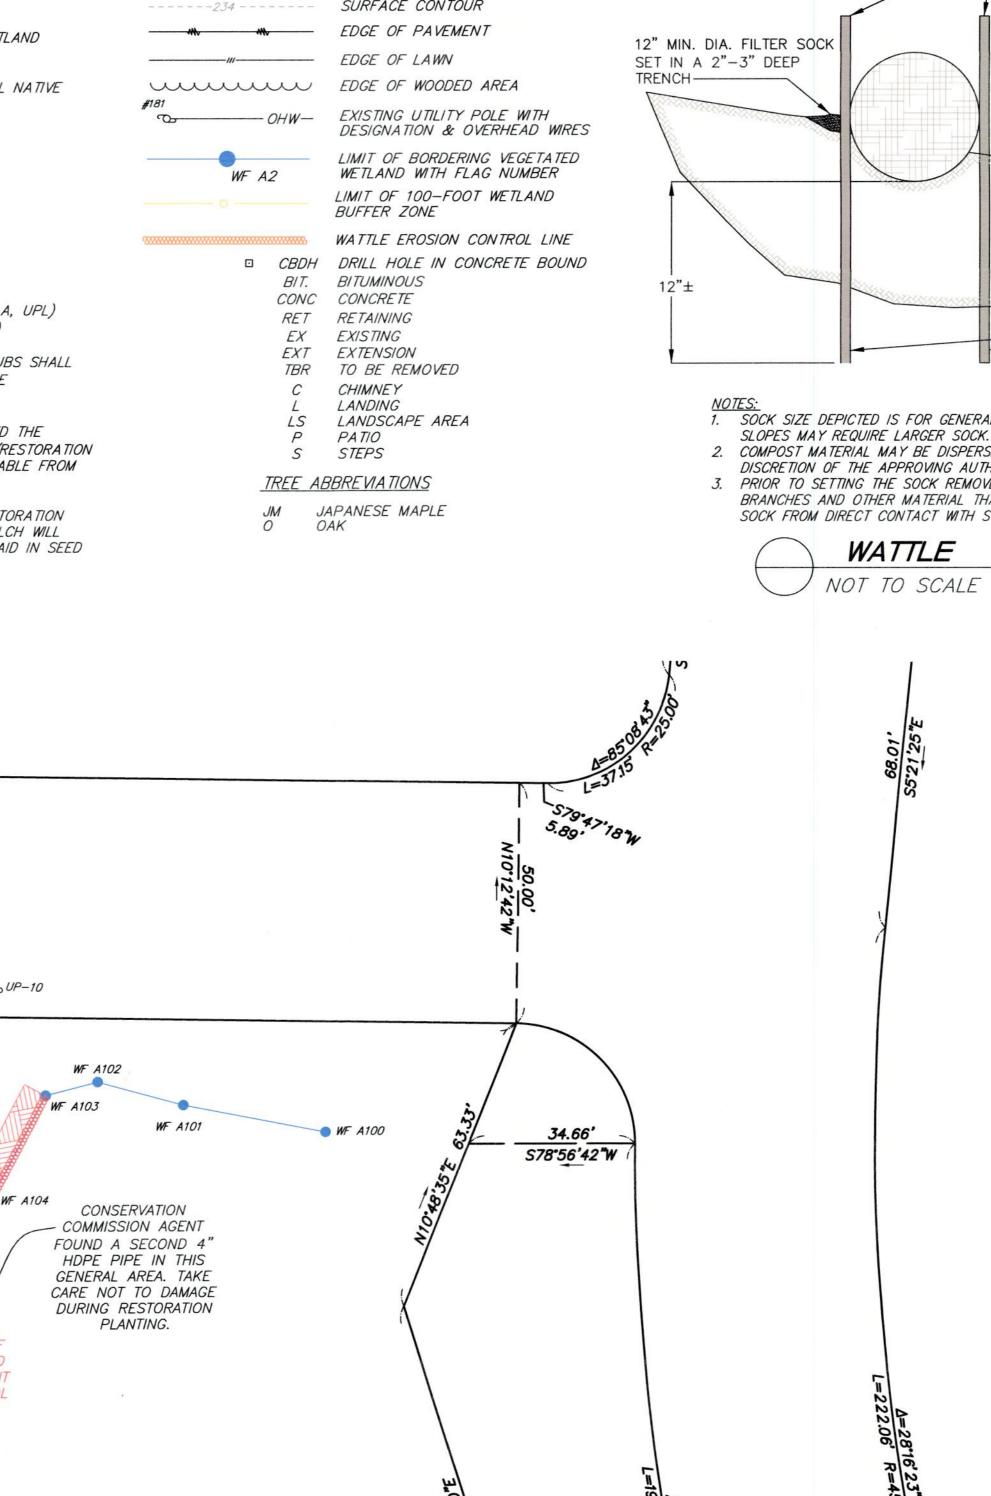


2 STORY WOOD FRAME **DWELLING** REVISED SEDIMENT CONTROL PLANTING TIMBER WALL TAKE CARE NOT TO
DAMAGE PIPE DURING
RESTORATION PLANTING.

PLAN VIEW **DEWATERING BASIN** NOT TO SCALE WF A113

A	ELEVATION BENCH MARKS DATUM: ASSUMED	
NO.	DESCRIPTION	ELEV.
1.	CUT SPK IN U.POLE #9	102.46
2.	CUT SPK IN 18" OAK	100.95

-STRAW OR HAY BALES ANCHORED TOGETHER SNUGLY

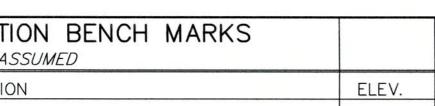

-FILL WITH 3 INCHES OF CRUSHED STONE AND PLACE 4'X6' DIRTBAG® DEWATERING BAG ON